

# Review of Environmental Factors Minor Works

Bob Prenter Reserve Amenities Building

Project Manager	Andrew Russell
Position	Project Manager, Arenco (NSW) Pty Ltd
Contact Details	0428 350 019 andrew.russell@arenco.com.au
Capital Investment Cost	\$7 million
Proposed commencement date	6 January 2025
Proposed completion date	10 November 2025

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This Review of Environmental Factors (REF) is valid for two (2) years from the date of project sign-off.				



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# **1. Introduction**

The environmental assessment and determination of the proposal has been undertaken in accordance with Part 5 of the *Environmental Planning and Assessment Act 1979* (EP&A Act). For this proposal, **Campbelltown City Council** is both a public authority proponent (EP&A Act s5.3) and the determining authority (EP&A Act s5.1). The REF has been prepared in accordance with Clause 171 of the EP&A Regulation (2021). Table 1 below outlines the proponent contact details.

#### Table 1: Proponent details

Contact name	Andrew Russell
Position	Project Manager Arenco (NSW) Pty Ltd
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## 1.1. Project Description and Background

#### 1.1.1. Detailed Scope of Works

The proposed scope of works is as follows:

Demolition	<ul> <li>Demolition of existing amenities building</li> <li>Demolition of existing building below grandstand and retention of existing grandstand</li> <li>Demolition of existing irrigation tanks</li> </ul>
New amenities buildings at the reserve including:	- New two storey amenities building including canteen, store rooms, services rooms, players change rooms, accessible WCs, lift, venue management office, clubroom, kitchen, bar and external viewing area
	- New building under grandstand including umpire briefing rooms, WCs, gym/walkthrough, male and female toilets and cleaners room
Landscaping consisting of:	- Planting of trees between two proposed buildings and new turfing of disturbed areas
Other infrastructure	- Canopy over proposed BBQ area, new bench seating, new dugout shelters, new bin enclosure, new fire hydrant pump



	enclosure, relocation of flag poles
New concrete footpaths	- New footpaths/paving will be constructed around the new buildings
Clearing of Vegetation	- No trees are to be removed

Pre-construction Activities include undertaking Land Surveying and geotechnical report.

Construction Activities will include setting up erosion control measures and the construction of the proposed buildings.

Future Works may include the construction of provisional items and undertaking weed management, and general maintenance activities such as mowing.

### 1.1.2. Machinery and Equipment

- Excavator / Drill Rig for Geotechnical Works.
- Backhoe / Excavator for earthworks and the construction of footings
- Concrete Truck for concrete delivery.
- Tipper Truck for construction works.
- Petrol Driven Small Plant such as augers.
- Mobile cranes for structural steel installation as well as elevated working platforms for height access works
- Manual Tools chain saws, survey tools, digging and concreting equipment.

#### 1.1.3. Access and Ancillary Works

Access will be via Fields Road with machinery, materials, and the site compound erected on the hard stand areas (existing carpark) or the turfed area (west of the carpark) in the reserve. All access and ancillary works including stockpiles will be included in the construction environmental management plan and erosion and sediment control will be in accordance with the "Blue Book" published by Landcom (2004).

#### 1.1.4. Duration and Working Hours

The works are short term, as outlined in Table 2.

Commencement Date	6 January 2025
Completion Date	10 November 2025
Work Duration	45 weeks
Work Hours	Monday – Friday 7:00am to 6:00pm Saturday 8:00am to 1:00pm Sunday and Public Holidays No work

#### Table 2: Project timeframes



	Work outside these hours requires approval from Council. There may be some instances (usually with external utilities) that some work may be completed outside these hours
	be completed outside these nours

## **1.2. Project Location and Context**

## 1.2.1. Location of the Proposed Activity

The site is located approximately 9km northeast of Campbelltown CBD.

Location of activity/ development	Bob Prenter Reserve, Fields Road Macquarie Fields
	The site is legally known as:
	Lot 31 DP557150
	Lot 32 DP557150
	- 33.997002 150.881280

See Figures 1 and 2 in Appendix A.



#### 1.2.2. Site Context

The project site is a public reserve that is used mainly for the purposes of Australian Rules Football, Gaelic Football and Athletics.

The area of the site where the works are proposed contains a grandstand, with a detached building underneath and a separate single storey amenities building, with paved areas and associated works.

#### 1.2.3. Land-use and Ownership

The land is zoned as RE1 Public Open Space under the Campbelltown Local Environmental Plan 2015 (*Refer to Figure 3: Land Use at the Project Site and surrounds*)



Figure 3: Land Use at the Project Site and surrounds

The Reserve consists of Lot 31 DP557150 and Lot 32 DP557150 which are owned by Campbelltown City Council.



#### 1.2.4. Landform, geology, and soils

A majority of the site consists of playing fields, with other associated landscaped areas and associated buildings. The area of the site where works are proposed already contains buildings. The area of the works zone is classified as shale, based on a Geotechnical Report prepared by Rapid Geo dated 24/9/2024.



Figure 4: Geology (Rapid Geo)



### 1.2.5. Contaminated Land and Acid Sulfate Soils

The Site is not listed with the Environmental Protection Agency (EPA) as being a 'contaminated site' or as being potentially contaminated.

The site is not subject to any active licences issues under the Protection of the Environment Operations Act 1997 (POEO).

The site is not known to contain Acid Sulfate Soils.

### 1.2.6. Water quality and hydrology

The site drains to various surrounding streets. There are no significant watercourses passing through the site. Additional hardstand to be constructed as part of the development will drain to the surrounding drainage system.

The site is not known to be flood prone.

### 1.2.7. Biodiversity – Flora and Fauna

The area of the site where the development is proposed is not mapped as subject to biodiversity or koala habitat.

### 1.2.8. Aboriginal Heritage

The site not known to be affected by Aboriginal Heritage. A search of the Aboriginal Heritage Information Management System was made on 26 November 2024. The search revealed that there are no aboriginal heritage items on the site.

### 1.2.9. Non-Aboriginal Heritage

The site is in not subject to any heritage listings on the NSW Heritage register or in the Campbelltown LEP 2015.

## **1.3. Project Justification and Consideration of Alternatives**

It would be possible not to proceed with the works and leave the site as-is, however the existing amenities buildings are inadequate and reaching the end of their life. This would lead to a diminished experience for users of the reserve including AFL clubs, Gaelic football and little athletics.

Other locations of the site are less suitable for the proposed buildings, as they are less flat, requiring more earthworks, further away from the street, contain existing trees, car parking or playing areas and would create more disturbance during construction.

The works are intended to improve the amenity of the existing reserve for sports participants and spectators. Accordingly, it is beneficial for the activity to proceed.



## 2. Statutory and Planning Framework

### 2.1. Environmental Planning and Assessment Act 1979

The *Environmental Planning and Assessment Act 1979* (EP&A Act) and the Environmental Planning and Assessment Regulation 2021 (EP&A Regulation) provide the framework for development and environmental assessment in NSW.

As Council is the proponent, the works have been assessed as 'development permissible without consent' under Part 5 of the EP&A Act. Therefore, the activity has been assessed in accordance with Sections 5.5, 5.6 and 5.7 of that Act by examining and fully considering possible all matters which are likely to affect the environment. Environmental Planning Instruments made under the EP&A Act 1979 may also be relevant and are addressed below.

## 2.2. State Environmental Planning Policy (Transport and Infrastructure) 2021

State Environmental Planning Policy (Transport and Infrastructure) 2021 (Transport and Infrastructure SEPP) aims to facilitate the effective delivery of infrastructure across the State.

In accordance with section 2.73 of the Transport and Infrastructure SEPP, the following works are permitted without consent when carried out by a council on a public reserve under the control of or vested in the council.

(i) roads, pedestrian pathways, cycleways, single storey car parks, ticketing facilities, viewing platforms and pedestrian bridges,

(ii) recreation areas and recreation facilities (outdoor), but not including grandstands,

(iii) visitor information centres, information boards and other information facilities,

(iv) lighting, if light spill and artificial sky glow is minimised in accordance with the Lighting for Roads and Public Spaces Standard,

(v) landscaping, including landscape structures or features (such as art work) and irrigation systems,

(vi) amenities for people using the reserve, including toilets and change rooms,

(vii) food preparation and related facilities for people using the reserve,

- (viii) maintenance depots,
- (ix) portable lifeguard towers,



(b) environmental management works,

(c) demolition of buildings (other than any building that is, or is part of, a State or local heritage item or is within a heritage conservation area).

This activity can be carried out without consent and be assessed under Division 5.1 of the *Environmental Planning and Assessment Act 1979*.

Pedestrian facilities, including kerb adjustments and ramps, are exempt development under section 2.113(1)(a)(iv) of the SEPP in relation to roads and road infrastructure facilities, although the proposal is not a road or road infrastructure facility.

## 2.3. Other Environmental Legislation

Table 3 outlines how the project has been considered under other relevant Commonwealth and State environmental legislation.



## Table 3: Other environmental legislation

Legislation	Relevance to the Proposed Activity	
COMMONWEALTH LEGISLATION		
Environmental Protection and Biodiversity Conservation Act	The EPBC Act protects matters of <u>National Environmental Significance</u> (NES), such as threatened species and ecological communities, migratory species (protected under international agreements), and National Heritage places (among others).	
<i>1999</i> (EPBC Act)	Matters of NES have not been identified on the site. A significant impact is not likely to result and therefore a referral to the Commonwealth Department of Environment is not required.	
STATE LEGISLATION		
<i>Biodiversity Conservation Act 2016</i> (BC Act)	Part 7 of the BC Act provides the environmental assessment requirements for activities being assessed under Part 5 of the EP&A Act 1979. If a significant impact is likely, a Species Impact Statement is required. A biodiversity development assessment report may also be required if the proponent elects for this. Section 7.2(1)(a) and 7.3 describe the assessment requirements and thresholds for what is considered a significant impact.	
	Threatened species and communities listed under this Act were not identified as potentially being impacted by the works and therefore a Species Impact Statement or Biodiversity Development Assessment Report is not required.	
Local Land Services Act 2013 (LLS Act)	The objects of the LLS Act include 'to ensure the proper management of natural resources in the social, economic, and environmental interests of the State, consistently with the principles of ecologically sustainable development. The Act regulates the clearing of native vegetation; however, section 60(O)(b)(ii) excludes the need for consent under the LLS Act where the clearing is an activity carried out by a determining authority within the meaning of Part 5 of the EP&A Act 1979.	
Fisheries Management Act 1994 (FM Act)	FM Act provides for the protection, conservation, and recovery of threatened species, populations and ecological communities of fish and marine vegetation and fish habitats, as well as promoting the development and sharing of fishery resources in NSW.	
	The development will have no impact on fisheries and accordingly this Act is not applicable.	
National Parks and Wildlife Act 1974	The NPW Act regulates the control and management of all national parks, historic sites, nature reserves, and Aboriginal areas.	
(NPW Act)	The main aim of the Act is to conserve the natural and cultural heritage of NSW. Where works will disturb Aboriginal objects, an Aboriginal Heritage Impact Permit (AHIP) is required.	
	A search of the NSW AHIMS database was made on 26 November 2024 which revealed that there are no aboriginal heritage items on the site.	

	CAMPBELLTOWN City Council
	The proposed activity is unlikely to harm Aboriginal objects and therefore a permit under the NP&W Act is not required. The proposed activity is of low impact according to the Due Diligence Code of Practice for the Protection of Aboriginal Objects in NSW (DECCW 2010).
Heritage Act 1977	The proposed activity <b>does not involve</b> an item or place listed on the NSW <u>State Heritage Register</u> or the subject of an interim heritage order or listing and is therefore not a controlled activity. Approval of works on the site is therefore <b>not required</b> under Part 4 of the Heritage Act.
Protection of the Environment Operations Act 1997 (POEO Act)	The POEO Act is the key environmental protection and pollution statute. The POEO Act is administered by the EPA (Environmental Protection Authority) and establishes a licensing regime for waste, air, water, and pollution. Relevant sections of the Act are listed below:
	Part 5.3 Water Pollution
	<ul> <li>Part 5.4 Air Pollution</li> <li>Part 5.5 Noise Pollution</li> </ul>
	<ul> <li>Part 5.6 Land Pollution and Waste</li> </ul>
	Any work potentially resulting in pollution must comply with the POEO Act. Relevant licences must be obtained if required. Check the <u>POEO Public</u> <u>Register</u> for any relevant Environment Protection Licences (EPLs).
	No licences have been identified as being required including an Environmental Protection Licence (EPL).
Water Management Act 2000 (WM Act)	The WM Act's main objective is to manage NSW water in a sustainable and integrated manner that will benefit today's generations without compromising future generations' ability to meet their needs. Section 91E of the Act establishes an approval regime for controlled activities within waterfront land. However, clause 41 of the Water Management (General) Regulation 2018 provides an exemption for public authorities in relation to all controlled activities on waterfront land. Therefore, approval under the WM Act is not required.
	The proposed development is not within 40m of a watercourse.
Roads Act 1993	Section 88 of the <i>Roads Act</i> states that a roads authority may, despite any other Act or law to the contrary, remove or lop any tree or other vegetation that is on or overhanging a public road if, in its opinion it is necessary to do so for the purposes of carrying out road work or removing a traffic hazard. However, the environmental safeguards outlined in this REF still apply. No work is proposed within the public road.
Biosecurity Act 2015	The <i>Biosecurity Act 2015</i> and regulations provide requirements for state level priority weeds. The Act regulates all plants, with a general biosecurity duty to prevent, eliminate or minimise any biosecurity risk they may pose. This legislation is considered in Section 4.
	The proposed development is located on an existing developed site and there will be no impact on weeds.
State	The <i>State Environmental Planning Policy (Coastal Management) 2018</i> provides controls for undertaking development and activities in coastal management



Environmental Planning Policy – Coastal Management 2018	<ul> <li>areas. The four coastal management areas are:</li> <li>Coastal wetlands and littoral rainforests area – areas which display the characteristics of coastal wetlands or littoral rainforests that were previously protected by SEPP 14 and SEPP 26</li> <li>Coastal vulnerability area – areas subject to coastal hazards such as coastal erosion and tidal inundation</li> <li>Coastal environment area – areas that are characterised by natural coastal features such as beaches, rock platforms, coastal lakes and lagoons and undeveloped headlands. Marine and estuarine waters are also included</li> <li>Coastal use area – land adjacent to coastal waters, estuaries and coastal lakes and lagoons.</li> <li>Under clause 10 of the SEPP, clearing native vegetation in the mapped 'Coastal wetland and littoral rainforest area' is permissible without consent when undertaken by or on behalf of a public authority and in accordance with a certified coastal management program, a plan of management under Division 2 of Part 2 of Chapter 6 of the <i>Local Government Act</i>, or a plan of management under Division 6 of the <i>Crown Land Management Act 2016</i>. In other cases, the clearing requires consent.</li> </ul>
State Environmental Planning Policy Vegetation in Non- Rural Areas 2017	Clause 8 of the SEPP states that an authority to clear vegetation under this policy is not required if it is a clearing authorised under s60(O) of the Local Land Services Act 2013. Section 60(O) provides an exemption for clearing under Part 5 of the EP&A Act and therefore consent is not required under the SEPP (Vegetation in Non-Rural Areas).
State Environmental Planning Policy (Koala Habitat Protection) 2019	Koala Habitat Protection SEPP aims to encourage the proper conservation and management of areas of natural vegetation that provide habitat for <i>Phascolarctos cinereus</i> (Koala) to ensure a permanent free-living population over their present range and reverse the current trend of Koala population decline. Koala Habitat Protection SEPP applies to development under part 4 of the EP&A Act 1979. As the proposed activity is not 'development,' Koala Habitat Protection SEPP does not apply. Regardless, consideration of impacts to koala and koala habitat may still be relevant under the BC Act 2016. The proposal development will result in no removal of trees or impact on koala habitat.
State Environmental Planning Policy (Resiliance and Hazards) 2021	Chapter 4 of the SEPP provides a planning framework for the remediation of contaminated land. The existing reserve is not known to be contaminated.
State Environmental	The SEPP contains controls with respect to the Georges River and ensuring that:

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Planning Policy (Biodiversity and	(a) the effect on the quality of water entering a natural waterbody will be as close as possible to neutral or beneficial, and
Conservation) 2021	(b) the impact on water flow in a natural waterbody will be minimised.
	The proposed development will have minimal impact on stormwater, as it is located on an existing developed part of the site and stormwater will drain to the same infrastructure as existing. Soil and erosion control measures will be implemented during construction and all disturbed areas will be planted/seeded post-construction.
Campbelltown	The site is zoned RE1 Public Recreation under the LEP.
Local Environmental Plan 2015	The proposed activity is consistent with the objectives of the zone, as it will improve the recreational use of the subject land and facilitate development that is ancillary or incidental.
	Community facilites, recreational facilities, restaurants or cafes and small bars are permitted under the zoning.
	Clause 7.17 of the LEP provides that development consent must not be granted to the carrying out of development on land in Zone RE1 Public Recreation if that land is owned or controlled, or is proposed to be owned or controlled, by the Council unless the consent authority has considered the following—
	<ul><li>(a) the need for the development of the land,</li><li>(b) the impact of the development on the existing or likely future use of the land, and prevailing natural systems,</li></ul>
	(c) the need to retain the land for its existing or likely future use.
	Council has considered the above criteria and there is an indentified need to improve the use of Bob Prenter reserve for it's users. The buildings are located to match existing, meaning there will be no negative impact on the land and it can be retained for future recreational purposes.



# 3. Community and Agency Consultation

Table 4: Community and Agency Consultation

Is consultation with other authorities required under the requirements of Clauses 2.10-2.15 of the Transport and Infrastructure SEPP? Yes □ No ⊠
Are the works adjacent to a <u>national park, nature reserve or other area</u> reserved under the <i>National Parks and Wildlife Act 1974</i> ? Yes 🗆 No 🗵
Are the works adjacent to a declared <u>aquatic reserve</u> under the <i>Fisheries Management Act 1994</i> ? Yes  No  X
<b>Other agency and community consultation:</b> Campbelltown City Council has performed it's own stakeholder consultation with the primary users of the reserve.



## 4. Environmental Assessment

This section describes in detail the potential key environmental impacts associated with the proposal during both construction and operation and includes identifying site-specific safeguards to ameliorate the identified potential impacts.

Issue	Description
Landform, geology, and soils	Does the project involve the disturbance of large areas (e.g., >2ha) for earthworks? Yes □ No ⊠
	Does the site have constraints for erosion and sedimentation controls such as steep gradients, narrow corridors or is located on private property? Yes 🗆 No 🗵
	Are there any sensitive receiving environments that are in or nearby the project footprint or that would receive stormwater discharge from the project?
	Sensitive receiving environments include (but are not limited to) wetlands, state forests, national parks, nature reserves, rainforests, drinking water catchments). Yes □ No ⊠
Potential Impacts	• Any disturbance of groundcover presents a potential risk for erosion, this risk can be minimised through implementation of the following safeguards.
Safeguards	<ul> <li><u>Erosion and Sedimentation</u></li> <li>Site management will incorporate best management erosion and sediment control practices such as those found in the Landcom's "Blue Book (4th Edition) on erosion and sediment control.</li> <li>Construct temporary drainage structures in accordance with the 'Technical Guideline - Temporary Stormwater Drainage for Road Construction' (RMS 2011)</li> <li>Linear silt stop fencing to be installed down slope of all affected areas and stockpiles. Silt fencing will be installed before excavation begins.</li> <li>Sandbags, hay bales wrapped in geotextile fabric etc. will be used to slow water flow and trap sediment. No straw bales are to be used.</li> <li>Overburden will be placed in the form of a bund upslope of the site where necessary to reduce surface water entering the site.</li> <li>All erosion and silt control devices will be visually inspected weekly to ensure effectiveness as well as after each rainfall event.</li> <li>Stockpile Management</li> <li>Stockpiles will be designed, established, operated, and decommissioned in accordance with the RMS Stockpile Site</li> </ul>



Management Guidelines 2015.
Soil Stabilisation and Restoration
• The rehabilitation of disturbed areas will be carried out progressively as
construction stages are completed, and in accordance with:
<ul> <li>Landcom's "Blue Book (4th Edition) on sediment and erosion control</li> </ul>
<u>RMS Landscape Guidelines</u>
<u>RMS Guidelines for Batter Stabilisation Using Vegetation</u>



Contaminated Land and Acid Sulfate Soils	Is the project located within an area mapped as Potential Acid Sulfate Soils? Yes $\Box$ No $\boxtimes$
	Are there any known occurrences of acid sulfate soils in the area? Yes □ No ⊠
	Is the project located within an area mapped as Potential Contaminated Land? Yes $\Box~$ No $\boxtimes~$
Potential Impacts	<ul> <li>The disturbance of acid sulfate soils can generate large amounts of sulfuric acid leachate which can impact on the surrounding environment.</li> <li>Potential impacts include water quality impacts and impacts on flora and fauna.</li> </ul>
Safeguards	An Acid Sulfate Management Plan will be prepared if required.
	<ul> <li><u>Contaminates Land</u></li> <li>If contaminated areas are encountered during construction, appropriate control measures will be implemented to manage the immediate risks of contamination. All other works that may impact on the contaminated area will cease until the nature and extent of the contamination has been confirmed and any necessary site-specific controls or further actions identified in consultation with relevant government agencies.</li> <li><u>Acid Sulfate Soils</u></li> <li>If Acid Sulfate Soils will or may be disturbed an Acid Sulfate Soils Management Plan is required as part of the CEMP.</li> </ul>
Water quality and hydrology	Are the works located within or adjacent to a waterbody or wetland, or within 40m of a waterway? Yes □ No ⊠
	If yes, the NSW DPI Water or DPI Fisheries should be notified. Have they been notified?         Yes □ No ⊠         Will the proposed works be undertaken on a bridge?         Yes □ No ⊠



	Is the location known to flood or be prone to water logging?	
	Yes 🗆 No 🗵	
	The site is not known to be flood prone.	
Potential Impacts	Does the project pose any potential risk to the surrounding water quality?	
	Yes 🗵 No 🗆	
	Construction works will cause soil disturbances during the construction of the proposed new buildings. All works to be in accordance with prepared construction environmental management plan. Soil and erosion control measures in accordance with the "Blue Book" published by Landcom, 2004 will be implemented during construction to minimise impact.	
Safeguards	Water quality	
	<ul> <li>Water quality</li> <li>Visual monitoring of local water quality (i.e., turbidity, hydrocarbon spills/slicks) is to be undertaken on a regular basis to identify any potential spills or deficient erosion and sediment controls.</li> <li>Water quality control measures are to be used to prevent any materials (e.g., concrete, grout, sediment etc) entering drain inlets or waterways.</li> <li>Wash down should use potable water and excess debris removed using hand tools. Wash down waste must be filtered before release, and away from all waterways.</li> <li>No dirty water may be released into drainage lines and/or waterways.</li> <li>Prevent sediment moving off-site and sediment laden water entering any water course, drainage lines, or drain inlets.</li> <li>Reduce water velocity and capture sediment on site.</li> <li>Minimise the amount of material transported from site to surrounding pavement surfaces.</li> <li>Divert clean water around the site.</li> </ul>	
	<ul> <li>Water pollution</li> <li>Store fuels, chemical and hazardous materials in secure, bunded areas within temporary construction ancillary facilities, and at least 50m from all waterways.</li> <li>Capture and dispose of spill and contaminated materials from temporary construction ancillary facilities at a licensed facility.</li> <li>Provide spill kits around temporary construction ancillary facilities.</li> <li>Measures to control pollutants from stormwater and spills will be investigated and incorporated in the pavement drainage system at locations where it discharges to the receiving drainage lines. Measures aimed at reducing flow rates during rain events and potential scour will also be incorporated in the design of the pavement drainage system.</li> </ul>	
Biodiversity – Flora and Fauna	<ul> <li>Have relevant database searches been carried out?</li> <li>NSW Bionet</li> <li>Threatened species profile search (www.environment.nsw.gov.au/threatenedspeciesapp/)</li> <li>Commonwealth EPBC</li> </ul>	



• Fisheries?	
Yes 🗵 No 🗆	
Date searches undertaken: 27 November 2024	
A search of the NSW Environment and Heritage database revealed a total o 223 items for the Cumberland IBRA sub region. No flora is proposed to be removed as part of the development and no fauna habitat was identified or the site.	
Are the proposed works likely to impact on any vegetation including, shrub trees? Yes □ No ⊠	s,
Did the database searches identify any endangered ecological communities populations, threatened flora and/or threatened or protected fauna, or migratory species within the vicinity of the proposed works? Both Federal a State listed matters must be considered.	
Yes 🗵 No 🗆	
A search of relevant NSW Environment and Heritage databases reveals that there are threatened species listed for the Western Sydney/Cumberland County region. There are no trees to be removed, meaning that there is no impact on threatened flora. Similarly, no fauna habitat was identified on the site.	
Are the works taking place in a roadside area designated as high conservat value vegetation?	ion
Yes □ No ⊠	
	—
Will the proposed works require the removal of any other vegetation? Yes $\Box$ No $\boxtimes$	
The proposed works are located on an existing developed part of the site a will not require the removal of trees.	nd
Do the proposed works involve pruning, trimming or removal of any tree/s Yes 🗆 No 🗵	?
No tree removal is proposed.	
No tree removal is proposed.	
Will the proposed works affect any tree hollows or hollow logs?	



	Yes □ No ⊠
	Will the proposed works disturb any crevices or other locations (such as on bridges and culverts) for potential bat habitat? Yes 🗆 No 🗵
	Are there any known areas of Areas of Outstanding Biodiversity Value (formerly known as critical habitat), Directory of Important Wetlands in Australia within the vicinity of the proposed works? Yes 🗆 No 🗵
	Will the proposed works disturb any natural waterways or aquatic habitat? Yes 🗆 No 🗵
	The proposed works are not in proximity to any waterway.
	Do the trees form part of a streetscape, an avenue or roadside planting? Yes □ No ⊠
	Have the trees been planted by a community group, Landcare group or by council or is the tree a memorial or part of a memorial group e.g., has a plaque? Yes 🗆 No 🗵
	Do the trees form part of a heritage listing or have other heritage value? Yes 🗆 No 🗵
	Are there any significant weeds present? Yes □ No ⊠ The proposed buildings are located on an existing developed part of the site.
Potential Impacts	Does the project pose any potential risk to the biodiversity within the vicinity of
	the site? Yes □ No ⊠
Safeguards	General

	CAMPBELLTOW City Council
	Establish tree protection zones for trees to be retained in proximity to the construction works
	• Should unexpected, threatened fauna be located at any time during construction, cease work immediately in the area to prevent further harm to the individual. Contact Council's Environmental Officer and a suitably qualified ecologist to determine if further assessment or management plans are required.
	Invasion of Exotic Species:
	<ul> <li>Manage vegetation within the road reserve and adjacent to areas of vegetation clearing in accordance with Guide 6 Weed Management and Guide 10 Aquatic Habitats and Riparian Zones of Roads and Maritime's Biodiversity Guidelines (RTA, 2011) to reduce invasion of noxious weed species.</li> </ul>
	• Use weed-free topsoil in landscaping and revegetate disturbed sites with locally indigenous species.
	• Construction machinery should be washed prior to entering and leaving site to ensure weed propagules are not transported.
	Stockpiling:
	• Only place stockpiles in low value vegetation, where cleared sites are unavailable.
	• Stockpiles should be no taller than 2m height.
	• Use existing stockpiles before creating new ones.
	Site Restoration:
	The rehabilitation of disturbed areas will be carried out progressively a construction stages are completed, and in accordance with:
	• Landcom's "Blue Book (4th Edition) on sediment and erosion control.
	RMS Landscape Guidelines.
	• RMS Guidelines for Batter Stabilisation Using Vegetation.
Aboriginal	Are the works likely to disturb previously undisturbed areas of the landscape?
Heritage	Yes 🗆 No 🗵
	The works are located on an existing developed part of the site.
	Has an AHIMS register search been conducted? Yes ⊠ No □
	The AHIMS register search showed no Aboriginal sites recorded in or near the site and no Aboriginal places have been declared in or near the site. A copy of the search is included in Appendix C.



	Are there any known Aboriginal artefacts/sites within the vicinity of the work site? Yes 🗆 No 🗵	
	Would the proposal involve the removal of mature native trees? Yes □ No ⊠ No vegetation removal is proposed.	
Potential Impacts	Does the project pose any potential risk to Aboriginal heritage? Yes 🗆 No 🗵	
Safeguards	<ul> <li><u>Unexpected Finds</u></li> <li>If Aboriginal heritage items are uncovered during the works, all works in the vicinity of the find must cease and the Project Manager contacted immediately, and the Standard Management Procedure - Unexpected Heritage Items (RMS, 2015) will be followed.</li> </ul>	
Non-Aboriginal Heritage	<ul> <li>Complete online heritage database searches</li> <li>NSW Heritage database</li> <li>Commonwealth EPBC heritage list</li> <li>Australian Heritage Places Inventory</li> <li>Local Environmental Plan(s) heritage items</li> <li>Are there any items of non-Aboriginal heritage located within the vicinity of the</li> </ul>	
	proposed works? Yes □ No ⊠	
Potential Impacts	Does the project pose any potential risk to non-Aboriginal heritage? Yes $\Box$ No $\boxtimes$	
Safeguards	<ul> <li><u>Unexpected Finds</u></li> <li>If heritage items are uncovered during the works, all works in the vicinity of the find must cease and the Project Manager contacted immediately, and the Standard Management Procedure - Unexpected Heritage Items (RMS, 2015) will be followed.</li> </ul>	
Noise	<ul> <li>Are there any noise sensitive areas near the location of the proposed works that may be affected by the works (i.e., church, school, hospital, residences)?</li> <li>During construction?</li> <li>Yes ⊠ No □</li> <li>The nearest residences are over 200m from the site. Macquarie Fields public school is approximately 125m from the site.</li> <li>During Operation?</li> <li>Yes ⊠ No □</li> </ul>	



		from the site. Macquarie Fields public e site. The buildings will largely be used
	Are the proposed works going to be un hours detailed below? Yes ⊠ No □	ndertaken during standard working
	<u>Standard working hours</u>	
	Monday – Friday	7:00am to 6:00pm
	Saturday	, 8:00am to 1:00pm
	Sunday and Public Holidays	No work
		proval from Council. There may be some
	Would operation of the proposal alter receivers? This might include, but not l an existing carriageway, changing traf more than 10km/hr, or installing audio	be limited to, altering the line or level of fic flow, increasing traffic speeds by
	Yes 🗆 No 🗵	
Potential Impacts	Does the project pose any potential ris	sk to the surrounding noise quality?
	Yes $\square$ No $\boxtimes$	
Safeguards	will be notified at least five wor associated with the activity tha impact. <u>Standard Hours of Operation</u>	idents and school) likely to be affected rking days prior to the start of any works It may have an adverse noise or vibration
	Monday to Friday; 8am to 1pm outside normal work hours or	normal work hours (i.e., 7am to 6pm Saturdays). Any work that is performed on Sundays or public holidays may not , works are to minimise noise impacts.
	<ul> <li>Out of hours</li> <li>Where out-of-hours activities a Council's requirements and ap</li> </ul>	are required, this will be subject to proval.
Air quality	Are the proposed works likely to result Yes □ No ⊠	t in large areas (>2ha) of exposed soils?
	Are there any dust sensitive receivers proposed works during the construction residences)?	located within the vicinity of the on period (i.e., church, school, hospital,



	Yes ⊠ No □
	Nearest residences are greater than 200m from the site. The school is within 125m of the site. Dust will be managed in accordance with the Blue Book and Construction Environmental Management Plan. The school will be consulted for any works that may impact the school operations and access to the oval.
	Is there likely to be an emission to air of dust, smoke, steam, or vehicle emissions?
	Yes 🗆 No 🗵
Potential Impacts	Does the project pose any potential risk to the surrounding air quality? Yes $\Box$ No $\boxtimes$
Safeguards	<ul> <li>Measures to minimise or prevent air pollution or dust are to be used including watering or covering exposed areas.</li> <li>Works are not to be carried out during strong winds or in weather conditions where high levels of dust or air borne particulates are likely.</li> </ul>
	• Vegetation or other materials are not to be burnt on site.
	• Vehicles and vessels transporting waste or other materials that may produce odours or dust are to be covered during transportation.
	• Vehicles and equipment are to be maintained in good working order.
	• Monitor work areas and stockpiles for dust generation and seed/cover/spray to suppress.
	• Measures (including watering or covering exposed areas) are to be used to minimise or prevent air pollution and dust.
	Do not leave vehicles idling.
Waste and Chemical Management	Are the proposed works likely to generate >200 tonnes of waste material (contaminated and /or non-contaminated material)? Yes □ No ⊠
	Are the proposed works likely to require a <u>licence from EPA</u> ? Yes □ No ⊠
	Is waste being transported off site to another location? Yes ⊠ No □
	Does the project pose any potential risk to the surrounding environment because of waste generated?



	Yes 🗆 No 🗵
Potential Impacts	It is anticipated that small amounts of waste will be generated as part of the proposed works. All waste generated will be disposed of at a registered waste facility.
Safeguards	<ul> <li>A Waste Management Plan will be prepared as part of the CEMP (Construction Environmental Management Plan), in accordance with <u>RMS Environmental Procedures- Management of Waste on Roads and</u> <u>Maritime Services Land</u></li> <li>Surplus material, off cuts, and other debris resulting from the work shall be removed from site and disposed of by a licensed contractor to</li> </ul>
	a licensed waste management facility. Some spoil may be reused on site.
	<ul> <li>Waste material, other than vegetation and tree mulch, is not to be left on site once the works have been completed.</li> <li>Working areas are to be maintained, kept free of rubbish, and cleaned up at the end of each working day.</li> </ul>
Traffic and transport	Are the proposed works likely to result in detours, disruptions, or delays to traffic flow (vehicular, cycle and pedestrian) or access to properties or businesses?
	During construction?
	Yes 🗵 No 🗆
	There may be some minor disruption to the car park during construction. The car park will be used by patrons of the reserve and there may be some occasional overflow from the Macquarie Fields fitness and leisure centre. As an offset, there will be a reduction in demand for the car park, as the current amenities buildings will be demolished as part of the works. Any changes due to the works will be notified to stakeholders and traffic control arrangements in place.
	During Operation?
	Yes 🗆 No 🗵
Potential Impacts	Are the proposed works likely to affect any other transport nodes or transport infrastructure (e.g., bus stops, bus routes) in the surrounding area? Result in detours or disruptions to traffic flow (vehicular, cycle and pedestrian) or access during operation?
	Yes 🗆 No 🗵
Safeguards	• Where possible, current traffic movements and property accesses are to be maintained during the works. Any disturbance is to be minimised to prevent unnecessary traffic delays.
	<ul> <li>If traffic disturbance is unavoidable, a Traffic Management Plan (TMP) will be prepared in accordance with the RMS Traffic Control at Work Sites Manual RTA 2010) and QA Specification G10 Control of Traffic (RTA 2008).</li> </ul>
	Comply with Council requirements regarding traffic control, access, and



	road/ pedestrian access.
	<ul> <li>Erect signs regarding proposed works, temporary road closures, diversions etc.</li> </ul>
Visual Amenity/ Landscape	Will the project have any potential impact on visual amenity of the site and surrounding landscape?
	Yes 🗆 No 🗵
Potential Impacts	• The new buildings will be an improvement in visual appearance
	compared to the existing buildings on the site.
	• Additional landscaping is proposed to soften the visual impact on the
	landscape.
	• The materials used for the construction are mindful of the aesthetics of
	the site and is selected based on its durability and robustness to
	withstand the site's unique environmental conditions.
Safeguards	Contain all work within the boundaries designated on the site plan
	<ul> <li>Restore work sites to as close to their original condition as possible</li> </ul>
	Minimise spread of stockpiles, waste, and parking
	Yes □ No ⊠ Are the proposed works likely to require any property acquisition? Yes □ No ⊠
	Are the proposed works likely to alter any access for properties (either temporarily or permanently)? Yes 🗆 No 🗵
	Are the proposed works likely to alter any on-street parking arrangements (either temporarily or permanently)? Yes 🗆 No 🗵
	Are the proposed works likely to change pedestrian movements or pedestrian access (either temporarily or permanently)? Yes $\boxtimes$ No $\square$
	It is anticipated that the works site will be temporarily inaccessible by the



	public for the duration of the works. The majority of the reserve (other than the buildings) will continue to be useable.
	Are the proposed works likely to impact on any items or places of social value to the community (either temporarily or permanently)? Yes 🗵 No 🗆
	It is anticipated that the works site will be temporarily inaccessible by the public for the duration of the works. The majority of the reserve (other than the buildings) will continue to be useable.
	The expected duration of the works is 45 weeks.
	Are the proposed works likely to reduce or change visibility of any businesses, farms, tourist attractions or the like (either temporarily or permanently)? Yes  No  M
Potential Impacts	Does the project pose any potential risk to the socio-economic factors? Yes $\Box$ No $\boxtimes$
	The proposed works are intended to provide economic and social benefits to the Campbelltown community by improving the useability of an existing sporting and community facility.
Safeguards	• Contain all work within the boundaries designated on the site plan.
	• Restore work sites to as close to their original condition as possible.
	• Display public information signs until site restoration is complete.
	• Carry out community and stakeholder consultation before works start.
	<ul> <li>Notify the Works Supervisor and Asset Manager immediately of any complaints or any accidental damage to property.</li> </ul>
	<ul> <li>Locate services on DBYD search and peg out no-go areas to avoid service-disruption.</li> </ul>
	• All Council staff will exercise courtesy in dealing with the community.



# 5. Summary

Table 6: Summary of environmental safeguards to be implemented

Safeguards for the	Safeguards for the proposed work	
General	If the scope of the works changes at any time, review this REF to determine any new measures to take.	
	An environmental management plan is prepared and implemented prior to the commencement of works.	
	No new access tracks to be created for the works.	
	Parking of vehicles and storage of plant/equipment is to occur on existing paved areas. Where this is not possible, vehicles and plant/equipment are to be kept away from environmentally sensitive areas and outside the dripline of trees.	
	All project staff and contractors will be inducted on the environmental sensitivities of the work site(s) and relevant safeguards prior to commencement.	
	The Project Manager will be notified immediately of any complaints relating to management of environmental issues.	
	To ensure compliance with Section 148(3) of the Protection of the Environment Operations Act 1997, the Council's Health and Building Manager must be notified of any pollution incidents that have caused or threaten material harm to the environment	
	The Asset Manager will be notified if damage occurs to an area (vegetation, etc) outside of the nominated work area	

	CAMPBELLTOWN City Council
Landform, geology, and soils	<ul> <li><u>Erosion and Sedimentation</u></li> <li>Site management will incorporate best management erosion and sediment control practices such as those found in the Landcom's "Blue Book (4th Edition) on erosion and sediment control.</li> <li>Construct temporary drainage structures in accordance with the 'Technical Guideline - Temporary Stormwater Drainage for Road Construction' (RMS 2011)</li> <li>Linear silt stop fencing to be installed down slope of all affected areas and stockpiles. Silt fencing will be installed before excavation begins.</li> <li>Sandbags, hay bales wrapped in geotextile fabric etc. will be used to slow water flow and trap sediment. No straw bales are to be used.</li> <li>Overburden will be placed in the form of a bund upslope of the site where necessary to reduce surface water entering the site.</li> <li>All erosion and silt control devices will be visually inspected weekly to ensure effectiveness as well as after each rainfall event.</li> </ul>
	<ul> <li>Stockpiles will be designed, established, operated, and decommissioned in accordance with the RMS Stockpile Site Management Guidelines 2015.</li> <li><u>Soil Stabilisation and Restoration</u></li> <li>The rehabilitation of disturbed areas will be carried out progressively as construction stages are completed, and in accordance with:         <ul> <li>Landcom's "Blue Book (4th Edition) on sediment and erosion control</li> <li><u>RMS Landscape Guidelines</u></li> <li><u>RMS Guidelines for Batter Stabilisation Using Vegetation</u></li> </ul> </li> </ul>
Contaminated Land and Acid Sulfate Soils	<ul> <li><u>Contaminates Land</u></li> <li>If contaminated areas are encountered during construction, appropriate control measures will be implemented to manage the immediate risks of contamination. All other works that may impact on the contaminated area will cease until the nature and extent of the contamination has been confirmed and any necessary site-specific controls or further actions identified in consultation with relevant government agencies.</li> <li><u>Acid Sulfate Soils</u></li> <li>If Acid Sulfate Soils will or may be disturbed an Acid Sulfate Soils Management Plan is required as part of the CEMP.</li> </ul>
Water quality and hydrology	<ul> <li><u>Water quality</u></li> <li>Visual monitoring of local water quality (i.e., turbidity, hydrocarbon spills/slicks) is to be undertaken on a regular basis to identify any potential spills or deficient erosion and sediment controls.</li> <li>Water quality control measures are to be used to prevent any materials (e.g., concrete, grout, sediment etc) entering drain inlets or waterways.</li> <li>Wash down should use potable water and excess debris removed using hand tools. Wash down waste must be filtered before release, and away from all waterways.</li> </ul>



	<ul> <li>No dirty water may be released into drainage lines and/or waterways.</li> <li>Prevent sediment moving off-site and sediment laden water entering any water course, drainage lines, or drain inlets.</li> <li>Reduce water velocity and capture sediment on site.</li> <li>Minimise the amount of material transported from site to surrounding pavement surfaces.</li> <li>Divert clean water around the site.</li> </ul>
	Store fuels, chemical and hazardous materials in secure, bunded areas
	<ul> <li>within temporary construction ancillary facilities, and at least 50m from all waterways.</li> <li>Capture and dispose of spill and contaminated materials from temporary construction ancillary facilities at a licensed facility.</li> <li>Provide spill kits around temporary construction ancillary facilities.</li> <li>Measures to control pollutants from stormwater and spills will be investigated and incorporated in the pavement drainage system at locations where it discharges to the receiving drainage lines. Measures aimed at reducing flow rates during rain events and potential scour will also be incorporated in the design of the pavement drainage system.</li> </ul>
Biodiversity –	<u>General</u>
Flora and Fauna	<ul> <li>As part of the site induction process, provide all site personnel with information on the biodiversity values of the study area, including threatened species, no-go areas, and responsibilities under relevant environmental legislation, including but not limited to the EP&amp;A Act, BC Act and EPBC Act and associated management plans for individual species.</li> <li>Should unexpected, threatened fauna be located at any time during</li> </ul>
	construction, cease work immediately in the area to prevent further harm to the individual. Contact Council's Environmental Officer and a suitably qualified ecologist to determine if further assessment or management plans are required.
	Invasion of Exotic Species:
	<ul> <li>Manage vegetation within the road reserve and adjacent to areas of vegetation clearing in accordance with Guide 6 Weed Management and Guide 10 Aquatic Habitats and Riparian Zones of Roads and Maritime's Biodiversity Guidelines (RTA, 2011) to reduce invasion of noxious weed species.</li> </ul>
	• Use weed-free topsoil in landscaping and revegetate disturbed sites with locally indigenous species.
	• Construction machinery should be washed prior to entering and leaving site to ensure weed propagules are not transported.
	<u>Stockpiling:</u>
	<ul> <li>Only place stockpiles in low value vegetation, where cleared sites are unavailable.</li> </ul>
	• Stockpiles should be no taller than 2m height.



[	
	Use existing stockpiles before creating new ones.
	Site Restoration:
	• The rehabilitation of disturbed areas will be carried out progressively as construction stages are completed, and in accordance with:
	• Landcom's "Blue Book (4th Edition) on sediment and erosion control.
	RMS Landscape Guidelines.
	• RMS Guidelines for Batter Stabilisation Using Vegetation.
Aboriginal	Unexpected Finds
Heritage	• If Aboriginal heritage items are uncovered during the works, all works in the vicinity of the find must cease and the Project Manager contacted immediately, and the Standard Management Procedure - Unexpected Heritage Items (RMS, 2015) will be followed.
Non-Aboriginal	Unexpected Finds
Heritage	• If heritage items are uncovered during the works, all works in the vicinity of the find must cease and the Project Manager contacted immediately, and the Standard Management Procedure - Unexpected Heritage Items (RMS, 2015) will be followed.
Noise	Notification
	• All sensitive receivers (e.g., residents and school) likely to be affected will be notified at least five working days prior to the start of any works associated with the activity that may have an adverse noise or vibration impact.
	<ul> <li><u>Standard Hours of Operation</u></li> <li>Works to be carried out during normal work hours (i.e., 7am to 6pm Monday to Friday; 8am to 1pm Saturdays). Any work that is performed outside normal work hours or on Sundays or public holidays may not be permitted and, if permitted, works are to minimise noise impacts.</li> </ul>
	<ul> <li><u>Out of hours</u></li> <li>Where out-of-hours activities are required, this will be subject to Council's requirements and approval.</li> </ul>
Air quality	<ul> <li>Measures to minimise or prevent air pollution or dust are to be used including watering or covering exposed areas.</li> <li>Works are not to be carried out during strong winds or in weather conditions where high levels of dust or air borne particulates are likely.</li> </ul>
	• Vegetation or other materials are not to be burnt on site.
	• Vehicles and vessels transporting waste or other materials that may produce odours or dust are to be covered during transportation.
	• Vehicles and equipment are to be maintained in good working order.
	<ul> <li>Monitor work areas and stockpiles for dust generation and seed/cover/spray to suppress.</li> </ul>
	<ul> <li>Measures (including watering or covering exposed areas) are to be</li> </ul>
	measures (measuring or covering exposed areas) are to be



	used to minimise or prevent air pollution and dust.
	Do not leave vehicles idling.
Waste and Chemical Management	A Waste Management Plan will be prepared as part of the CEMP (Construction Environmental Management Plan), in accordance with <u>RMS Environmental Procedures- Management of Waste on Roads and</u> <u>Maritime Services Land</u>
	<ul> <li>All surplus material, off cuts, and other debris resulting from the work shall be removed from site and disposed of by a licensed contractor to a licensed waste management facility.</li> </ul>
	<ul> <li>Waste material, other than vegetation and tree mulch, is not to be left on site once the works have been completed.</li> <li>Working areas are to be maintained, kept free of rubbish, and cleaned up at the end of each working day.</li> </ul>
Traffic and transport	• Where possible, current traffic movements and property accesses are to be maintained during the works. Any disturbance is to be minimised to prevent unnecessary traffic delays.
	<ul> <li>If traffic disturbance is unavoidable, a Traffic Management Plan (TMP) will be prepared in accordance with the RMS Traffic Control at Work Sites Manual RTA 2010) and QA Specification G10 Control of Traffic (RTA 2008).</li> <li>Comply with Council requirements regarding traffic control, access, and road/ pedestrian access.</li> </ul>
	<ul> <li>Erect signs regarding proposed works, temporary road closures, diversions etc.</li> </ul>
Visual Amenity/	Contain all work within the boundaries designated on the site plan
Landscape	• Restore work sites to as close to their original condition as possible
	Minimise spread of stockpiles, waste, and parking
Socio-economic	• Contain all work within the boundaries designated on the site plan.
	• Restore work sites to as close to their original condition as possible.
	• Display public information signs until site restoration is complete.
	• Carry out community and stakeholder consultation before works start.
	• Notify the Works Supervisor and Asset Manager immediately of any complaints or any accidental damage to property.
	<ul> <li>Locate services on DBYD search and peg out no-go areas to avoid service-disruption.</li> </ul>
	All Council staff will exercise courtesy in dealing with the community.



## 6. Certification, Review and Decision

This Review of Environmental Factors provides a true and fair review of the proposal in relation to its potential effects on the environment.

It fully addresses possible all matters affecting or likely to affect the environment because of the proposal. It identifies the impacts of the proposal on the environment and details the environmental safeguards and mitigation measures to be implemented to minimise the potential impact to the environment.

In consideration of the above assessment of the proposed activity, it is considered that the overall impact on the environment is likely to be minimal and therefore acceptable. The long-term benefits of the activity will have a cumulative positive impact.

#### **REF** Author

Name: David Carey

Title: Town Planning Consultant

Date: 06 December 2024

Reviewed and endorsed by:

Signature: Mclan

Name: Mitchell Clark

Title: Coordinator Natural Areas

Date: 16 December 2024

Authorising Manager's approval

Signature:

Jobars .

Name: Ian Andrews

Title: Executive Manager Open Space

Date: 16 December 2024

*Independence should be maintained between the above roles. This is to ensure that an independent and professional evaluation is made as to whether the REF adequately addresses* 



the impacts of the proposal, whether additional assessment is required and whether adequate controls are proposed.



# **Appendix A**

## Figures



Figure 1: Location- Regional Context (NSW Government - Six Maps)



Figure 2: Location of site (NSW Government - Six Maps)





Figure 5: View of the site from Fields Road (Google Maps)



# **Appendix B - Assessment of Significance**

The assessment of significance must be completed when a threatened species may be impacted in accordance with the requirements of section 1.7 of the *Environmental Planning and Assessment Act 1979:* the Assessment of Significance under Section 7.3 the *Biodiversity Conservation Act* 2016 and the Federal *Environmental Protection and Biodiversity Conservation Act* 1999.

The area was assessed according to the impact of the proposed works on habitat and potential habitat for threatened species that may or are likely to utilise the subject site and study area.

#### Assessment of Significance (NSW BC Act 2016)

As per section 7.3 the *Biodiversity Conservation Act 2016*, the following factors must be considered when deciding of an activity or development:

- (a) in the case of a threatened species, whether the proposed development or activity is likely to have an adverse effect on the life cycle of the species such that a viable local population of the species is likely to be placed at risk of extinction,
- (b) in the case of an endangered ecological community or critically endangered ecological community, whether the proposed development or activity:
  - (i) is likely to have an adverse effect on the extent of the ecological community such that its local occurrence is likely to be placed at risk of extinction, or
  - (i) is likely to modify the composition of the ecological community substantially and adversely such that its local occurrence is likely to be placed at risk of extinction,
- (c) in relation to the habitat of a threatened species, population, or ecological community:
  - (i) the extent to which habitat is likely to be removed or modified because of the action propose, and
  - (ii) whether an area of habitat is likely to become fragmented or isolated from other areas of habitat because of the proposed action, and
  - (iii) the importance of the habitat to be removed, modified, fragmented, or isolated to the long-term survival of the species, population, or ecological community in the locality,
- (d) whether the proposed development or activity is likely to have an adverse effect on any declared area of outstanding biodiversity value (either directly or indirectly),
- (e) whether the proposed development or activity constitutes or is part of a key threatening process or is likely to result in the operation of, or increase the impact of, a key threatening process.



#### <u>Conclusion regarding significance under the NSW BC Act listed species, ecological</u> <u>communities, or populations</u>

A Species Impact Statement is not required. The proposed works are located on an existing developed part of the site. No tree or vegetation removal is proposed and the proposed development will have no impact on fauna habitat.



#### 1. Assessment of Significance (Commonwealth EPBC Act 1999)

As per Part 3 of the Environment Protection and *Biodiversity Conservation Act 2016*, the following factors must be considered when making considering whether the matter is a controlled activity and whether the matter needs to be referred to the Commonwealth Minister for the Environment:

- (a) Are there any matters of national environmental significance located in the proposed action?
- (b) Considering the proposed action at its broadest scope (that is, considering all stages and components of the action, and all related activities and infrastructure), is there potential for impacts, including indirect impacts, on matters of national environmental significance?
- (c) Are there any proposed measures to avoid or reduce impacts on matters of national environmental significance (and if so, is the effectiveness of these measures certain enough to reduce the level of impact below the 'significant impact' threshold)?
- (d) Are any impacts of the proposed action on matters of national environmental significance likely to be significant impacts (important, notable, or of consequence, having regard to their context or intensity)?

Sig	nificant Impact Criteria for Critically Endangered and Endangered Species
a.	Is the action likely to have a significant impact on a vulnerable species
b.	Will it lead to a long-term decrease in the size of a population of a species
с.	Will it reduce the area of occupancy of the species
d.	Will it fragment an existing important population into two or more populations
e.	Will it adversely affect habitat critical to the survival of a species
f.	Will it disrupt the breeding cycle of a population
g.	Will it modify, destroy, remove, or isolate or decrease the availability or quality of habitat to the extent that the species is likely to decline
h.	Will it result in invasive species that are harmful to a critically endangered or endangered species becoming established in the critically endangered or endangered species' habitat
i.	Will it introduce disease that may cause the species to decline, or
j.	Will it interfere with the recovery of the species?

#### Significant Impact Criteria for Vulnerable Species

a. Is the action likely to have a significant impact on a vulnerable species



- b. Will it lead to a long-term decrease in the size of an important population of a species
- c. Will it reduce the area of occupancy of an important population
- d. Will it fragment an existing important population into two or more populations
- e. Will it adversely affect habitat critical to the survival of a species
- f. Will it disrupt the breeding cycle of an important population
- g. Will it modify, destroy, remove, or isolate or decrease the availability or quality of habitat to the extent that the species is likely to decline
- h. Will it result in invasive species that are harmful to a vulnerable species becoming established in the vulnerable species' habitat
- i. Will it introduce disease that may cause the species to decline, or
- j. Will it interfere with the recovery of the species?

#### Significant Impact Criteria for Critically Endangered and Endangered Communities

- a. Is the action being likely to have a significant impact on a critically endangered and endangered community
- b. Will it reduce the extent of an ecological community
- c. Will it fragment or increase fragmentation of an ecological community, for example by clearing vegetation for roads or transmission lines
- d. Will it adversely affect habitat critical to the survival of an ecological community
- e. Will it disrupt the breeding cycle of an important population
- f. Will it modify, destroy abiotic (non-living) factors (such as water, nutrients, or soil) necessary for an ecological community's survival. including reduction of groundwater levels, or substantial alteration of surface water drainage patterns
- g. Will it cause a substantial change in the species composition of an occurrence of an ecological community, including causing a decline or loss of functionally important species, for example through regular burning or flora or fauna harvesting
- h. Will it cause a substantial reduction in the quality or integrity of an occurrence of an ecological community, including, but not limited to
- i. Assisting invasive species, that are harmful to the listed ecological community, to become established, or
- j. Causing regular mobilisation of fertilisers, herbicides or other chemicals or pollutants into the ecological community which kill or inhibit the growth of species in the ecological community, or



k. Will it interfere with the recovery of an ecological community?

#### <u>Conclusion regarding significance under the Commonwealth EPBC Act listed species,</u> <u>ecological communities, or populations</u>

Referral to the Commonwealth is not required. The proposed works are located on an existing developed part of the site. No tree or vegetation removal is proposed and the proposed development will have no impact on fauna habitat. There will be no impact on matters of national environmental significance or Commonwealth land.



# **Appendix C - AHIMS Search**



David Carey

9 Squeers Place Ambarvale NSW 2560 Ambarvale NSW New South Wales 2560

Attention: David Carey

Email: david@dcaplanning.com.au

Dear Sir or Madam:

AHIMS Web Service search for the following area at Lat, Long From : -34.0002, 150.8783 - Lat, Long To : -33.9958, 150.886, conducted by David Carey on 26 November 2024.

The context area of your search is shown in the map below. Please note that the map does not accurately display the exact boundaries of the search as defined in the paragraph above. The map is to be used for general reference purposes only.



A search of Heritage NSW AHIMS Web Services (Aboriginal Heritage Information Management System) has shown that:

0 Aboriginal sites are recorded in or near the above location.
0 Aboriginal places have been declared in or near the above location. \*

Date: 26 November 2024

#### If your search shows Aboriginal sites or places what should you do?

- You must do an extensive search if AHIMS has shown that there are Aboriginal sites or places recorded in the search area.
- If you are checking AHIMS as a part of your due diligence, refer to the next steps of the Due Diligence Code of practice.
- You can get further information about Aboriginal places by looking at the gazettal notice that declared it. Aboriginal places gazetted after 2001 are available on the NSW Government Gazette (https://www.legislation.nsw.gov.au/gazette) website. Gazettal notices published prior to 2001 can be obtained from Heritage NSW upon request

#### Important information about your AHIMS search

- The information derived from the AHIMS search is only to be used for the purpose for which it was requested. It is not be made available to the public.
- AHIMS records information about Aboriginal sites that have been provided to Heritage NSW and Aboriginal places that have been declared by the Minister;
- Information recorded on AHIMS may vary in its accuracy and may not be up to date. Location details are recorded as grid references and it is important to note that there may be errors or omissions in these recordings,
- Some parts of New South Wales have not been investigated in detail and there may be fewer records of Aboriginal sites in those areas. These areas may contain Aboriginal sites which are not recorded on AHIMS.
- Aboriginal objects are protected under the National Parks and Wildlife Act 1974 even if they are not recorded as a site on AHIMS.
- This search can form part of your due diligence and remains valid for 12 months.



# **Appendix D - Proposed Plans**

Subject to detailed design.

# CAMPBELLTOWN CITY COUNCIL **BOB PRENTER RESERVE AMENITY BUILDING ISSUED FOR COORDINATION**

DRAWING LIST				
DRAWING NUMBER	DRAWING NAME			
01 - ARCHITECTURAL PACK	AGE			
0000 - GENERAL & SITE INF	ORMATION			
BPR-DIS-AR-DRG-0001	COVER SHEET AND DRAWING LIST			
BPR-DIS-AR-DRG-0003	GENERAL NOTES - SHEET 1			
BPR-DIS-AR-DRG-0004	GENERAL NOTES - SHEET 2			
BPR-DIS-AR-DRG-0005	SITE PLAN			
BPR-DIS-AR-DRG-0006	DEMOLITION PLAN			
BPR-DIS-AR-DRG-0010	GRID SETOUT PLAN			
BPR-DIS-AR-DRG-0090	PERSPECTIVES			
1000 - GENERAL ARRANGE	MENT PLANS			
BPR-DIS-AR-DRG-1200	GENERAL ARRANGEMENT PLAN - GROUND FLOOR			
BPR-DIS-AR-DRG-1201	GENERAL ARRANGEMENT PLAN - LEVEL 1			
BPR-DIS-AR-DRG-1202	GENERAL ARRANGEMENT PLAN - ROOF			
BPR-DIS-AR-DRG-1300	FINISHES PLAN - GROUND FLOOR			
BPR-DIS-AR-DRG-1301	FINISHES PLAN - LEVEL 1			
2000 - GENERAL ARRANGE	MENT RCPs			
BPR-DIS-AR-DRG-2100	REFLECTED CEILING PLAN - GROUND FLOOR			
BPR-DIS-AR-DRG-2101	REFLECTED CEILING PLAN - LEVEL 1			
3000 - GENERAL ARRANGE	MENT ELEVATIONS & SECTIONS			
BPR-DIS-AR-DRG-3000	GA ELEVATIONS - SHEET 1			
BPR-DIS-AR-DRG-3001	GA ELEVATIONS - SHEET 2			
BPR-DIS-AR-DRG-3002	GA ELEVATIONS - SHEET 3			
BPR-DIS-AR-DRG-3500	GA SECTIONS - SHEET 1			
BPR-DIS-AR-DRG-3501	GA SECTIONS - SHEET 2			
5000 - SET OUT				
BPR-DIS-AR-DRG-5000	CONCRETE SETOUT PLAN - GROUND FLOOR			
BPR-DIS-AR-DRG-5001	CONCRETE SETOUT PLAN - LEVEL 1			
BPR-DIS-AR-DRG-5500	WALL TYPE DETAILS - SHEET 1			
BPR-DIS-AR-DRG-5501	WALL TYPE DETAILS - SHEET 2			
BPR-DIS-AR-DRG-5600	WALL SETOUT PLAN - GROUND FLOOR			
BPR-DIS-AR-DRG-5601	WALL SETOUT PLAN - LEVEL 1			
6000 - VERTICAL CIRCULAT	ION			
BPR-DIS-AR-DRG-6100	STAIR 1 - PLANS			
BPR-DIS-AR-DRG-6101	STAIR 1 - SECTIONS			
BPR-DIS-AR-DRG-6102	STAIR 2 - PLANS			
BPR-DIS-AR-DRG-6103	STAIR 2 - SECTIONS			
BPR-DIS-AR-DRG-6104	STAIR DETAILS - SHEET 1			
BPR-DIS-AR-DRG-6105	GRANDSTAND STAIR - PLANS AND SECTION			
BPR-DIS-AR-DRG-6106	GRANDSTAND STAIR - SECTIONS SHEET 1			
BPR-DIS-AR-DRG-6107	GRANDSTAND - SECTION SHEET 2			
BPR-DIS-AR-DRG-6300	LIFT - DETAIL PLAN			
BPR-DIS-AR-DRG-6301	LIFT - ELEVATION SHEET 1			
BPR-DIS-AR-DRG-6302	LIFT - ELEVATIONS SHEET 2			
BPR-DIS-AR-DRG-6303	LIFT - SECTIONS			
BPR-DIS-AR-DRG-6307	LIFT DETAILS SHEET 1			
BPR-DIS-AR-DRG-6308	LIFT DETAILS SHEET 2			
7000 - INTERIOR DESIGN DI				
BPR-DIS-AR-DRG-1	INTERNAL ROOM ELEVATIONS - VENU0E MANAGEMENT SHEET 2			
BPR-DIS-AR-DRG-7100	INTERNAL ROOM ELEVATIONS - UMPIRE BRIEFING ROOM			
BPR-DIS-AR-DRG-7101	INTERNAL ROOM ELEVATIONS - GYM			
BPR-DIS-AR-DRG-7102	INTERNAL ROOM ELEVATIONS - CANTEEN			
BPR-DIS-AR-DRG-7103	INTERNAL ROOM ELEVATIONS - SERVICES ROOM 1			



	DRAWING LIST		DRAWING LIST		
DRAWING NUMBE	DRAWING NAME	DRAWING NUMBER	DRAWING NAME	DRAWING NUMBER	
BPR-DIS-AR-DRG-7501	INTERNAL ROOM ELEVATIONS - PLAYER'S CHANGE	BPR-DIS-AR-DRG-7112	INTERNAL ROOM ELEVATIONS - SERVICES ROOM 2	BPR-DIS-AR-DRG-7104	
BPR-DIS-AR-DRG-7502			INTERNAL ROOM ELEVATIONS - CLUB KITCHEN AND	BPR-DIS-AR-DRG-7105	
	INTERNAL ELEVATIONS - TYPICAL PLAYERS AMENITIES	BPR-DIS-AR-DRG-7113	BAR SHEET 1		
BPR-DIS-AR-DRG-7503	INTERNAL WET AREA ELEVATIONS - UMPIRE ENSUITE	BPR-DIS-AR-DRG-7400	INTERNAL ROOM ELEVATIONS - CLUB KITCHEN AND	BPR-DIS-AR-DRG-7106	
	INTERNAL ELEVATIONS - UMPIRE AMBULANT WC	BPR-DIS-AR-DRG-7401	BAR SHEET 2		
BPR-DIS-AR-DRG-7800	INTERNAL WET AREA ELEVATIONS - FEMALE WC	BPR-DIS-AR-DRG-7402	INTERNAL ROOM ELEVATIONS - CLUB ROOM WINDOW	BPR-DIS-AR-DRG-7107	
BPR-DIS-AR-DRG-7801	INTERNAL ELEVATIONS - MALE WC - GROUND FLOOR	BPR-DIS-AR-DRG-7403	SHEET 1		
8000 - EXTERIOR & FA	INTERNAL ELEVATIONS - CLEANERS ROOM	BPR-DIS-AR-DRG-7405	INTERNAL ROOM ELEVATIONS - CLUB ROOM WINDOW	BPR-DIS-AR-DRG-7108	
BPR-DIS-AR-DRG-8000	INTERNAL ELEVATIONS - PUBLIC ACCESSIBLE WC AND	BPR-DIS-AR-DRG-7406	SHEET 2		
BPR-DIS-AR-DRG-8001	SHOWER		INTERNAL ROOM ELEVATIONS - VENUE MANAGEMENT	BPR-DIS-AR-DRG-7109	
BPR-DIS-AR-DRG-8100	INTERNAL WET AREA ELEVATIONS - ACCESSIBLE WC -	BPR-DIS-AR-DRG-7407	SHEET 1		
BPR-DIS-AR-DRG-8101	GROUND FLOOR		INTERNAL ROOM ELEVATIONS - VENUE MANAGEMENT	BPR-DIS-AR-DRG-7110	
	TYPICAL JOINERY DETAILS TITLE SHEET	BPR-DIS-AR-DRG-7500	SHEET 2		
			INTERNAL ELEVATIONS - ACCESSIBLE CLUB ROOM WC	BPR-DIS-AR-DRG-7111	

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Cameron Martin 9194 Mary Anne McGirr 10946

7269

Nominated Architects

PLOTTED : 9/12/2024 12:50:13 PM

lan Armstrong



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CLIENT

# PROJECT **BOB PRENTER RESERVE AMENITY BUILDING**

PROJECT ADDRESS Fields Rd, Macquarie Fields NSW 2564

# WORK-IN-PROGRESS

A 9.12.24 ISSUED FOR COORDIINATION No DATE REVISIONS

DRAWN BY RK CHECKED BY MW APPROVED BY MAM

# \*Grandstand Extension and Link Bridge Not part of this REF\*

DRAWING LIST					
G NUMBER DRAWING NAME					
DRG-7501	JOINERY PLANS & AXO - J.01 CLUB HOUSE BAR ISLAND				
DRG-7502	JOINERY PLANS & AXO - J.02 CLUB HOUSE KITCHENETTE				
DRG-7503	JOINERY PLANS & AXO - J.03 GYM WATERPOINT & FIRST AID CUPBOARD				
DRG-7800	INTERNAL DESIGN DETAILS - SHEET 1				
DRG-7801	INTERNAL DESIGN DETAILS - SHEET 2				
RIOR & FAÇADE	DETAILS				
DRG-8000	PLAN DETAILS - SHEET				
DRG-8001	PLAN DETAILS - SHEET 2				
DRG-8100	EXTERNAL DESIGN DETAILS - SHEET 1				
DRG-8101	EXTERNAL DESIGN DETAILS - SHEET 2				

# NOT FOR CONSTRUCTION

**COVER SHEET AND DRAWING LIST** 

**DRAWING TO BE PRINTED IN COLOUR** 

TITLE

STATUS CONCEPT DESIGN SCALES @ A1

DRAWING NO. **BPR-DIS-AR-DRG-0001** 



# **GENERAL NOTES**

## DOCUMENTS:

THESE ARCHITECTURAL DRAWINGS ARE TO BE READ IN CONJUNCTION WITH THE ARCHITECTURAL REPORTS, SCHEDULES AND SPECIFICATIONS. THE ARCHITECTURAL DOCUMENTS DESCRIBE THE DESIGN INTENT AND PERFORMANCE REQUIREMENTS FOR THE PROJECT.

THESE ARCHITECTURAL DRAWINGS ARE TO BE READ IN CONJUNCTION WITH ALL OTHER CONSULTANT'S DRAWINGS, SPECIFICATIONS, AND WRITTEN INSTRUCTIONS AS MAY BE ISSUED AT ANY TIME DURING THE CONTRACT REFER TO THE FOLLOWING DRAWINGS, SPECIFICATIONS AND REPORTS WHICH ARE TO TAKE PRECEDENCE OVER ANY STRUCTURAL. SERVICES. TECHNICAL OR LANDSCAPE INFORMATION SHOWN ON THE ARCHITECTURAL DRAWINGS, SCHEDULES AND SPECIFICATIONS:

- THE GEOTECHNICAL ENGINEER'S REPORT, RECOMMENDATIONS AND SPECIFICATION WHERE PROVIDED.
- THE STRUCTURAL ENGINEER'S DRAWINGS AND SPECIFICATIONS FOR ALL STRUCTURAL REQUIREMENTS AND DETAILS. • THE HYDRAULIC ENGINEER'S DRAWINGS AND SPECIFICATIONS FOR ALL HYDRAULIC REQUIREMENTS, REDUCED LEVELS (RL) GRADIENTS/FALLS & DRAINAGE REQUIREMENTS.
- THE SERVICES ENGINEER'S DRAWINGS AND SPECIFICATIONS FOR ALL DRY FIRE SERVICES, ELECTRIC AND MECHANICAL REQUIREMENTS AND DETAILS. LOCATIONS AND POSITIONS TO COORDINATE WITH ARCHITECTURAL REQUIREMENTS.
- THE CIVIL ENGINEER'S DRAWINGS AND SPECIFICATIONS FOR ALL REINFORCED CONCRETE PAVING, ROADS, PATHS, ACCESSWAYS OR PARKING HARDSTAND DETAILS, INCLUDING REDUCED LEVELS (RL), SUB-GRADE, AND CONCRETE KERBING.

THE CONTRACTOR SHALL REPORT ANY DISCREPANCY, ERRORS, OMISSIONS, INCONSISTENCIES OR OTHER FAULTS FOUND IN THE ARCHITECTURAL DOCUMENTATION TO THE CLIENT FOR REVIEW BEFORE PROCEEDING WITH THE WORKS. UNLESS NOTED OTHERWISE, ANY WORKS SHOWN ON ONE DRAWING BUT NOT ON ANOTHER. OR SHOWN ON A CONSULTANT'S DRAWING BUT NOT ON THE ARCHITECTURAL DRAWINGS (OR VICE VERSA) ARE DEEMED TO BE INCLUDED IN THE CONTRACT WORKS.

THE CONTRACTOR IS TO ENSURE THAT SUFFICIENT TOLERANCES ARE ALLOWED FOR THE CONSTRUCTION WORKS.

THE CONTRACTOR IS TO ALLOW FOR ALL MATERIAL, EQUIPMENT, ACCESSORIES, LABOUR, ADDITIONAL DESIGN INPUT, PERMITS, APPROVALS AND THE LIKE TO COMPLETE THE WORKS IN ACCORDANCE WITH THIS INTENT AND SCOPE AND FOR THESE WORKS TO BE FIT FOR THEIR INTENDED PURPOSE.

PRIOR TO COMMENCEMENT OF ANY WORKS, THE CONTRACTOR IS TO IDENTIFY ALL EXISTING SERVICES. EXISTING SERVICES IF SHOWN ON ANY DRAWING ARE INDICATIVE ONLY AND ARE TO BE CHECKED AND LOCATED ON SITE. ANY DAMAGE TO EXISTING SERVICES IS TO BE RECTIFIED AT THE CONTRACTOR'S EXPENSE.

NO VARIATIONS WILL BE CONSIDERED UNLESS IT IS A CLEAR CHANGE TO THE INTENT AND SCOPE OF THE WORKS INITIATED IN WRITING BY THE CLIENT.

THESE DRAWINGS ARE COPYRIGHT AND THE PROPERTY OF THE CLIENT, AND MUST NOT BE RETAINED, REPRODUCED, COPIED OR USED, IN WHOLE OR IN PART BY ANY MEDIUM WITHOUT THE WRITTEN AUTHORITY OF THE CLIENT

# **AUTHORITIES:**

ALL WORKS (INCLUDING BUT NOT LIMITED TO DEMOLITION, CONSERVATION, EXCAVATION & CONSTRUCTION WORKS) ARE TO BE CARRIED OUT IN ACCORDANCE WITH THE PROVISIONS OF THE BUILDING CODE OF AUSTRALIA (BCA), CLAUSE 98 OF THE ENVIRONMENTAL PLANNING & ASSESSMENT REGULATION 2000, THE NSW WORK HEALTH AND SAFETY ACT 2011 AND THE NSW WORK HEALTH AND SAFETY REGULATION 2011.

ALL WORKS (INCLUDING BUT NOT LIMITED TO DEMOLITION, CONSERVATION, EXCAVATION & CONSTRUCTION WORKS) ARE TO BE CARRIED OUT IN ACCORDANCE WITH THE NOTICE OF DETERMINATION OF THE APPLICABLE DEVELOPMENT APPROVAL CONSTRUCTION SHALL NOT COMMENCE BEFORE THE RELEVANT CONSTRUCTION CERTIFICATE IS ISSUED BY THE PRINCIPAL CERTIFYING AUTHORITY.

THE ARCHITECT IS NOT RESPONSIBLE FOR ANY CHANGES REQUESTED BY ANY AUTHORITIES.

### **ABORIGINAL ARTEFACTS:**

IF ANY ABORIGINAL OBJECTS ARE FOUND ON THE SITE. STOP WORK AND NOTIFY THE LOCAL COUNCIL. THE NSW OFFICE OF ENVIRONMENT AND HERITAGE. AND THE LOCAL ABORIGINAL LAND COUNCIL

### **REFERENCE LEVELS:**

ALL SERVICES IMPACTING THE SITE, AND ALL LEVELS REFERRED TO IN THE ARCHITECTURAL DOCUMENTATION, ARE REFERENCED FROM THE SURVEY INFORMATION PROVIDED TO DESIGNINC, AND ARE TO BE CHECKED ON SITE PRIOR TO CONSTRUCTION OR MANUFACTURING. REPORT ANY DISCREPANCIES TO THE CLIENT IMMEDIATELY ALL LEVELS AND RL'S IN THE DOCUMENTS ARE TO THE AUSTRALIAN HEIGHT DATUM (AHD). A BENCHMARK LEVEL IS TO BE ESTABLISHED ON THE SITE (TO AUSTRALIAN HEIGHT DATUM) TO ENABLE COMPARISON WITH THE FLOOD STANDARD.

### SETTING OUT:

THE CONTRACTOR IS TO CHECK AND VERIFY ALL SETOUT DIMENSIONS AND LEVELS ON SITE PRIOR TO THE COMMENCEMENT OF ANY RELEVANT PART OF THE WORKS.

ALL SET OUT DIMENSIONS AND LEVELS ARE TO BE CHECKED BY A LICENSED SURVEYOR ON SITE. AND ALL OVERALL AND CRITICAL DIMENSIONS ARE TO BE SET OUT FOR APPROVAL BY THE CLIENT PRIOR TO THE COMMENCEMENT OF ANY CONSTRUCTION OR EXCAVATION.

### SAMPLES AND SCHEDULES:

PRIOR TO INSTALLATION OR CONSTRUCTION, THE CONTRACTOR IS TO PROVIDE A SAMPLE OF EACH SPECIFIED ELEMENT, COMPLETE WITH THE MANUFACTURER'S CERTIFICATES SHOWING COMPLIANCE WITH THE RELEVANT PERFORMANCE CRITERIA. PLEASE REFER TO ARCHITECTURAL PERFORMANCE SPECIFICATION AND SUBMITTALS SCHEDULE FOR COMPLETE LIST OF SAMPLES AND PROTOTYPES FOR DESIGNER'S REVIEW AND APPROVALS PRIOR TO ORDERING AND INSTALLING DOORS, WINDOWS, DOOR HARDWARE AND OTHER SPECIALIST ELEMENTS SCHEDULED IN THE DOCUMENTS. THE RELEVANT SUB-CONTRACTOR IS TO PROVIDE A RETURN SCHEDULE FOR APPROVAL OF THE CLIENT

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**DEMOLITION:** ALL DEMOLITION WORK AND CONSTRUCTION WORK METHODS TO COMPLY WITH THE NSW WORK HEALTH AND SAFETY ACT 2011, OH&S ACT2000, OH&S REGULATION 2001 AND ALL OTHER OH&S REQUIREMENTS. ALL PRACTICES TO BE COMPLIANT WITH LEGISLATION AND CODES ADMINISTERED BY SAFEWORK NSW. ALL WORKS UNDERTAKEN TO COMPLY WITH AS2601: THE DEMOLITION OF STRUCTURES AND OTHER RELEVANT AUSTRALIAN STANDARDS, AND THE LOCAL AUTHORITY'S STATUTORY REQUIREMENTS AND THE CONDITIONS OF DEVELOPMENT CONSENT UNDERTAKE ALL WORKS TO MINIMISE DISRUPTION, DUST AND NOISE TO THE SITE. READ DEMOLITION DRAWINGS IN CONJUNCTION WITH PROPOSED NEW WORKS DOCUMENTS PREPARED BY THE ARCHITECT AND ALL OTHER CONSULTANTS, INCLUDING STRUCTURAL AND SERVICES ENGINEERS. UNLESS REQUIRED OTHERWISE IN THE CONTRACT PRELIMINARIES. PROVIDE SOLID. PAINTED HOARDINGS TO PERIMETER OF WORKS ZONE, COMPLETE WITH STATUTORY SIGNAGE, TO LOCAL AUTHORITIES' SATISFACTION. AGREE HOARDING LOCATIONS WITH CLIENT PRIOR TO ORDERING OR PLACEMENT OF HOARDINGS. CO-ORDINATE AND CONFIRM TIMING OF ALL DEMOLITION WITH CLIENT PRIOR TO COMMENCEMENT.

# SURVEY:

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# DAMP & WEATHERPROOFING:

THE WORKS ARE TO COMPLY WITH BCA VOLUME 1, PART F1 FOR DAMP AND WEATHERPROOFING.

WEATHERPROOFING OF EXTERNAL AREAS AND EXTERNAL ENVELOPE AND EXTERNAL ABOVE GROUND MEMBRANES MUST TO COMPLY TO AS 4564 PARTS 1 AND 2.

THE BUILDING AND ANY ASSOCIATED SITE WORK IS TO BE CONSTRUCTED IN A WAY THAT

· PROTECTS PEOPLE AND OTHER PROPERTY FROM THE ADVERSE EFFECTS OF REDIRECTED SURFACE WATER:

· PROVIDES RESISTANCE TO MOISTURE PENETRATING FROM THE OUTSIDE INCLUDING RISING FROM THE GROUND; AND · AVOIDS THE CREATION OF UNHEALTHY OR DANGEROUS CONDITIONS; AND DAMAGE TO BUILDING ELEMENTS, CAUSED BY DAMPNESS OR WATER OVERFLOW.

 THE CONTRACTOR IS REQUIRED TO NOTIFY THE CLIENT IMMEDIATELY UPON DISCOVERY OF ANY VARIANCES TO THE SURVEY DATA.

THE TOPOGRAPHICAL SURVEY INFORMATION SHOWN ON DRAWINGS HAS BEEN PROVIDED TO

DESIGNINC SYDNEY. THE ARCHITECT DOES NOT GUARANTEE THAT THE SURVEY INFORMATION IS

ACCURATE AND ACCEPTS NO LIABILITY FOR INACCURACIES.

 THE SURVEY HAS BEEN COMPILED BASED ON A GROUND SURVEY DATA OBTAINED DURING THE DESIGN PROCESS. THE LEVEL DATUM REFERRED TO IN THESE DRAWINGS IS AUSTRALIAN HEIGHT DATUM (AHD)

THE SURVEY COORDINATE SYSTEM IS MAP GRID OF AUSTRALIA (MGA).

### FIRE SAFETY COMPLIANCE:

THE PROPOSED DEVELOPMENT IS TO COMPLY WITH:

RESISTANCE LEVELS ARE TO BE IN ACCORDANCE WITH BCA SPECIFICATION C1.1

STRUCTION GENERALLY IN ACCORDANCE WITH BCA PART B1.4: MATERIALS AND FORMS OF CONSTRUCTION;

CIFICATION C1.1: FIRE-RESISTING CONSTRUCTION AND SPECIFICATION C1.11: PERFORMANCE OF EXTERNAL WALLS FIRE

HYDRANT SYSTEM MUST COMPLY WITH AS2419.1-2021

TABLE FIRE EXTINGUISHERS -IN ACCORDANCE WITH BCA PART E1.6 AND AS 2444: PORTABLE FIRE EXTINGUISHERS FIRE BLANKETS SELECTION AND LOCATION

MATERIALS, LININGS, SURFACE FINISHES, FITTINGS AND FIXTURES MUST COMPLY WITH BCA SPECIFICATION C1.10: FIRE HAZARD PROPERTIES

### STRUCTURAL FIXINGS:

ALL PRACTICES TO BE COMPLIANT WITH ALL RELEVANT AUSTRALIAN STANDARDS, WORKSAFE CODES AND OH&S REGULATIONS INCLUDING BUT NOT LIMITED TO AS 1891.4:2009 INDUSTRIAL FALL ARREST SYSTEMS AND DEVICES: WORKSAFE CODE OF PRACTICE, SAFE WORK ON ROOFS, PART 1, COMMERCIAL AND INDUSTRIAL BUILDINGS. ALL METAL RAINWATER GOODS TO BE SELECTED. SUPPLIED AND INSTALLED IN ACCORDANCE WITH AS 2179.1 ROOF CONSTRUCTION. ROOF AND WALL INSULATION IS TO COMPLY WITH BCA VOLUME 1.

### SAFETY SYSTEMS:

CONTRACTOR TO SUPPLY AND INSTALL ALL REQUIRED SAFETY SYSTEMS, FOR PROVIDING CONTINUED SAFETY FOR BOTH MAINTENANCE AND ACCESS. THESE INCLUDE BUT ARE NOT LIMITED TO ROOF ACCESS SYSTEMS, FAÇADE ACCESS SYSTEM, LANDSCAPE MAINTENANCE, AND SITE ACCESS. PROVISION AND DESIGN OF ALL REQUIRED SAFETY SYSTEMS TO BE CERTIFIED BY SAFETY SPECIALIST PRIOR TO COMMENCEMENT OF WORK BY CONTRACTOR.

## SLIP RESISTANCE OF FLOOR SURFACES:

THE DEVELOPMENT IS TO COMPLY WITH THE MINIMUM RECOMMENDATIONS OF AS 4586-2013: SLIP RESISTANCE CLASSIFICATION OF NEW PEDESTRIAN SURFACE MATERIALS & HB 198-2014: GUIDE TO THE SPECIFICATION AND TESTING OF SLIP RESISTANCE OF PEDESTRIAN SURFACES.

#### **PROPRIETARY SYSTEMS:**

ALL PROPRIETARY ITEMS ARE TO BE ASSEMBLED, INSTALLED AND FIXED TO SUBSTRATE IN ACCORDANCE WITH THE CURRENT RECOMMENDATIONS AND INSTRUCTIONS OF THE MANUFACTURER OR SUPPLIER, AND ARE TO MEET RELEVANT CONSTRUCTION CODES AND REQUIREMENTS.

### WARRANTIES & CERTIFICATES:

PRIOR TO PRACTICAL COMPLETION, THE RELEVANT SUBCONTRACTOR MUST PROVIDE CERTIFICATION THAT THE WORKS HAVE BEEN SUPPLIED AND INSTALLED IN ACCORDANCE WITH THE BCA, RELEVANT AUSTRALIAN STANDARDS AND ANY MANUFACTURER'S.

### NON-COMBUSTIBLE BUILDING ELEMENTS:

ALL EXTERNAL WALLS, FACADE COVERINGS, INTERNAL FIRE RATED WALLS, WALL ATTACHMENTS AND COMPONENTS INCLUDING FRAMING AND INSULATION MUST BE NON-COMBUSTIBLE. TEST REPORTS FROM A REGISTERED TESTING AUTHORITY CONFIRMING TESTING IN ACCORDANCE WITH AS1530.1 FOR NON-COMBUSTIBILITY ARE REQUIRED FOR ALL RELEVANT PRODUCTS.

CLIENT



# **BOB PRENTER RESERVE** AMENITY BUILDING

PROJECT ADDRESS Fields Rd, Macquarie Fields NSW 2564

# WORK-IN-PROGRESS

A 9.12.24 ISSUED FOR COORDIINATION No DATE REVISIONS

# NOT FOR CONSTRUCTION DRAWING TO BE PRINTED IN COLOUR

**GENERAL NOTES - SHEET 1** 

DRAWING NO. **BPR-DIS-AR-DRG-0003** 



# **GENERAL NOTES**

# **RECOMMENDATIONS:**

PRIOR TO PRACTICAL COMPLETION THE RELEVANT SUBCONTRACTOR MUST PROVIDE COPIES OF ALL MANUFACTURER'S WRITTEN WARRANTIES.

ALL INSTALLATION CERTIFICATES REQUIRED FOR OCCUPATION CERTIFICATE (TO THE SATISFACTION OF THE CERTIFYING AUTHORITY) TO BE SUBMITTED BY PRACTICAL COMPLETION, INCLUDING BUT NOT LIMITED TO:

- STRUCTURAL CERTIFICATION
- MECHANICAL CERTIFICATION EMERGENCY LIGHTING
- SMOKE ALARMS •
- PATHS OF TRAVEL, PORTABLE FIRE EXTINGUISHERS
- ELECTRICAL CERTIFICATION
- PLUMBING/ HYDRAULIC/ DRAINAGE CERTIFICATION
- HANDRAIL AND BALUSTRADE CERTIFICATION •
- FIRE SAFETY CERTIFICATE
- INSTALLATION OF FIRE LINING • SLIP RESISTANCE •
- LRV RATINGS
- WATERPROOFING
- INSULATION

# PUBLIC DOMAIN:

THE PUBLIC DOMAIN REFERS TO AN AREA, A STREET, PAVEMENT WALKWAY, ROAD ADJOINING THE SITE BOUNDARY OF THE PROJECT AND BELONGING TO THE LOCAL AUTHORITY.

- PUBLIC DOMAIN REQUIREMENTS ARE TO BE READ IN CONJUNCTION WITH CIVIL WORKS AND LANDSCAPE DOCUMENTATION AND DETAILS
- DESIGN, MATERIALS, SET OUT AND FFE IN ACCORDANCE WITH AUTHORISING COUNCIL.
- PROVIDE A DILAPIDATION REPORT INCLUDING BUT NOT LIMITED TO PHOTOS PRIOR TO COMMENCEMENT OF DEMOLITION. ALL DEMOLITION WORK AND CONSTRUCTION WORK METHODS TO COMPLY WITH THE NSW WORK HEALTH AND SAFETY ACT 2011, OH&S ACT2000, OH&S REGULATION 2001 AND ALL OTHER OH&S REQUIREMENTS.

# SUSTAINABILITY:

- LED LIGHTING SYSTEMS TO COMPLY WITH A 25-YEAR LIFESPAN
- ALL FINISHES TO BE COMPLIANT WITH THE APAS VOC COMPOUND LIMITS.
- USING MODULAR SYSTEM DESIGNS FOR EASY SINGLE UNIT REPLACEMENT FOR EXAMPLE, BOLTED CONNECTIONS FOR STEELWORK.
- ALL PVC PRODUCTS MUST BE COMPLIANT WITH THE GBCA BEST PRACTICE GUIDELINES FOR PVC IN THE BUILT ENVIRONMENT.
- USING MATERIALS THAT CAN BE RECYCLED, SUCH AS STEEL AND ALUMINIUM.
- ALL TIMBER PRODUCTS MUST BE SOURCED FORM ONE OR MORE OF THE FOLLOWING: •
- **RE-USED TIMBER;** a.
- b. POST-CONSUMER RECYCLED TIMBER;
- c. TIMBER SUPPLIERS IN AUSTRALIA CERTIFIED BY THE FOREST STEWARDSHIP COUNCIL, AUSTRALIA; OR
- TIMBER SUPPLIERS IN AUSTRALIA CERTIFIED UNDER THE PROGRAM FOR THE ENDORSEMENT OF FOREST d. CERTIFICATION.



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7260 Cathryn Drew-Bredin 7269

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PLOTTED : 9/12/2024 11:02:43 AM

Nominated Architects

lan Armstrong



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# **GENERAL ABBREVIATIONS**

ACU AMD AS BCA	AIR CONDENSOR UNIT AMENDMENT AUSTRALIAN STANDARD BUILDING CODE OF AUSTRALIA
CCTV	CLOSED CIRCUIT TELEVISION
CDR	CROSS DISCIPLINE REVIEW
CFC	COMPRESSED FIBRE CEMENT
CL	CENTERLINE
COL	COLUMN
COMMS	
CONC	CONCRETE
COS CTS	CONFIRM ON SITE CENTRES
DBYD	
DDA	DISABILITY DISCRIMINATION ACT 1992
DEG	DEGREES
DIA	DIAMETER
DP	DOWNPIPE
DRG	DRAWING/S
EX	EXISTING
ELEC	
ENG	ENGINEER
ESS EQ	ELECTRONIC SECURITY SYSTEM
FC	EQUAL FIBRE CEMENT
FCL	FINISHED CEILING LEVEL
FDD	FINAL DETAILED DESIGN
FFE	FURNITURE, FIXTURES & EQUIPMENT
FFL	FINISHED FLOOR LEVEL
FHR	FIRE HOSE REEL

FIRE INDICATOR PANEL

HYDRAULIC

HOT WATER UNIT

FIP

HYD

HWU

HV IDC IFC IMSB LV M MM MECH MGA MSR NIS NCC PFE RHS RL RWO SPEC S/S SHS SSL STR TBC TGSI TOW U/S WC WPM	HIGH VOLTAGE INTER DISCIPLINE CHECK ISSUED FOR CONSTRUCTION INSTALLATION MAIN SWITCH BOARD LOW VOLTAGE METER/S MILLIMETRES MECHANICAL MAP GRID OF AUSTRALIA MAIN SWITCHBOARD ROOM NOT IN SCOPE NATIONAL CONSTRUCTION CODE PORTABLE FIRE EXTINGUISHER RECTANGULAR HOLLOW SECTION RELATIVE LEVEL RAINWATER OUTLET SPECIFICATION STAINLESS STEEL SQUARE HOLLOW SECTION STRUCTURAL TO BE CONFIRMED TACTILE GROUND SURFACE INDICATOR TOP OF WALL UNDERSIDE WATER CLOSET WATERPROOF MEMBRANE
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# **GENERAL LEGEND**

	EXISTING
	DEMOLISHED
-⁄~-	BREAKLINE
X XXXX	CALLOUT MARKER X REFER TO SHEET XXXX FOR DETAILS
X XXXX	ELEVATION / SECTION MARKER X REFER TO SHEET XXXX FOR DETAILS
XXXX	FINISHES CODE REFER TO FINISHES SCHEDULE FOR D
x ┥ xxxx	INTERNAL ELEVATION MARKER X REFER TO SHEET XXXX FOR DETAILS



# PROJECT **BOB PRENTER RESERVE AMENITY BUILDING**

PROJECT ADDRESS Fields Rd, Macquarie Fields NSW 2564

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STATUS CONCEPT DESIGN **SCALES** 1 : 20 @ A1


DRAWING NO. **BPR-DIS-AR-DRG-0004** 



TITLE **GENERAL NOTES - SHEET 2** 

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DETAILS

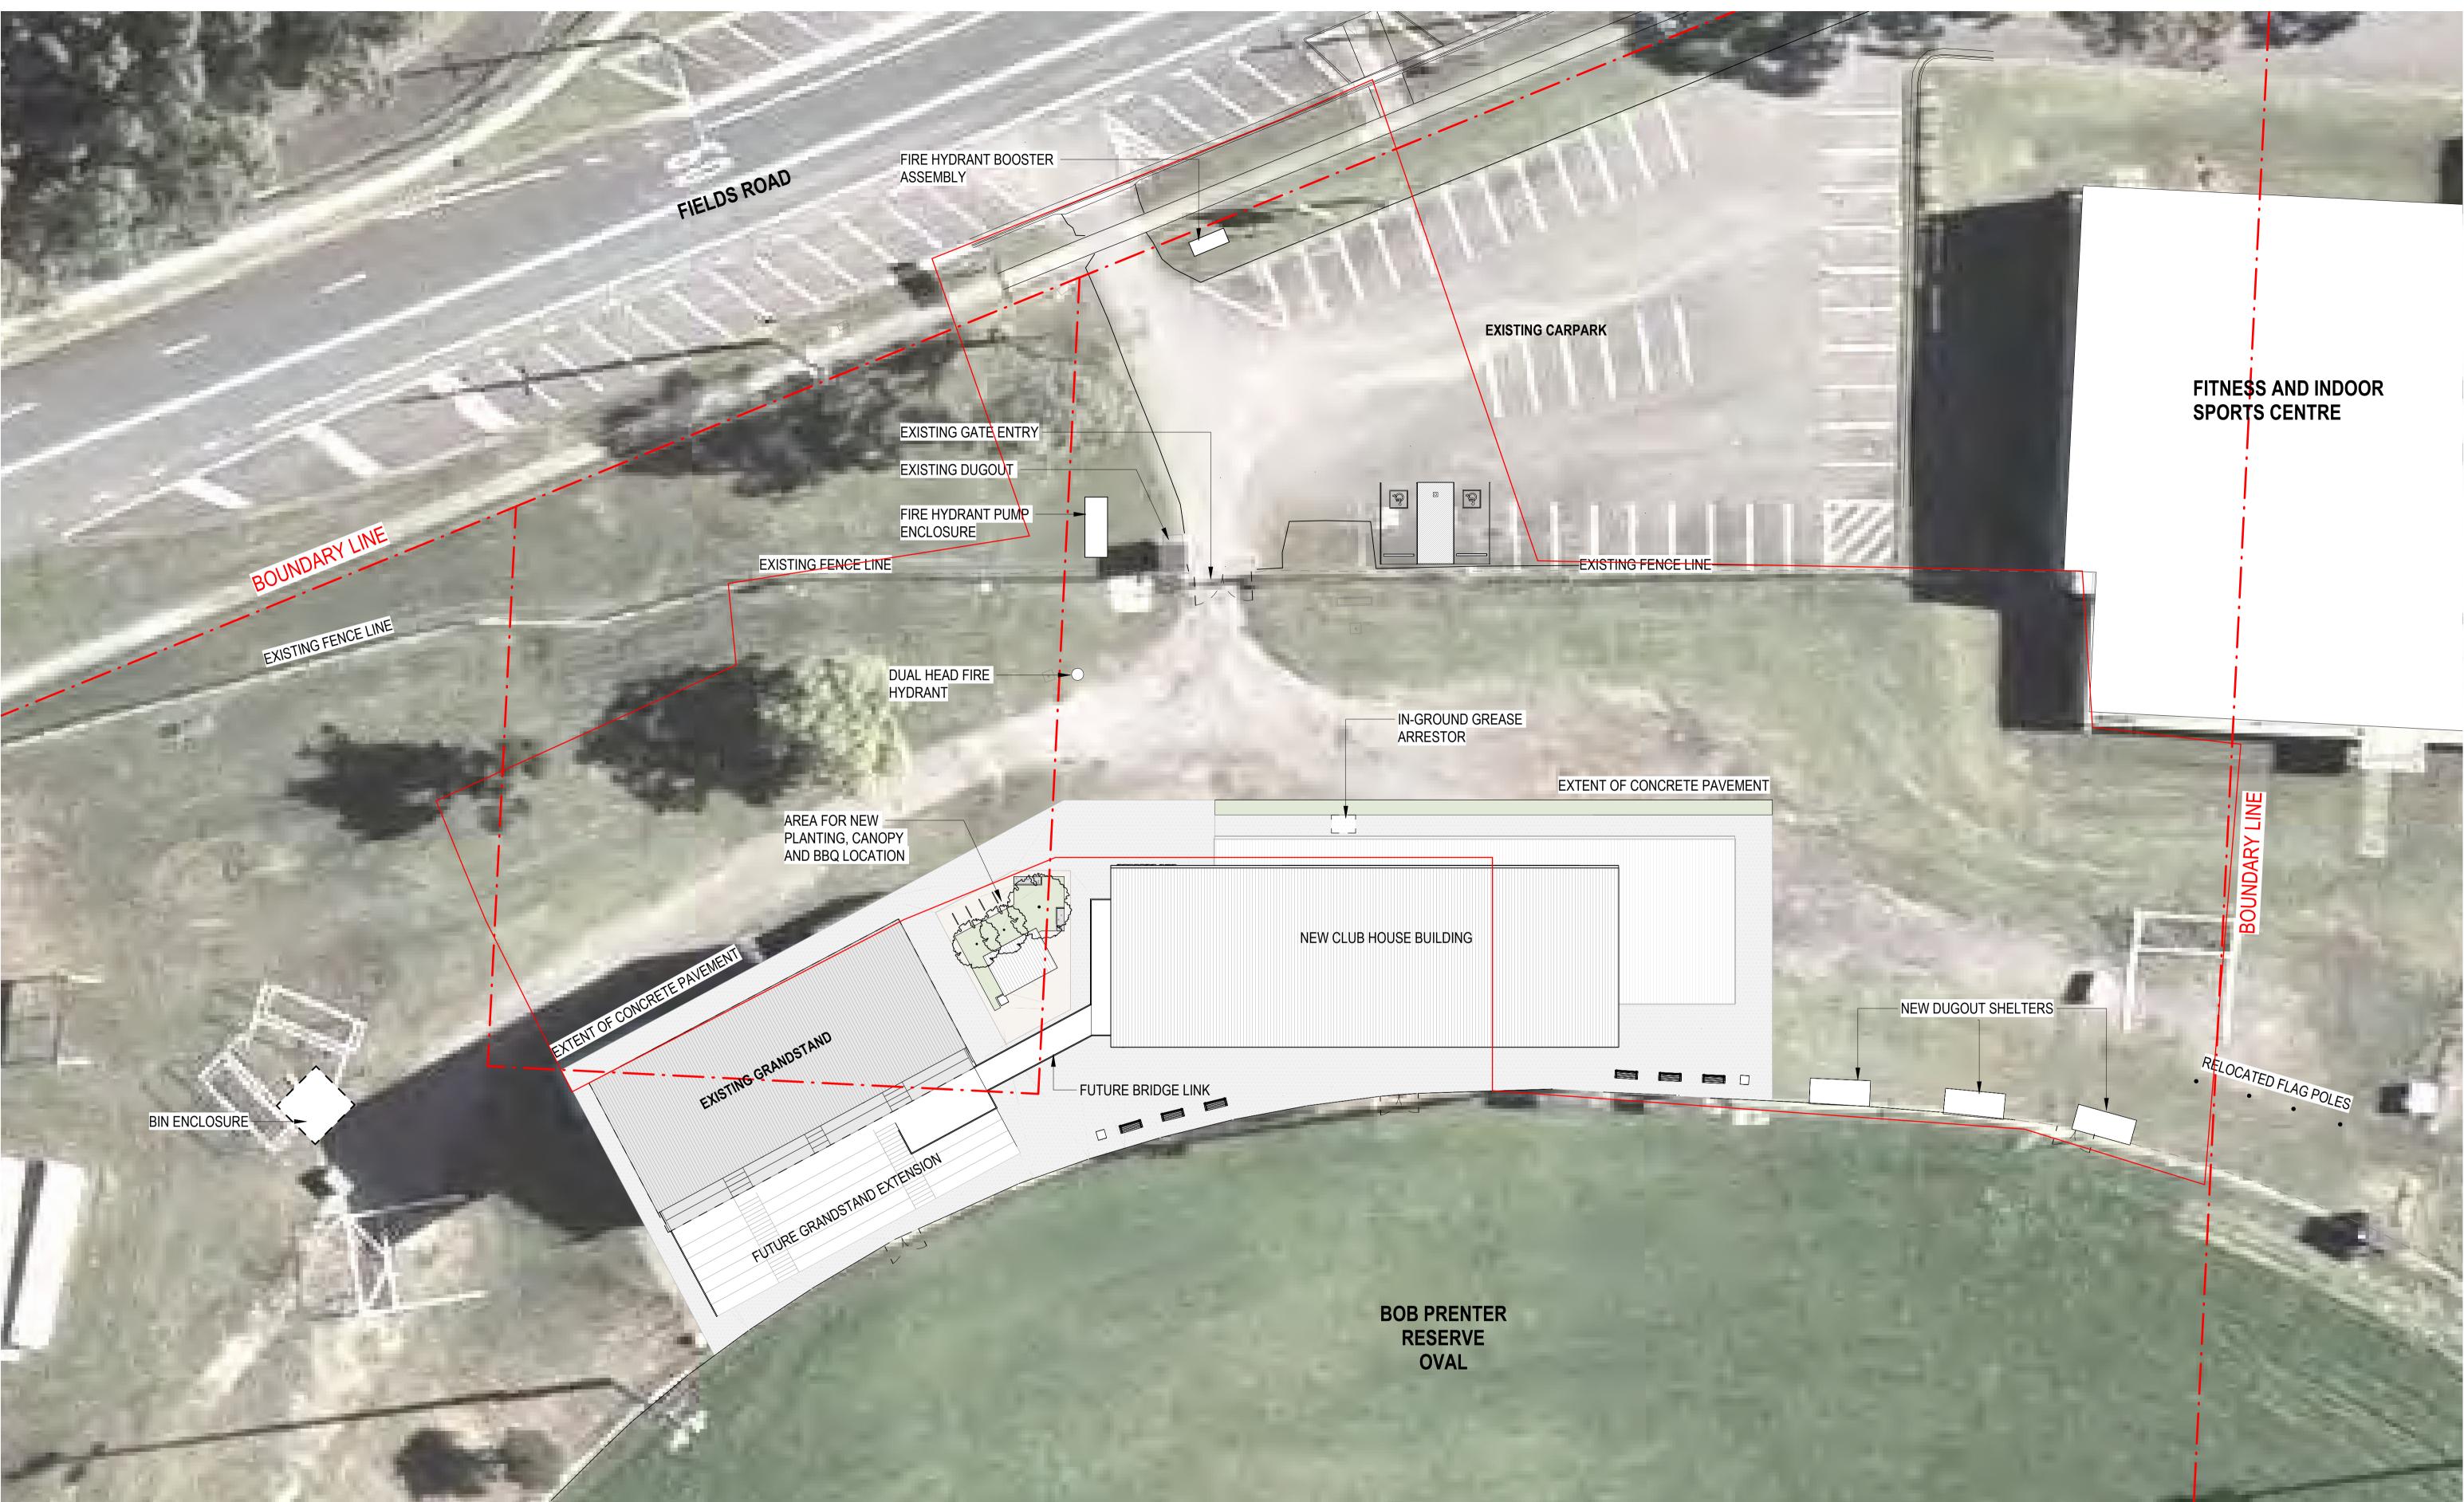

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**Nominated Architects** Ian Armstrong7260Cathryn Drew-Bredin7269Cameron Martin9194Mary Anne McGirr10946 PLOTTED : 9/12/2024 11:02:47 AM Autodesk Docs://P24-100 Bob Prenter Reserve Macquarie Fields/P24-100-AR-Bob Prenter Reserve Macquarie Fields.nvt



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DRAWING NO.

**BPR-DIS-AR-DRG-0005** 

REVISION A

SITE PLAN



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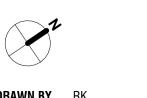
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FITNESS AND INDOOR SPORTS CENTRE



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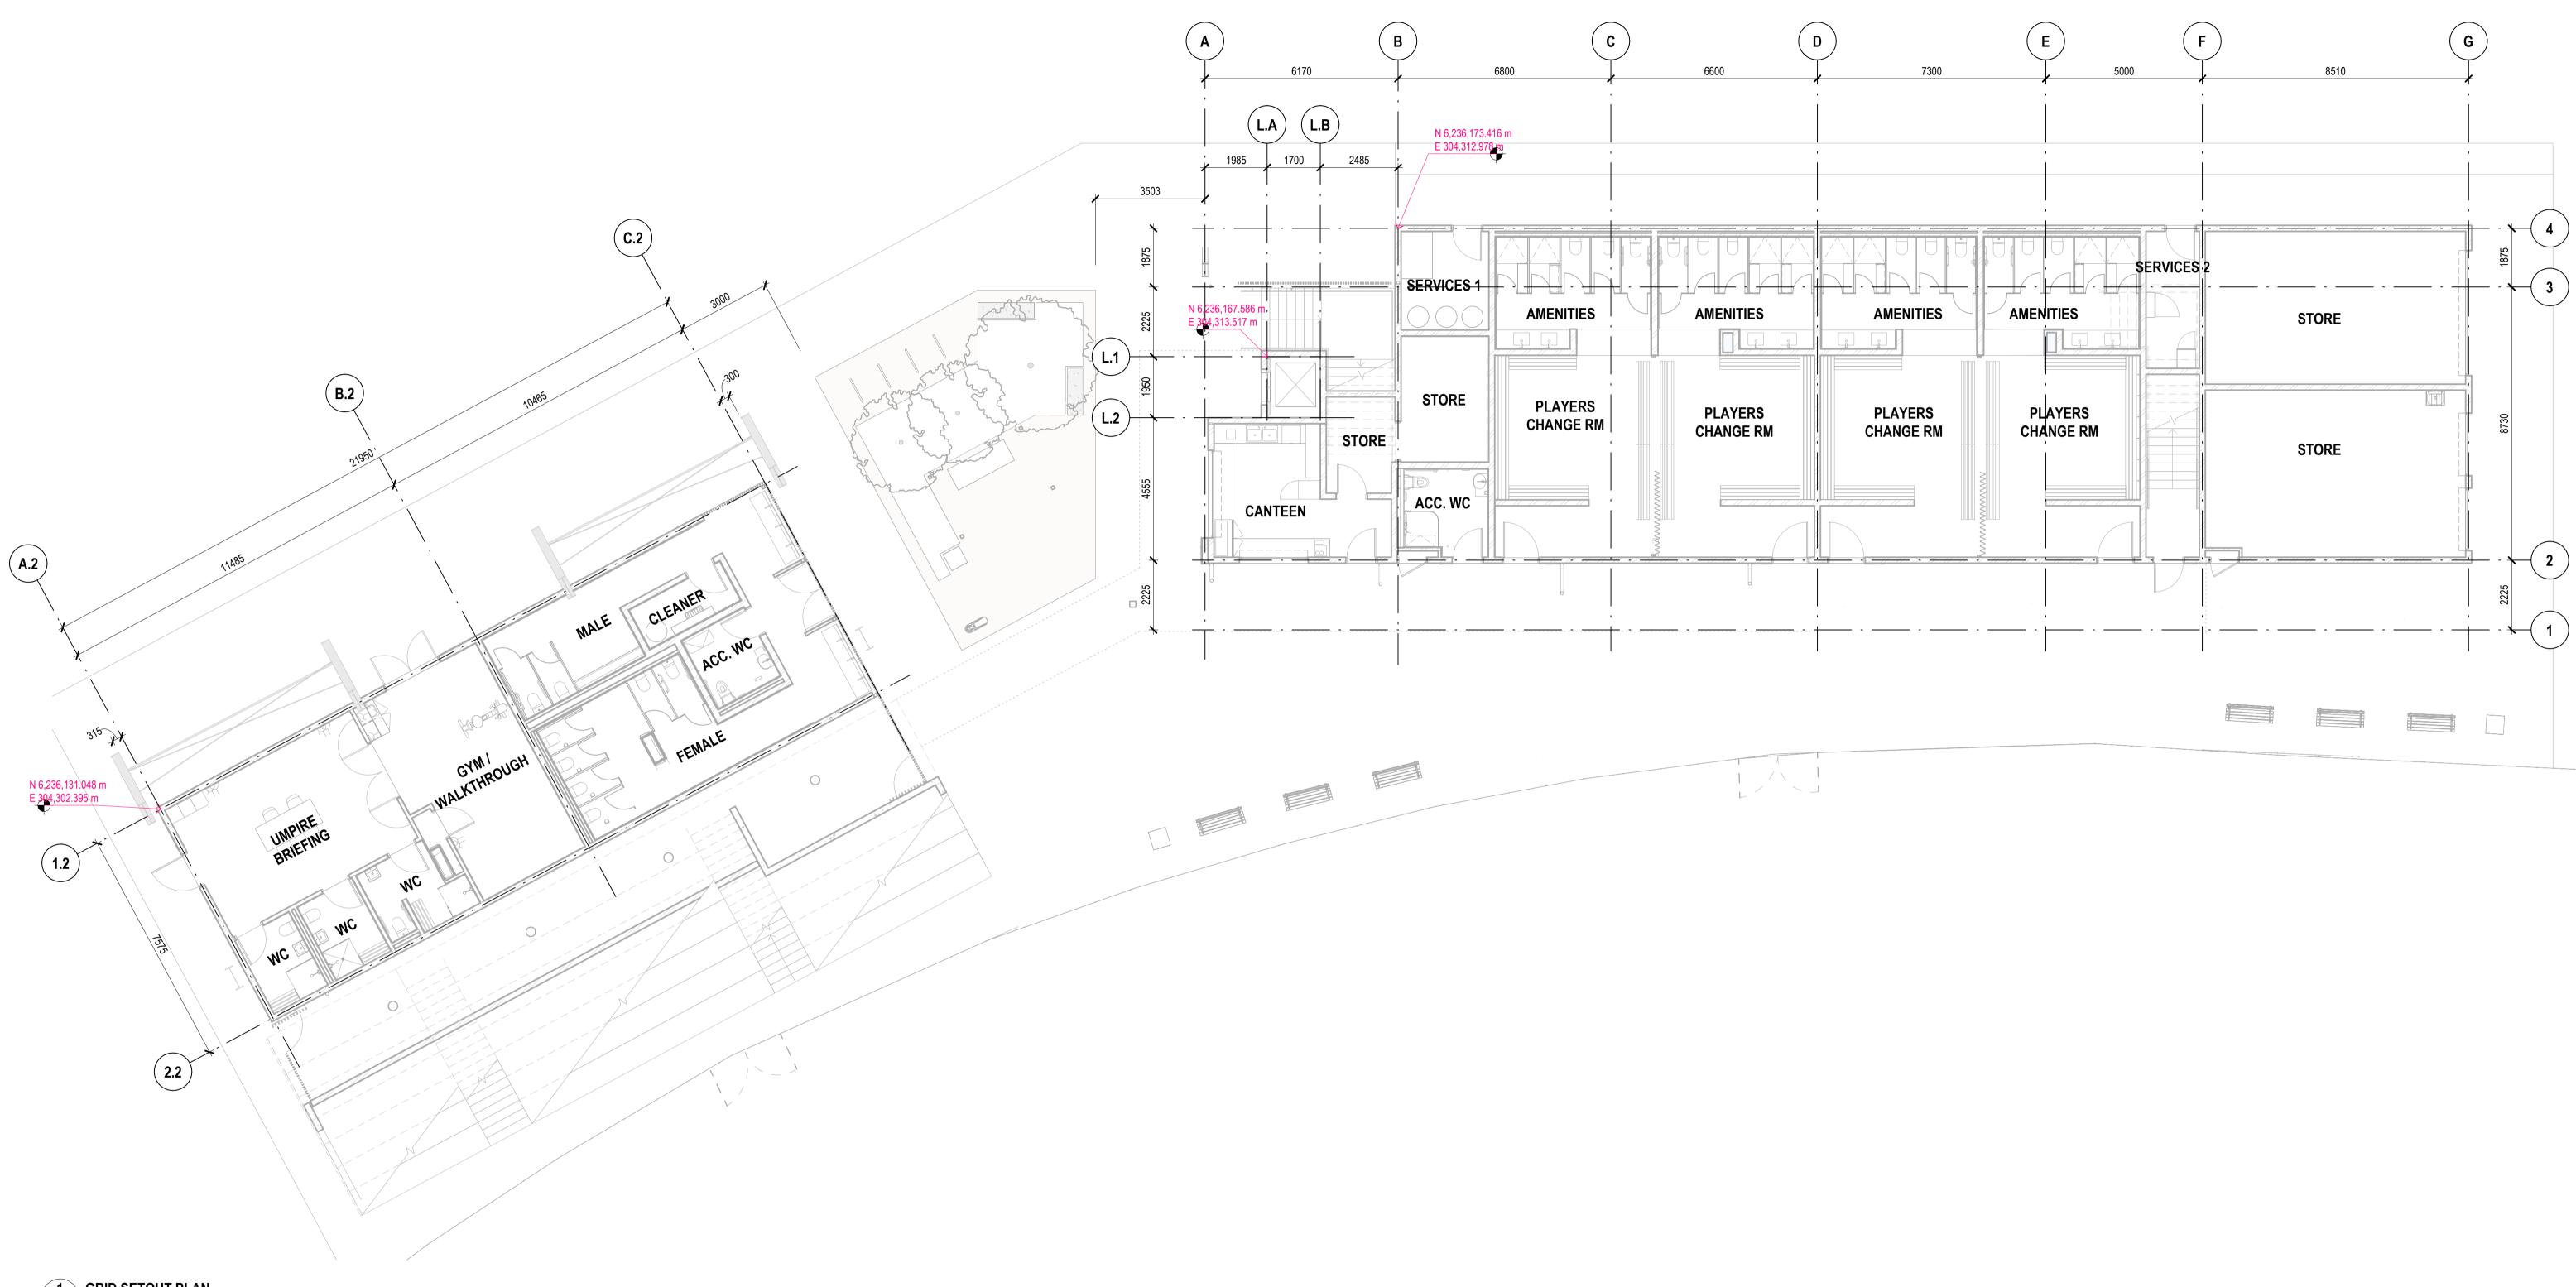
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STATUS CONCEPT DESIGN **SCALES** 1 : 200 @ A1

ALC: NO.

DRAWING NO. **BPR-DIS-AR-DRG-0006** 





**1** GRID SETOUT PLAN

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STATUS CONCEPT DESIGN

**SCALES** 1 : 100 @ A1

DRAWING NO. **BPR-DIS-AR-DRG-0010** 



**GRID SETOUT PLAN** 



PERSPECTIVE TOWARDS FORECOURT ENTRY



PERSPECTIVE FROM PLAYING FIELD

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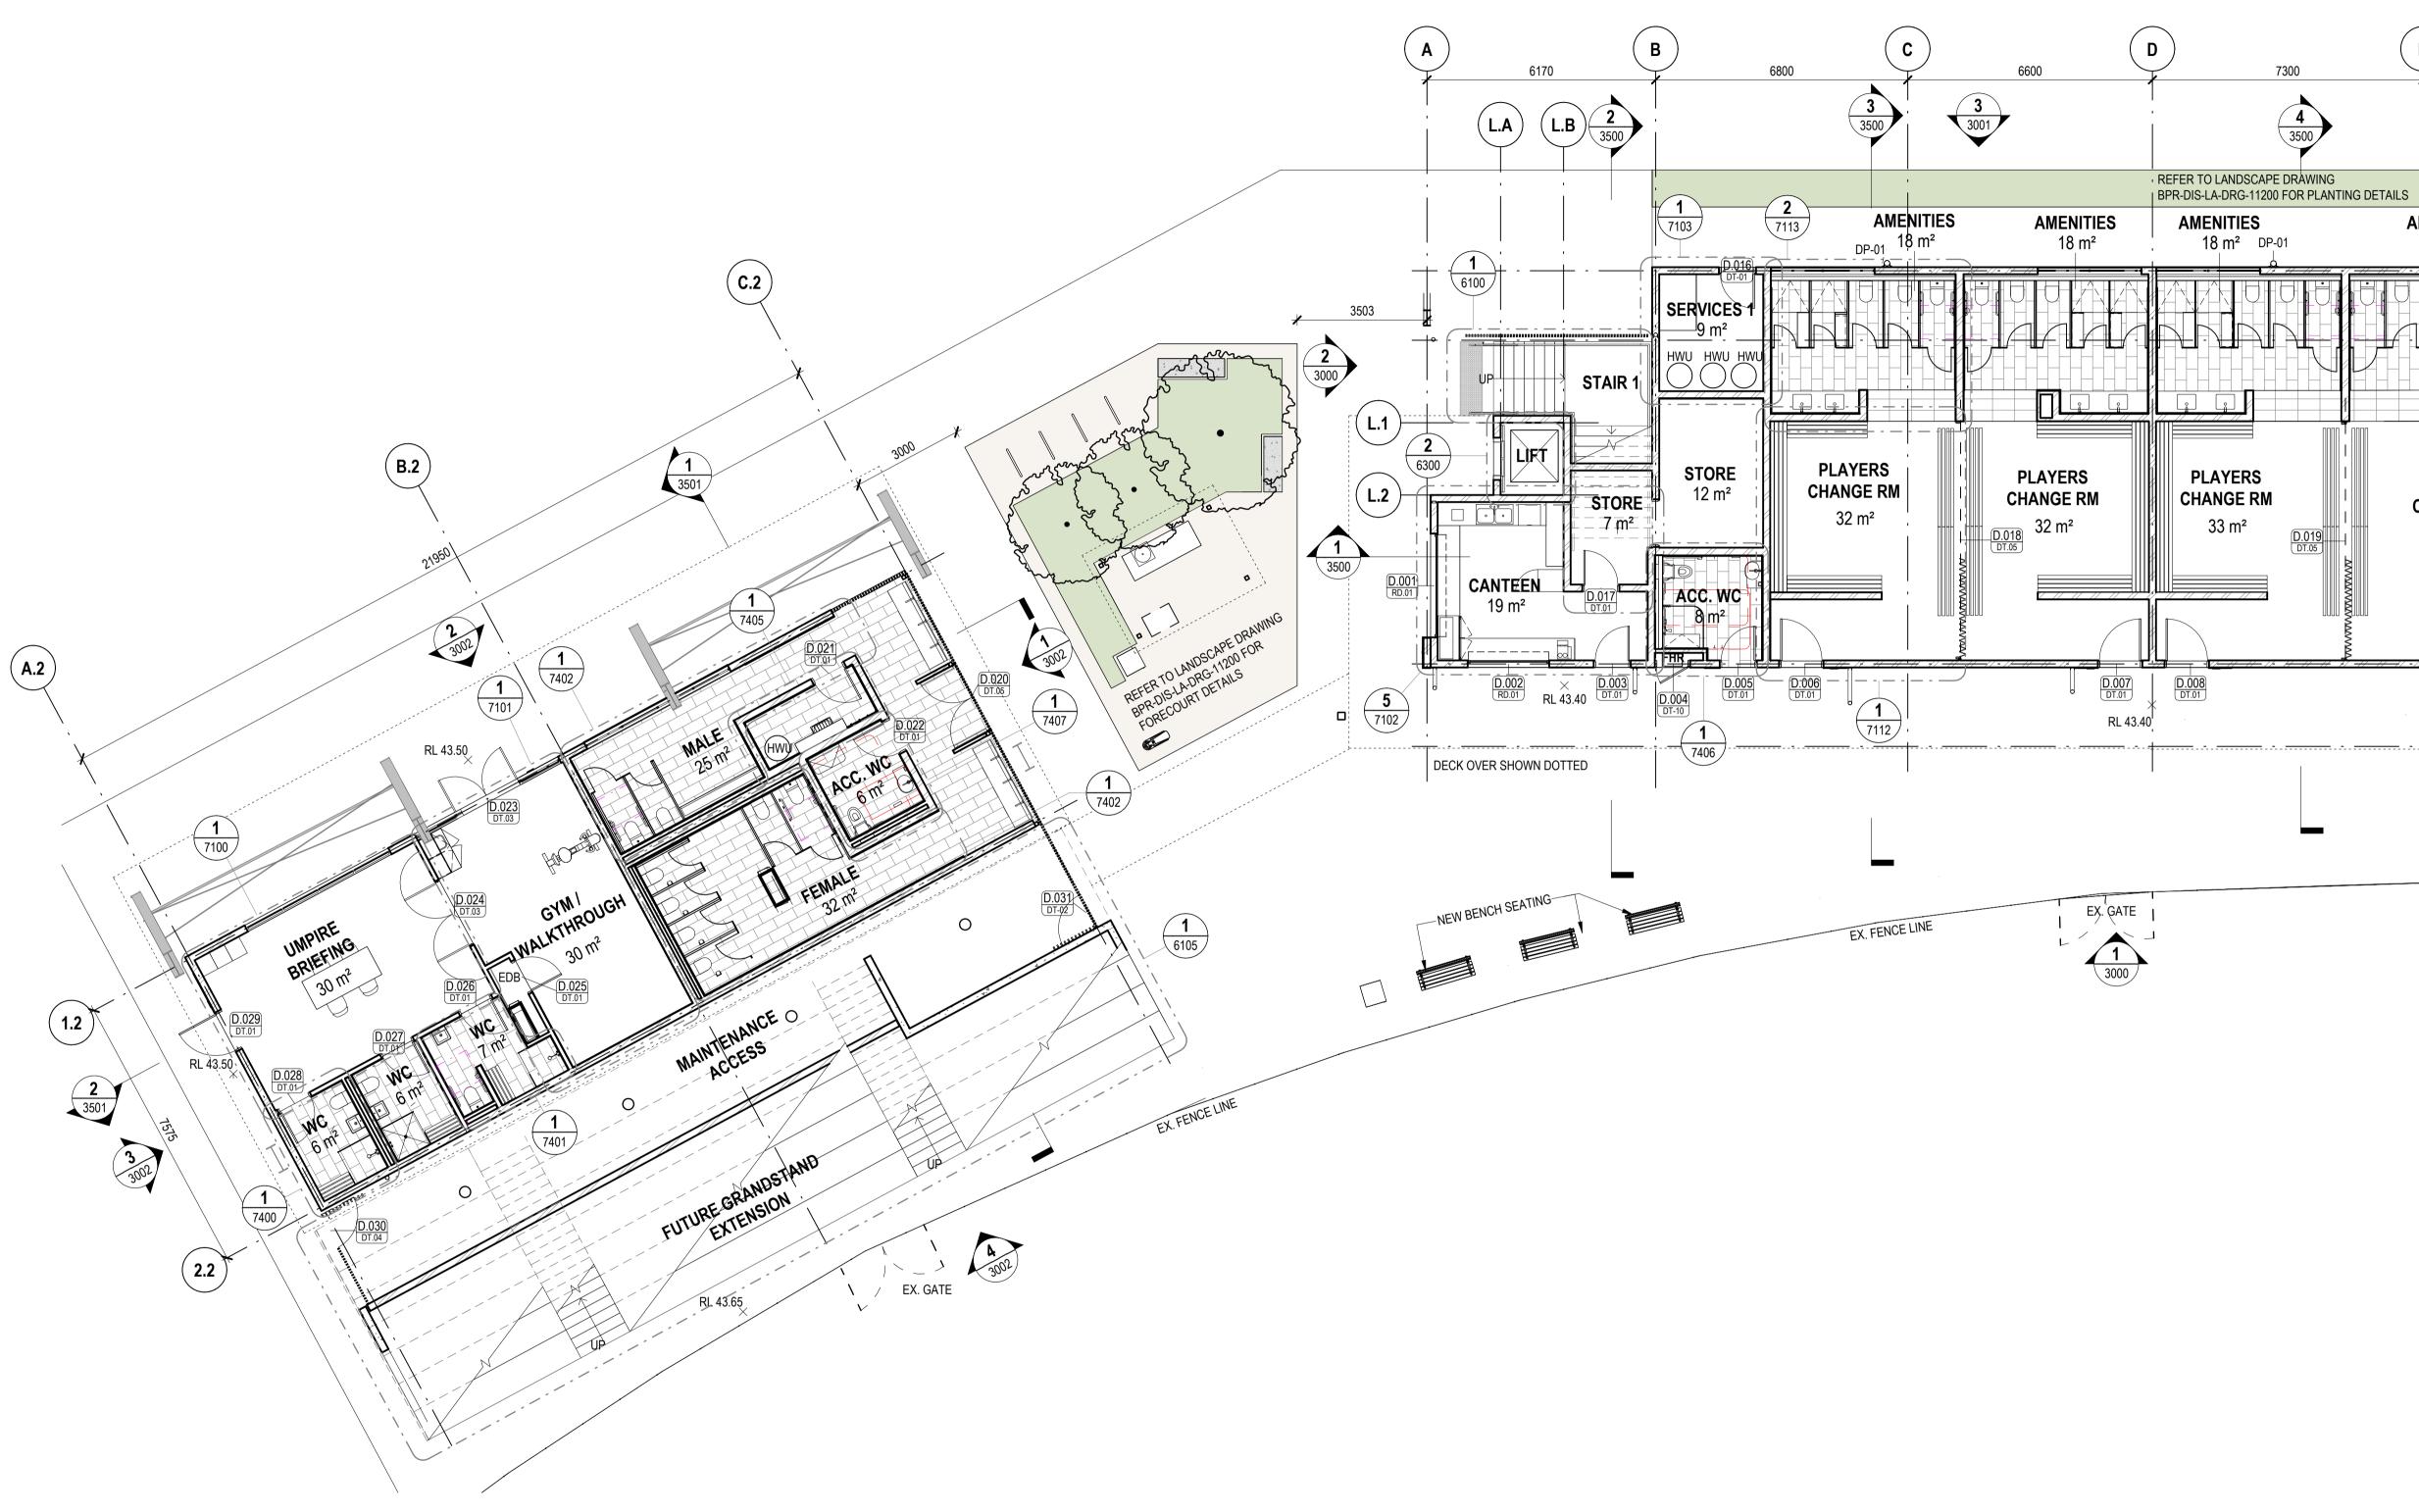
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0 2 4 6 8 10 **TITLE** SCALE BAR - 1:200

> DRAWING NO. **BPR-DIS-AR-DRG-0090**



PERSPECTIVES



(1

GENERAL ARRANGEMENT PLAN - GROUND FLOOR SCALE 1:100

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G F Е 5000 8510 SERVICES 2 8 m<sup>2</sup> AMENITIES 18 m<sup>2</sup> **1** 7104 DP-01 STORE 41 m<sup>2</sup> D.014 RD.02 STAIR 2 PLAYERS 4 3001 CHANGE RM 1 \ D.013 RD-02 6102 STORE 45 m<sup>2</sup> 32 m² D.012 RD-02 E A 2 D.009 DT.01 D.010 DT.01 D.01 -NEW BENCH SEATING-EX. FENCE LINE

> **DRAWING TO BE PRINTED IN COLOUR** TITLE **GENERAL ARRANGEMENT PLAN -**

NOT FOR CONSTRUCTION


**A** 

0 1 2 3 4 5 SCALE BAR - 1:100

STATUS CONCEPT DESIGN **SCALES** 1 : 100 @ A1

**GROUND FLOOR** DRAWING NO. **BPR-DIS-AR-DRG-1200** 

REVISION Α

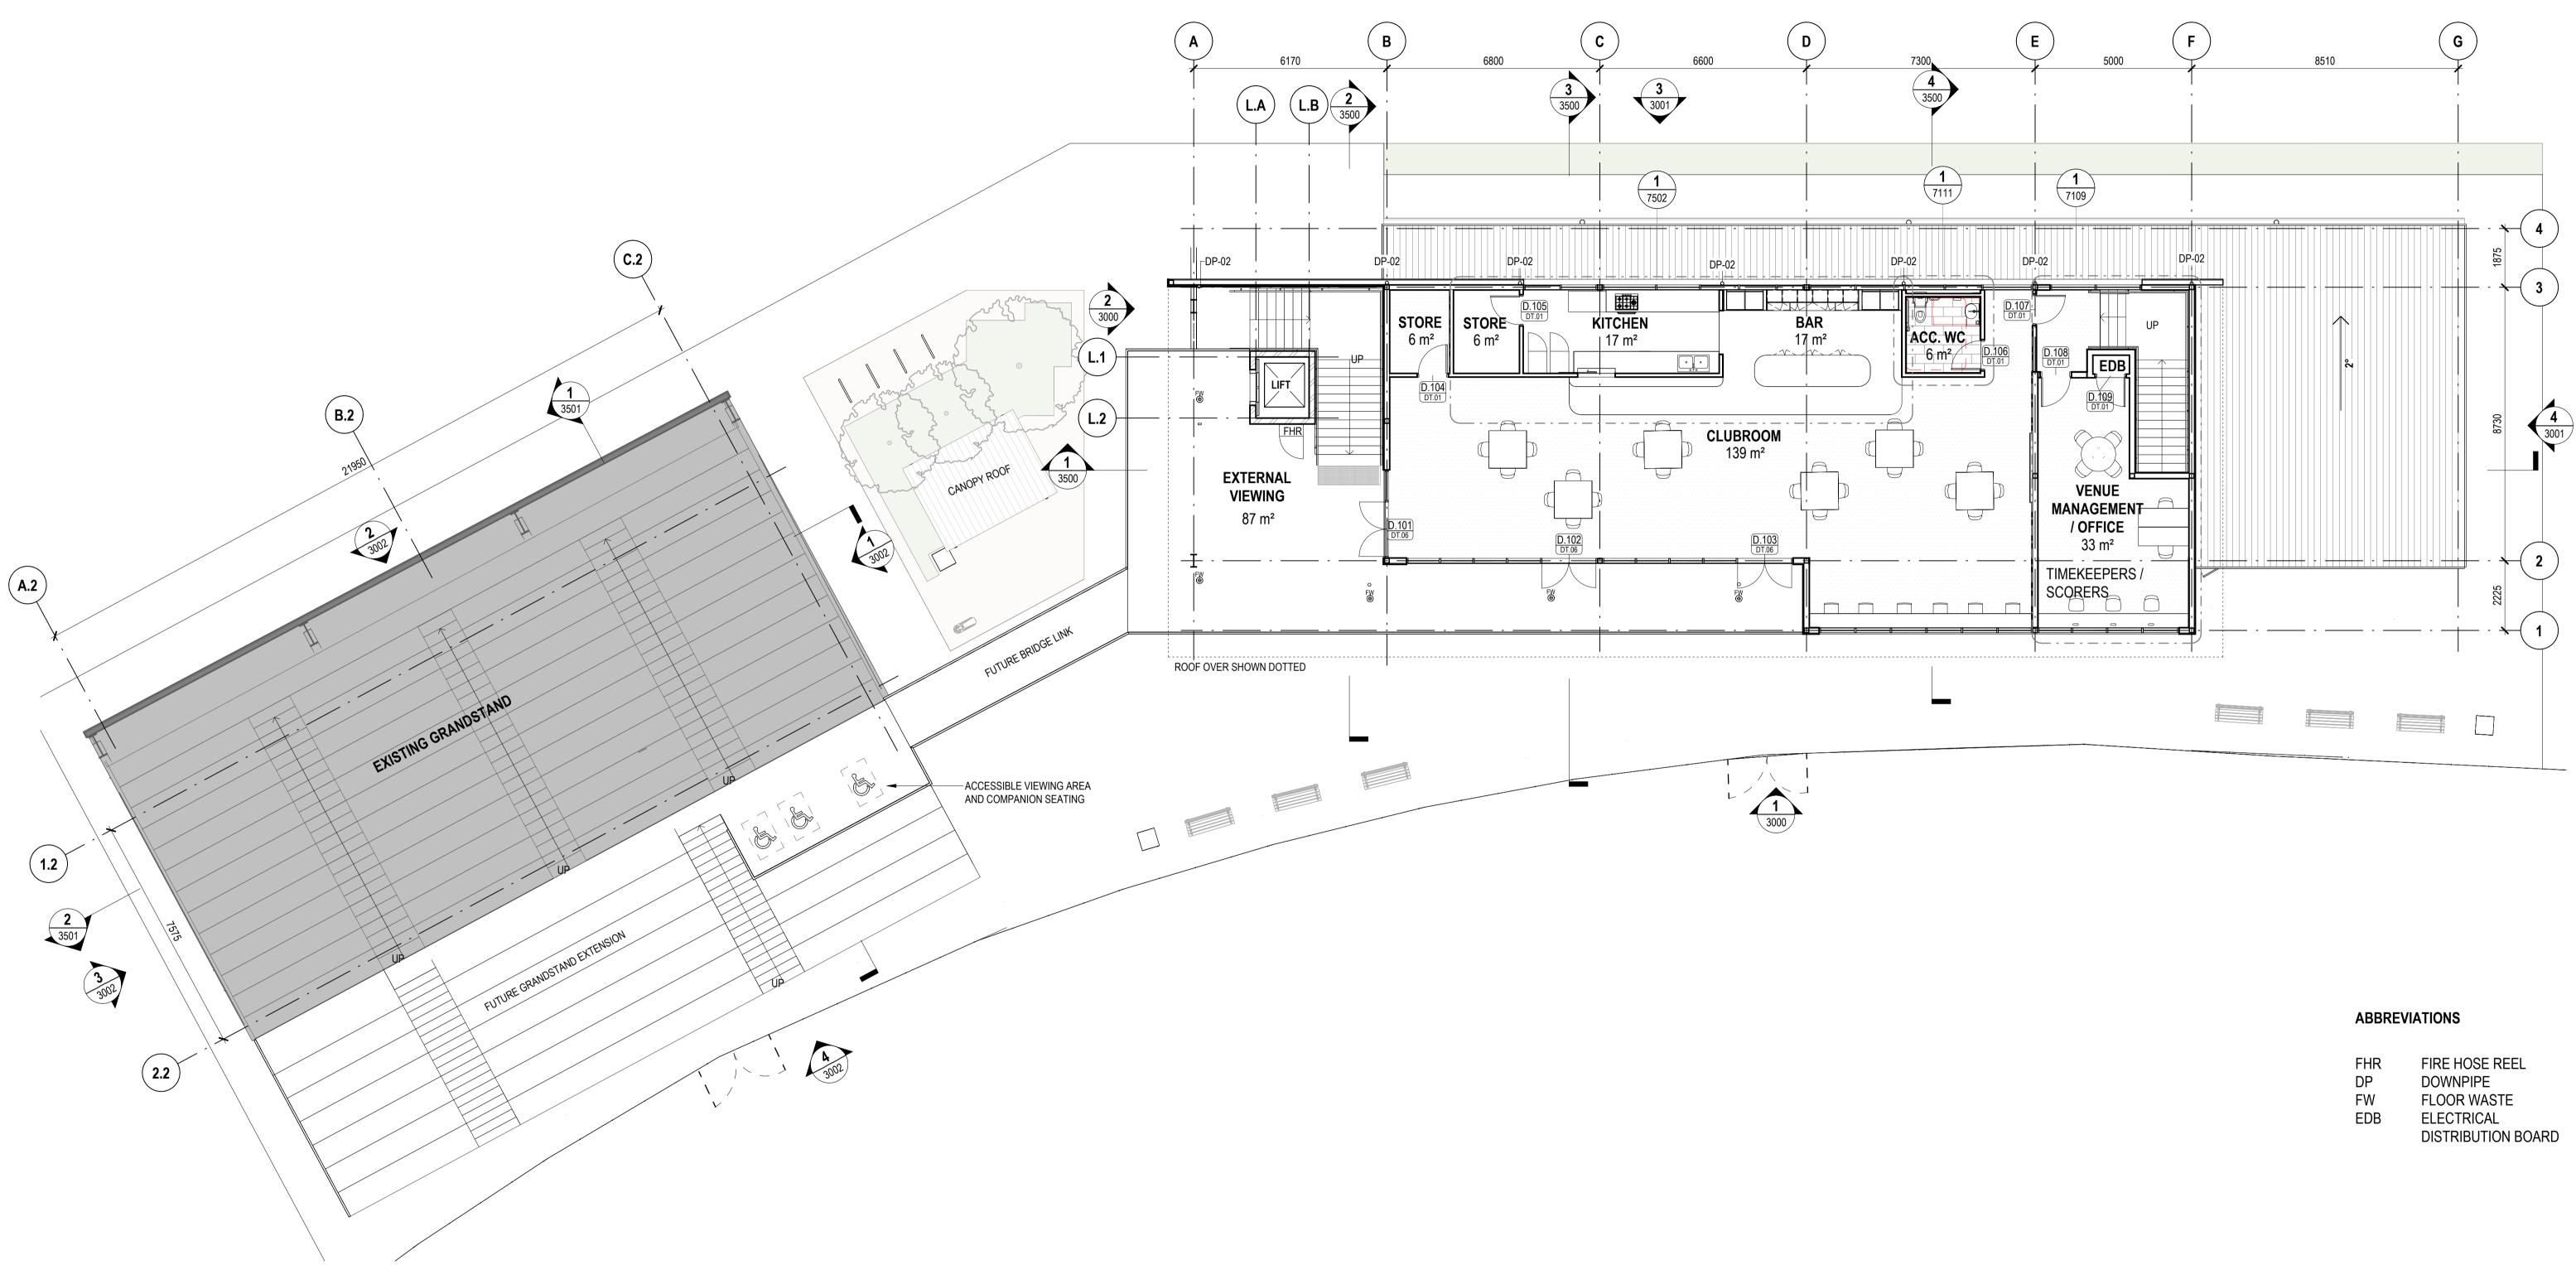

**1** GENERAL ARRANGEMENT PLAN - LEVEL 1

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Cameron Martin 9194 Mary Anne McGirr 10946

**Nominated Architects** 

PLOTTED : 9/12/2024 11:03:09 AM

lan Armstrong



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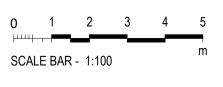
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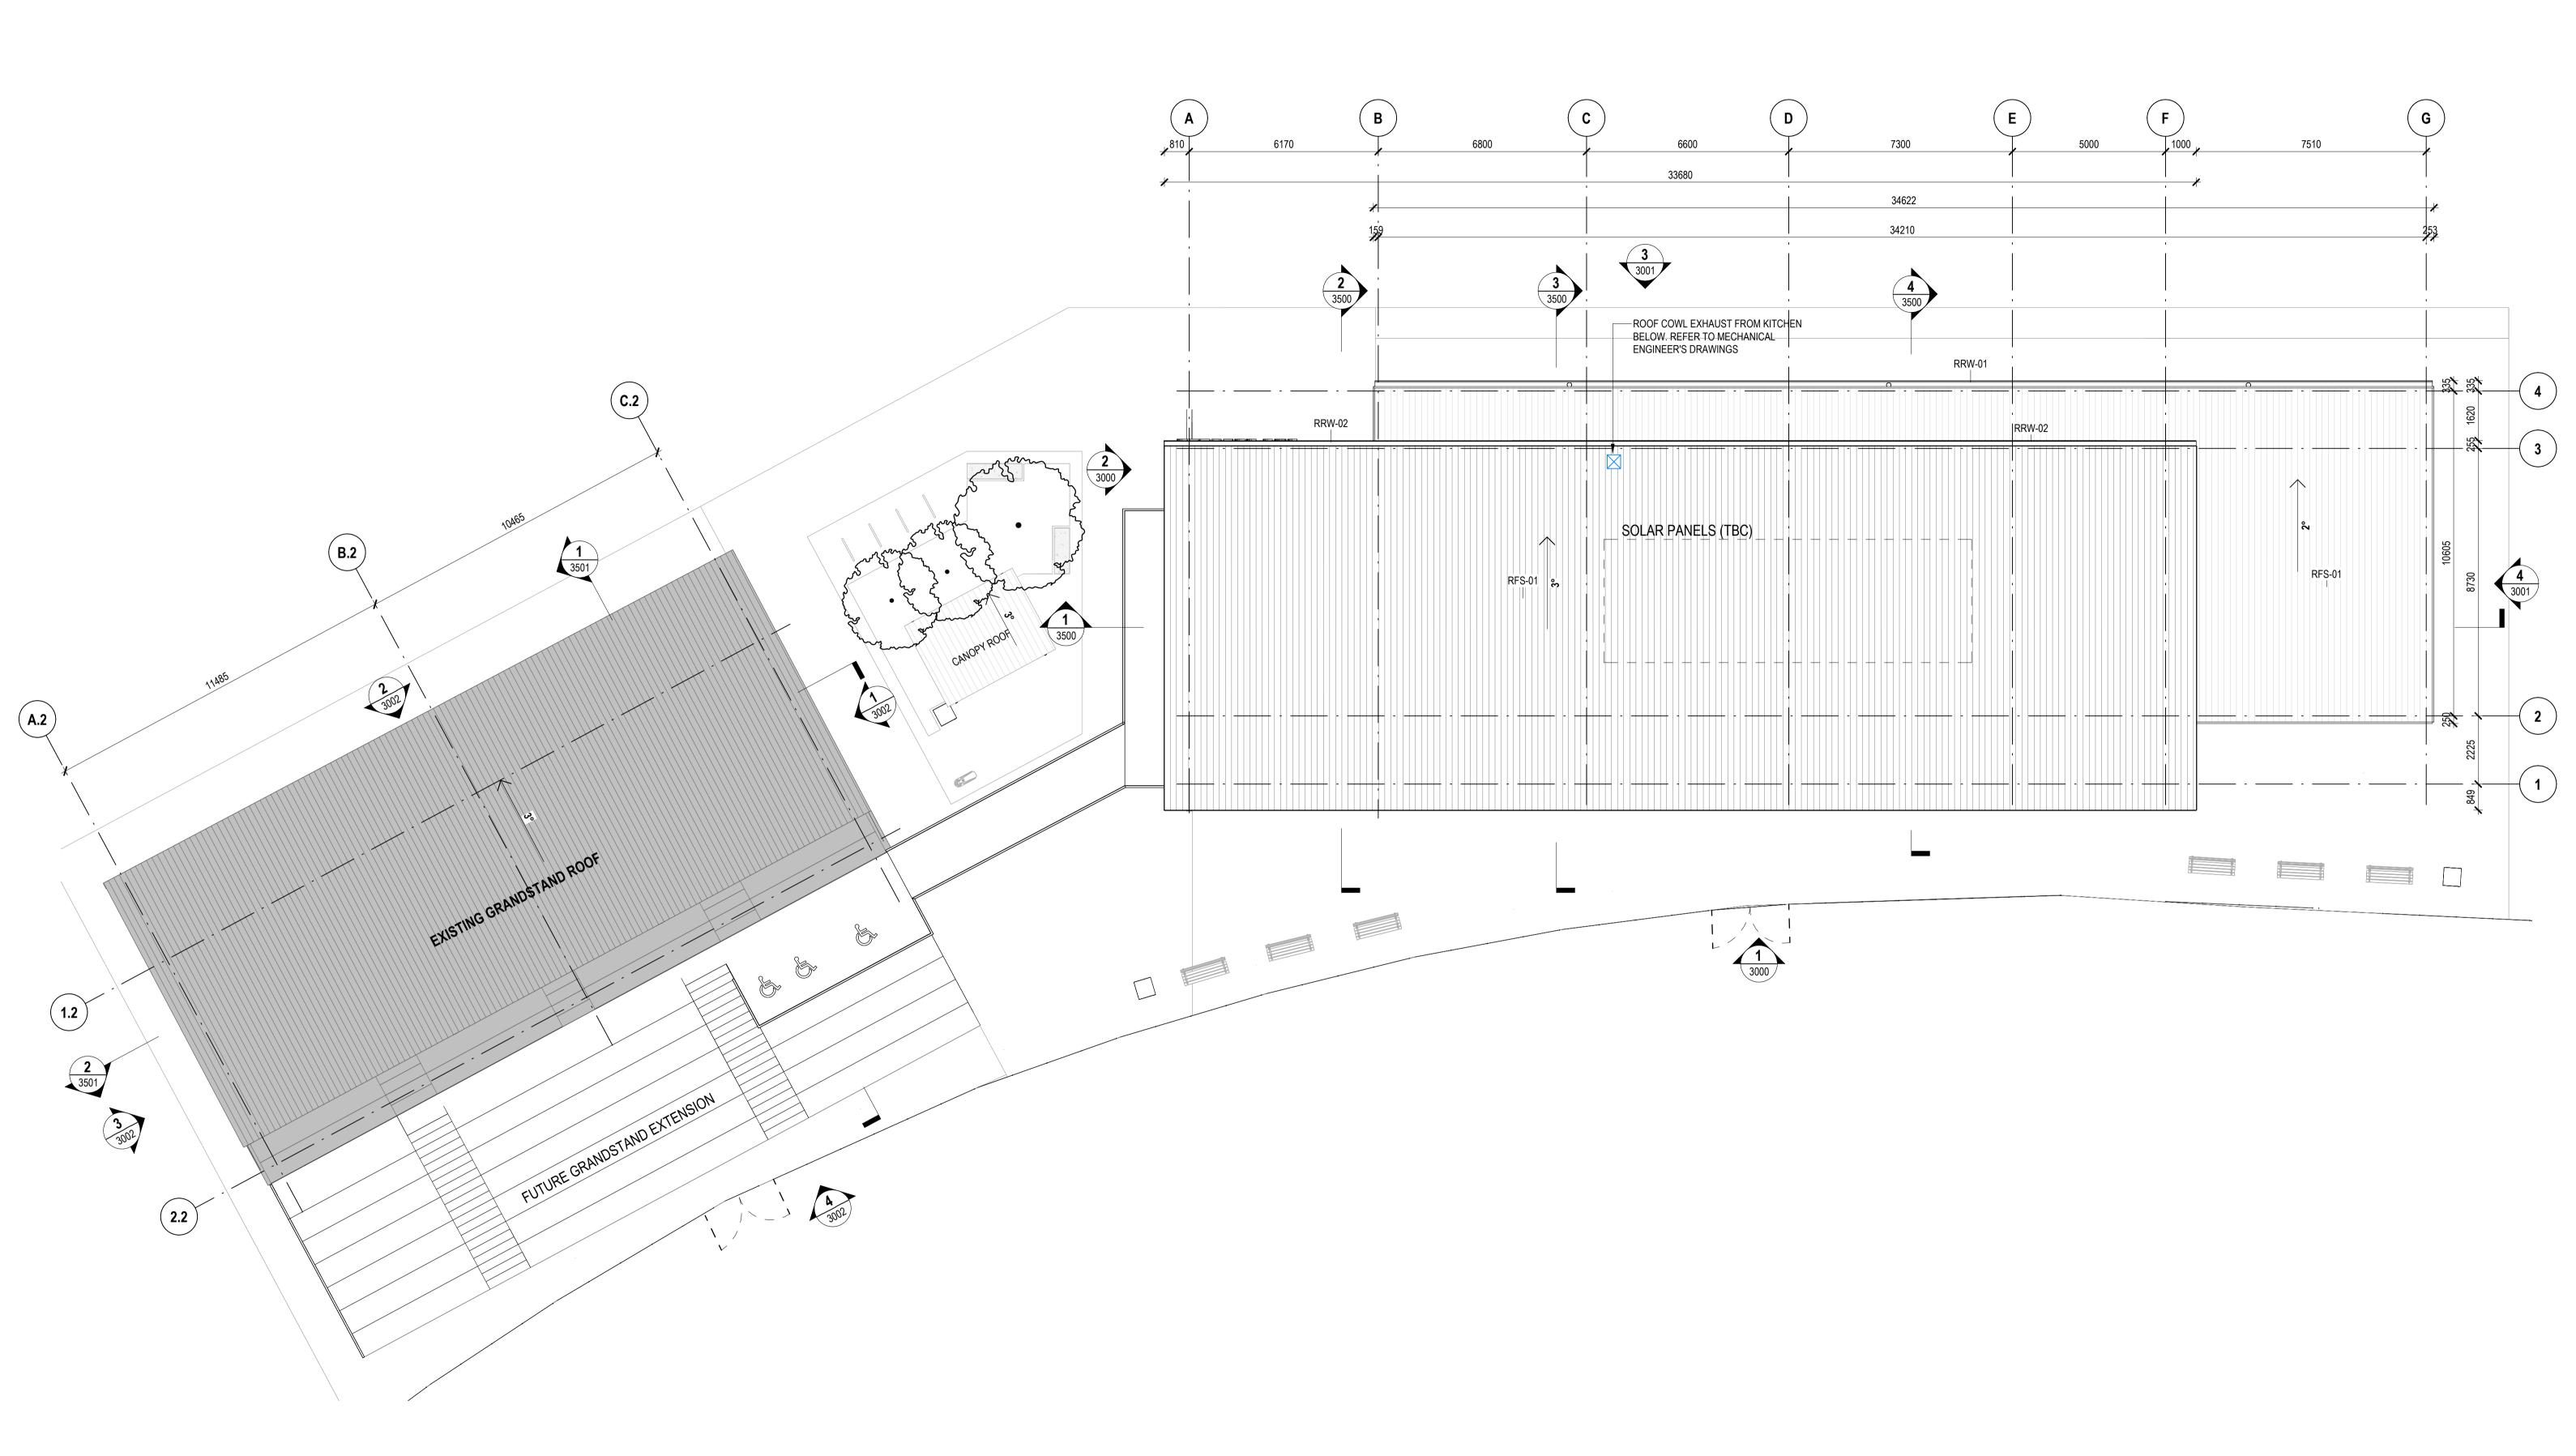
FHR	FIRE HOSE REEL
DP	DOWNPIPE
FW	FLOOR WASTE
EDB	ELECTRICAL
	DISTRIBUTION BOARD





STATUS CONCEPT DESIGN SCALES As indicated @ A1 TITLE **GENERAL ARRANGEMENT PLAN -**LEVEL 1 DRAWING NO. REVISION **BPR-DIS-AR-DRG-1201** 







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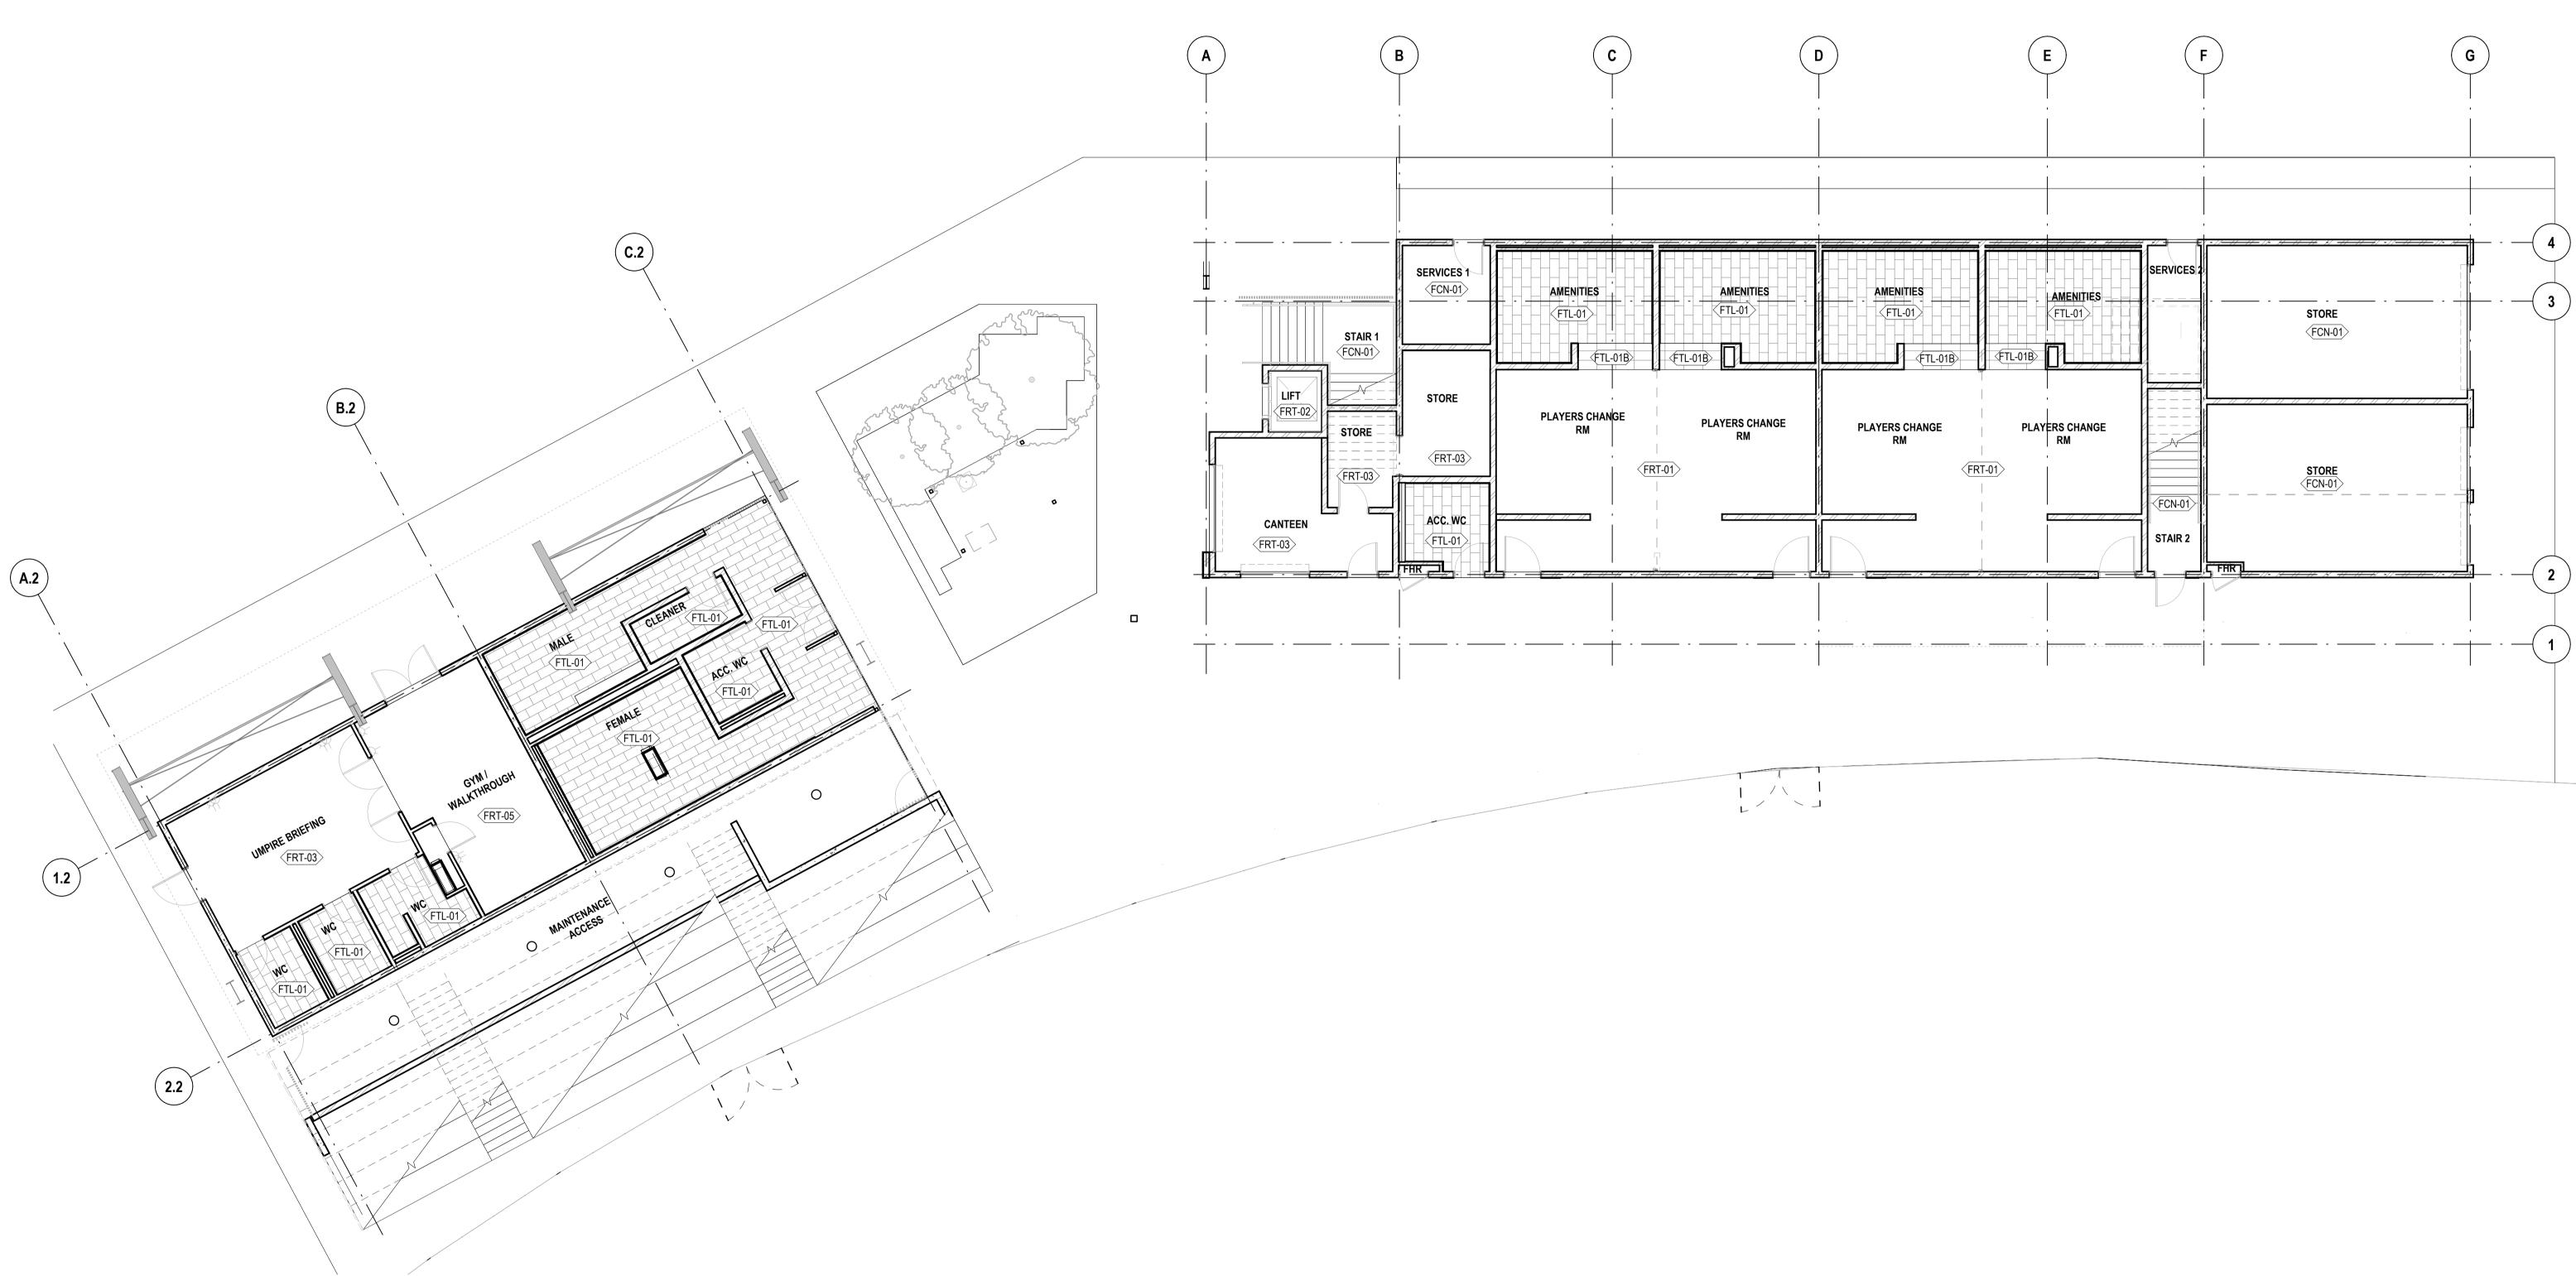
# WORK-IN-PROGRESS

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0 1 2 3 4 5 SCALE BAR - 1:100

STATUS CONCEPT DESIGN **SCALES** 1 : 100 @ A1

TITLE **GENERAL ARRANGEMENT PLAN -**ROOF DRAWING NO. REVISION **BPR-DIS-AR-DRG-1202** Α



FINISHES PLAN - GROUND FLOOR

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STATUS CONCEPT DESIGN

**SCALES** 1 : 100 @ A1

**FINISHES PLAN - GROUND FLOOR** 


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REVISION

Α

TITLE

DRAWING NO.

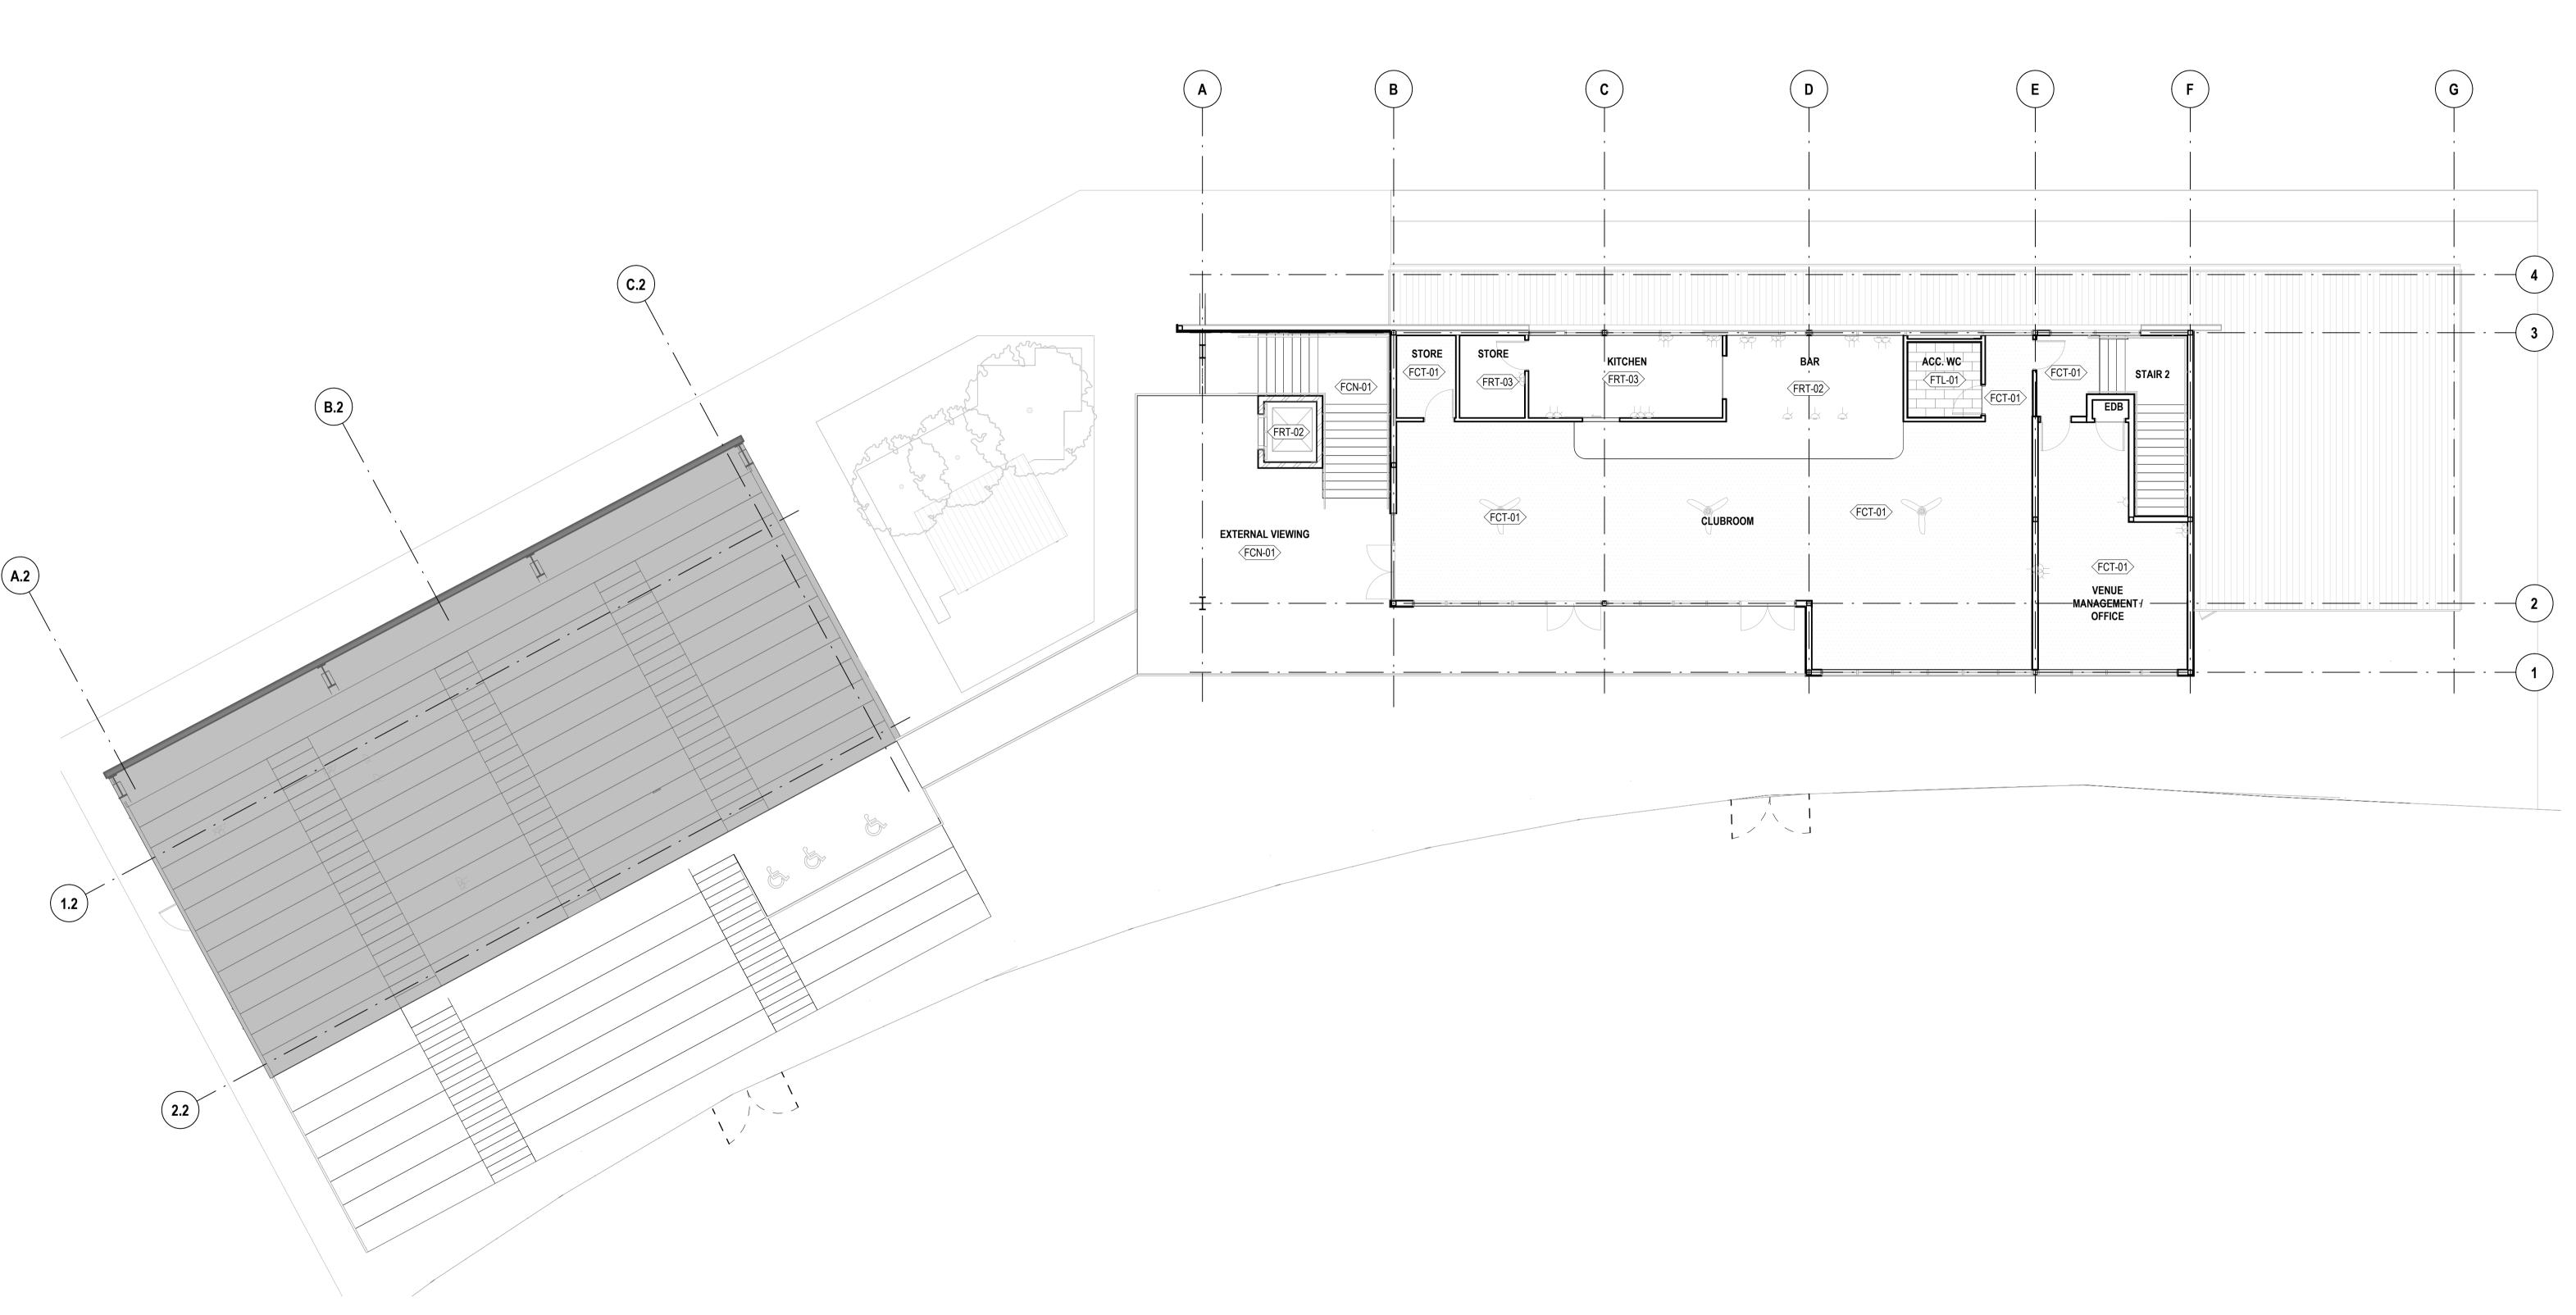

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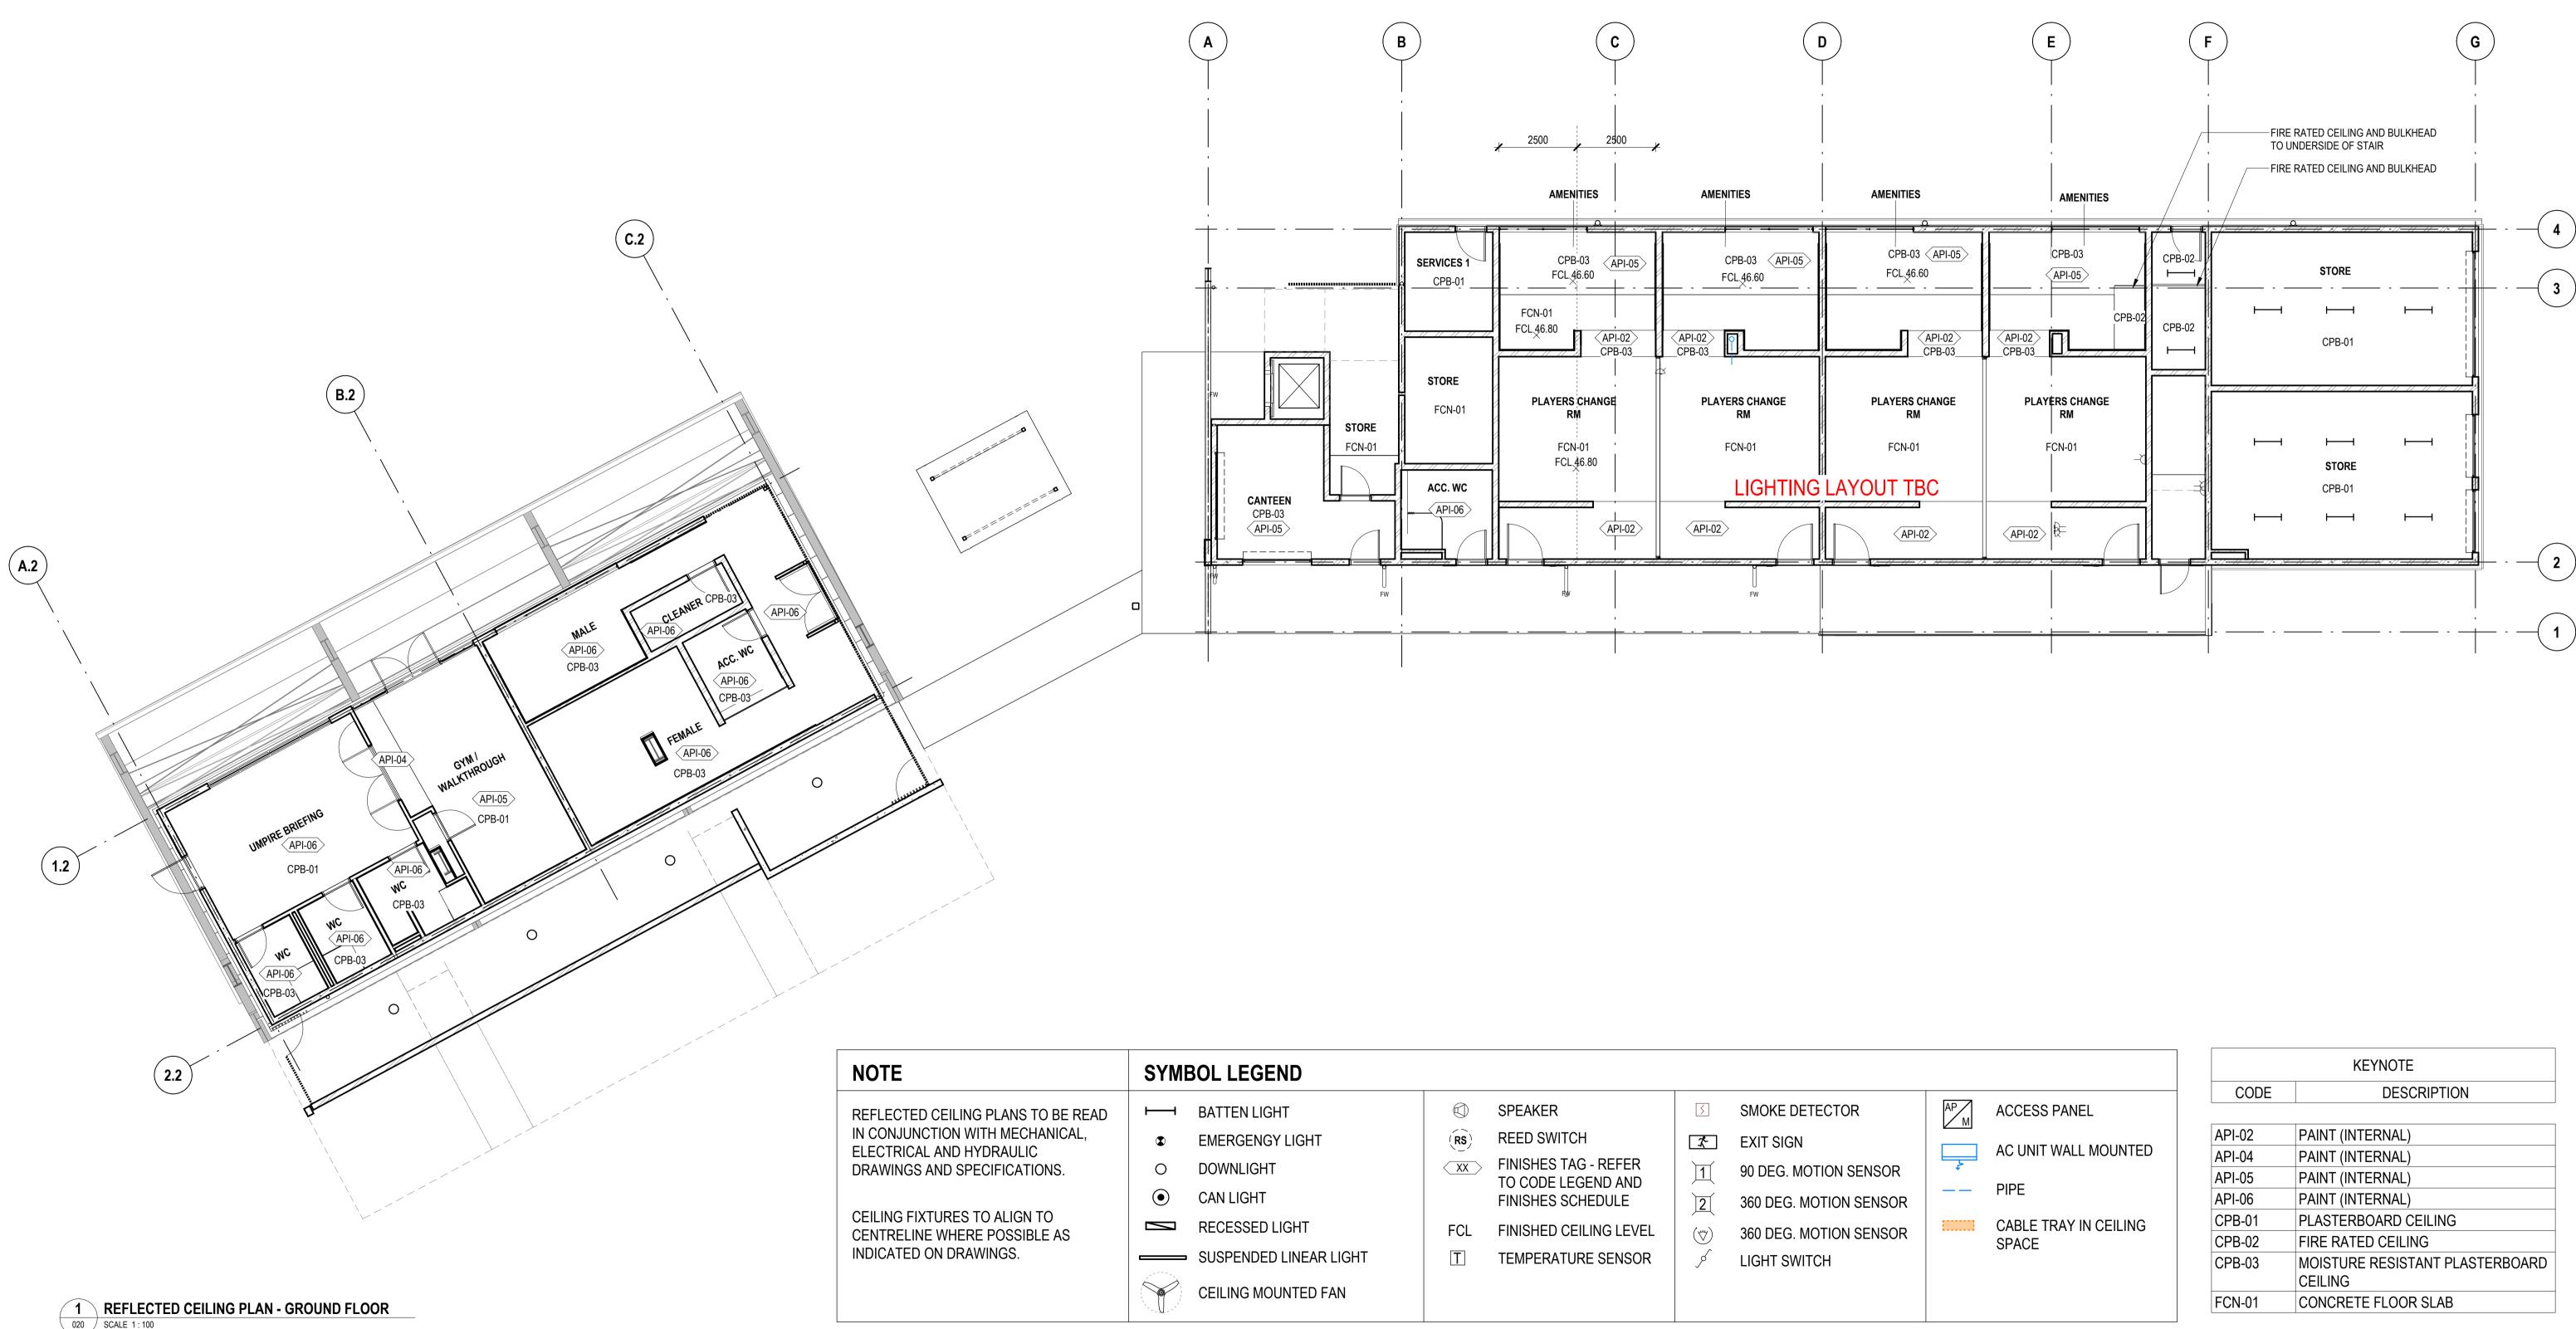


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STATUS CONCEPT DESIGN **SCALES** 1 : 100 @ A1

DRAWING NO. BPR-DIS-AR-DRG-1301 REVISION A

TITLE FINISHES PLAN - LEVEL 1



020 SCALE 1:100

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	SYMBOL LEGEND					
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YDRAULIC ECIFICATIONS.	<ul> <li>EMERGENGY LIGHT</li> <li>DOWNLIGHT</li> </ul>		FINISHES TAG - REFER TO CODE LEGEND AND FINISHES SCHEDULE	1       2	EXIT SIGN 90 DEG. MOTION SENSOR	<u>ح</u> 
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KEYNOTE					
CODE	DESCRIPTION				
API-02	PAINT (INTERNAL)				
API-04	PAINT (INTERNAL)				
API-05	PAINT (INTERNAL)				
API-06	PAINT (INTERNAL)				
CPB-01	PLASTERBOARD CEILING				
CPB-02	FIRE RATED CEILING				
CPB-03	MOISTURE RESISTANT PLASTERBOARD				
	CEILING				
FCN-01	CONCRETE FLOOR SLAB				


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STATUS CONCEPT DESIGN SCALES As indicated @ A1

REVISION Α



IN CONJUNCTION WITH ELECTRICAL AND HYD DRAWINGS AND SPEC

**CEILING FIXTURES TO** CENTRELINE WHERE INDICATED ON DRAWI
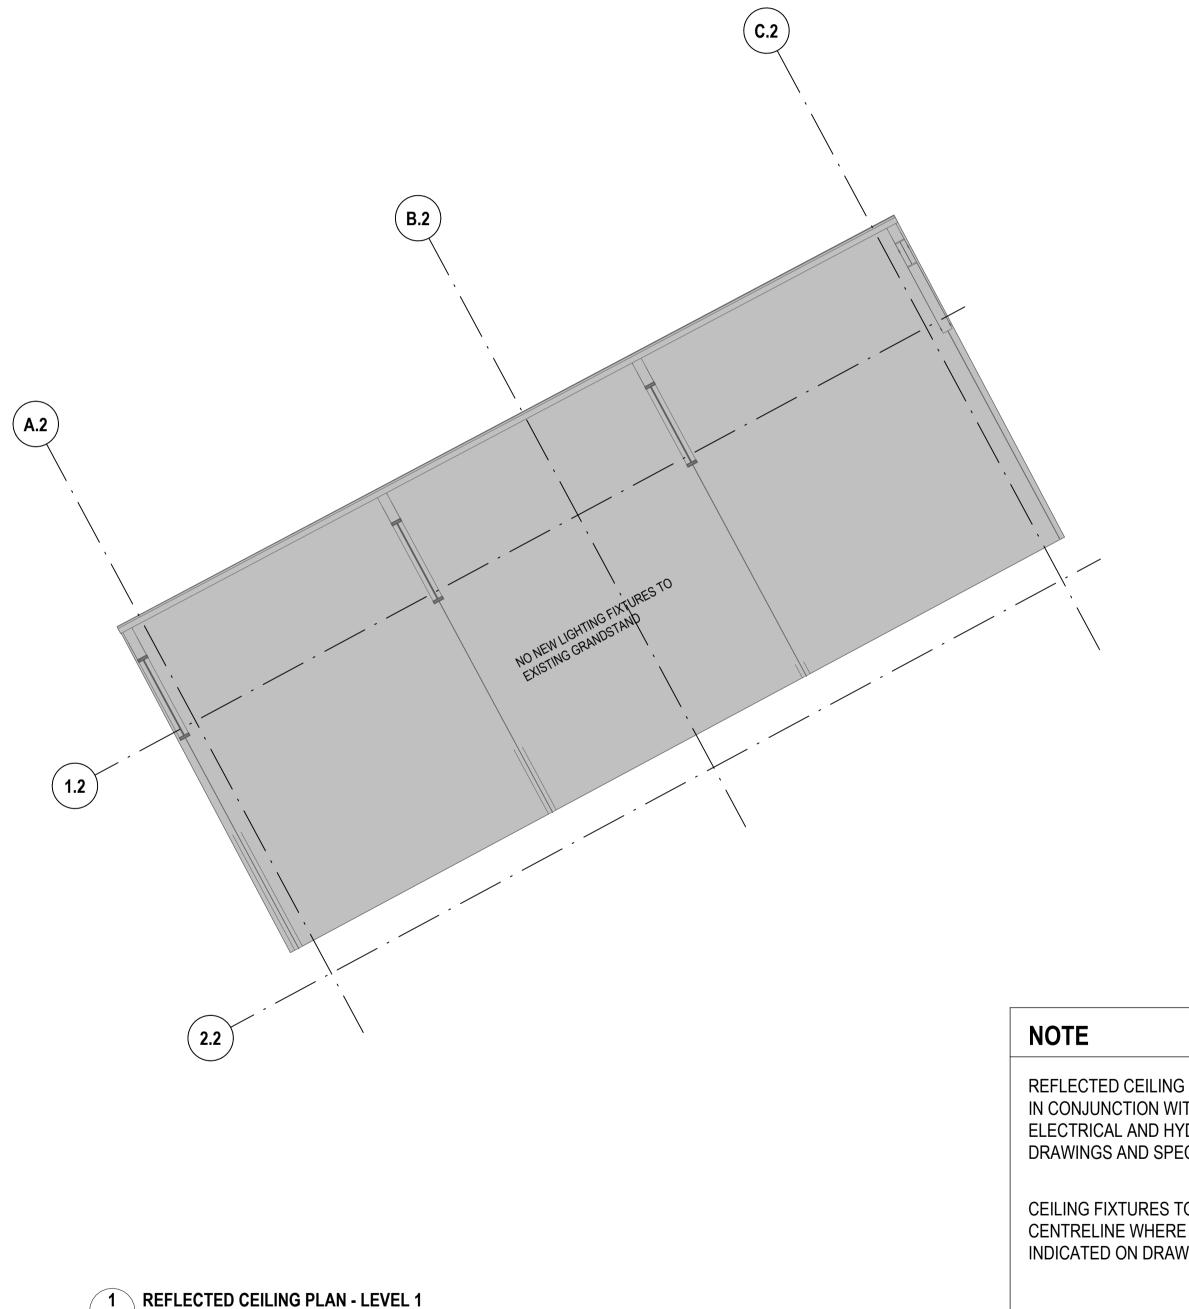
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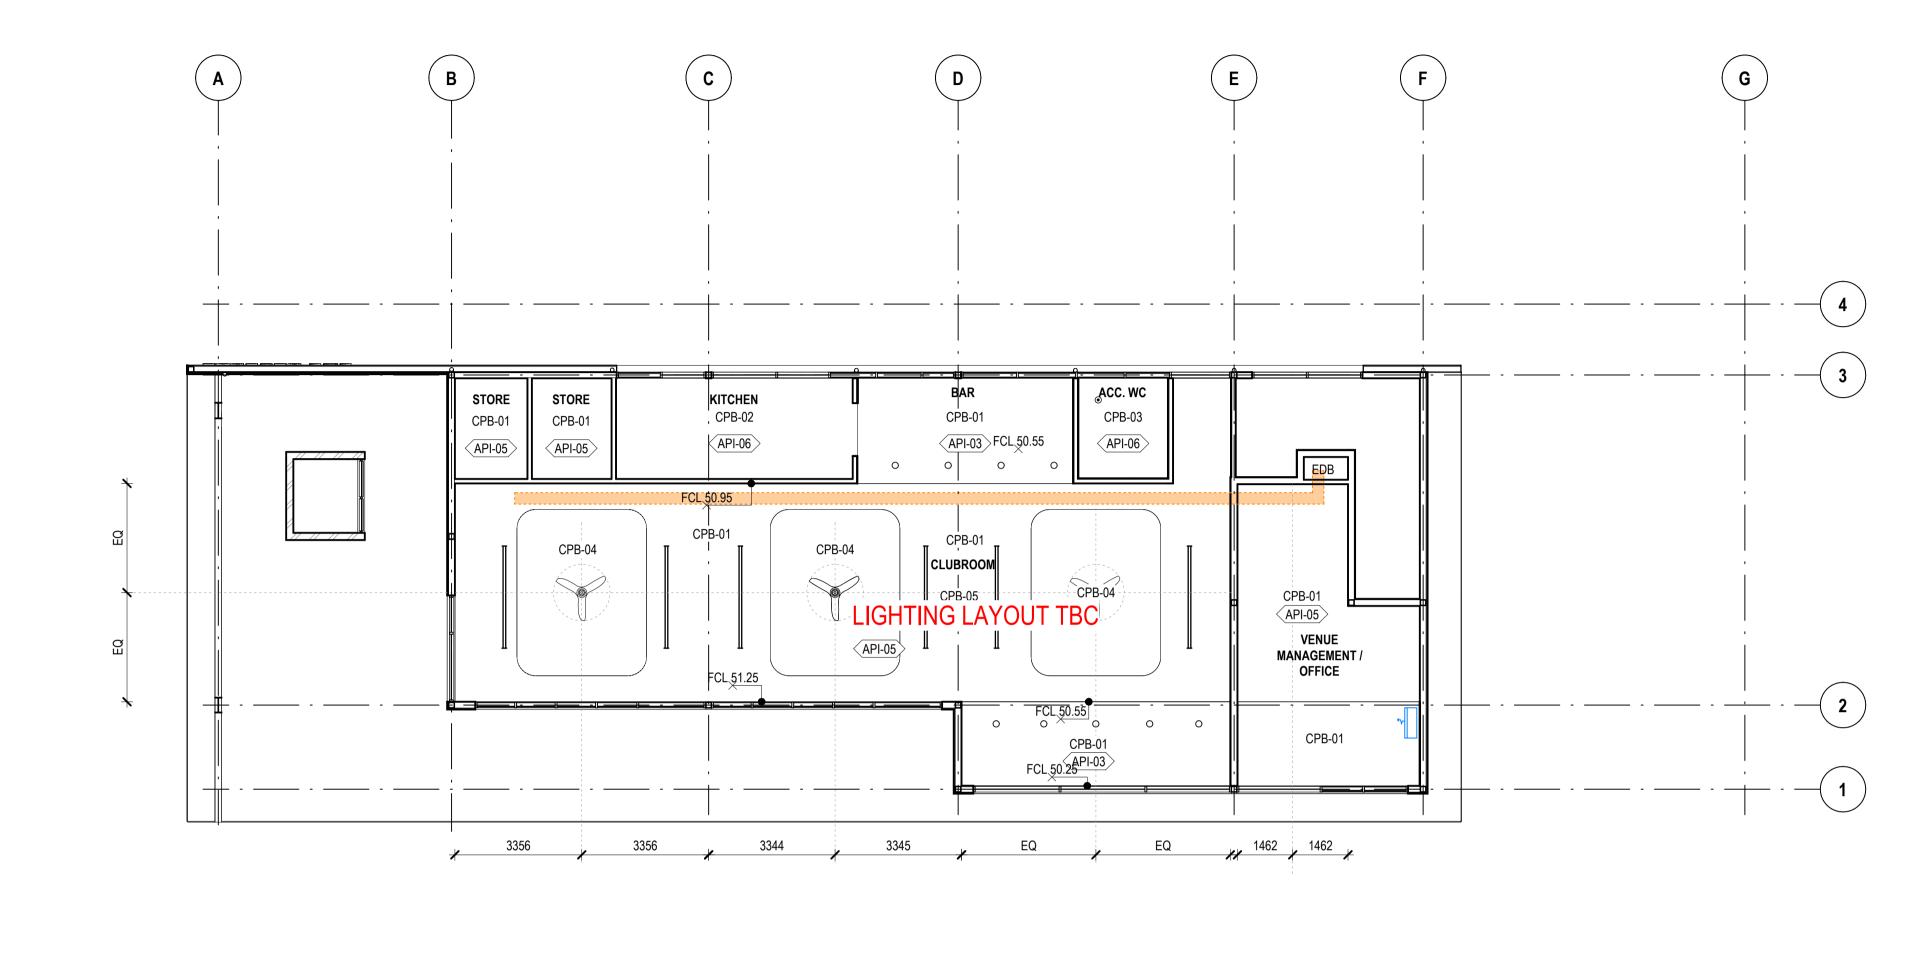




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	SYMBOL LEGEND					
G PLANS TO BE READ /ITH MECHANICAL, YDRAULIC ECIFICATIONS. TO ALIGN TO	<ul> <li>BATTEN LIGHT</li> <li>EMERGENGY LIGHT</li> <li>DOWNLIGHT</li> <li>CAN LIGHT</li> </ul>	(RS) (XX)	SPEAKER REED SWITCH FINISHES TAG - REFER TO CODE LEGEND AND FINISHES SCHEDULE	5 * ]1 ]2	SMOKE DETECTOR EXIT SIGN 90 DEG. MOTION SENSOR 360 DEG. MOTION SENSOR	
E POSSIBLE AS WINGS.	RECESSED LIGHT SUSPENDED LINEAR LIGHT CEILING MOUNTED FAN	FCL T	FINISHED CEILING LEVEL TEMPERATURE SENSOR	(٣) کور	360 DEG. MOTION SENSOR LIGHT SWITCH	



CLIENT

# PROJECT **BOB PRENTER RESERVE** AMENITY BUILDING

PROJECT ADDRESS Fields Rd, Macquarie Fields NSW 2564

# WORK-IN-PROGRESS

A 9.12.24 ISSUED FOR COORDIINATION No DATE REVISIONS

DRAWN BY RK CHECKED BY MW APPROVED BY MAM

DRAWING NO. **BPR-DIS-AR-DRG-2101**  REVISION Α

TITLE

# NOT FOR CONSTRUCTION

ACCESS PANEL

PIPE

SPACE

AC UNIT WALL MOUNTED

CABLE TRAY IN CEILING

0 1 2 3 4 5 SCALE BAR - 1:100


STATUS CONCEPT DESIGN

SCALES As indicated @ A1

**REFLECTED CEILING PLAN - LEVEL** 

# DRAWING TO BE PRINTED IN COLOUR

KEYNOTE				
CODE DESCRIPTION				
API-03	PAINT (INTERNAL)			
API-05	PAINT (INTERNAL)			
API-06	PAINT (INTERNAL)			
CPB-01	PLASTERBOARD CEILING			
CPB-02	FIRE RATED CEILING			
CPB-03	MOISTURE RESISTANT PLASTERBOARD CEILING			
CPB-04	ACOUSTIC PANEL CEILING			
CPB-05				

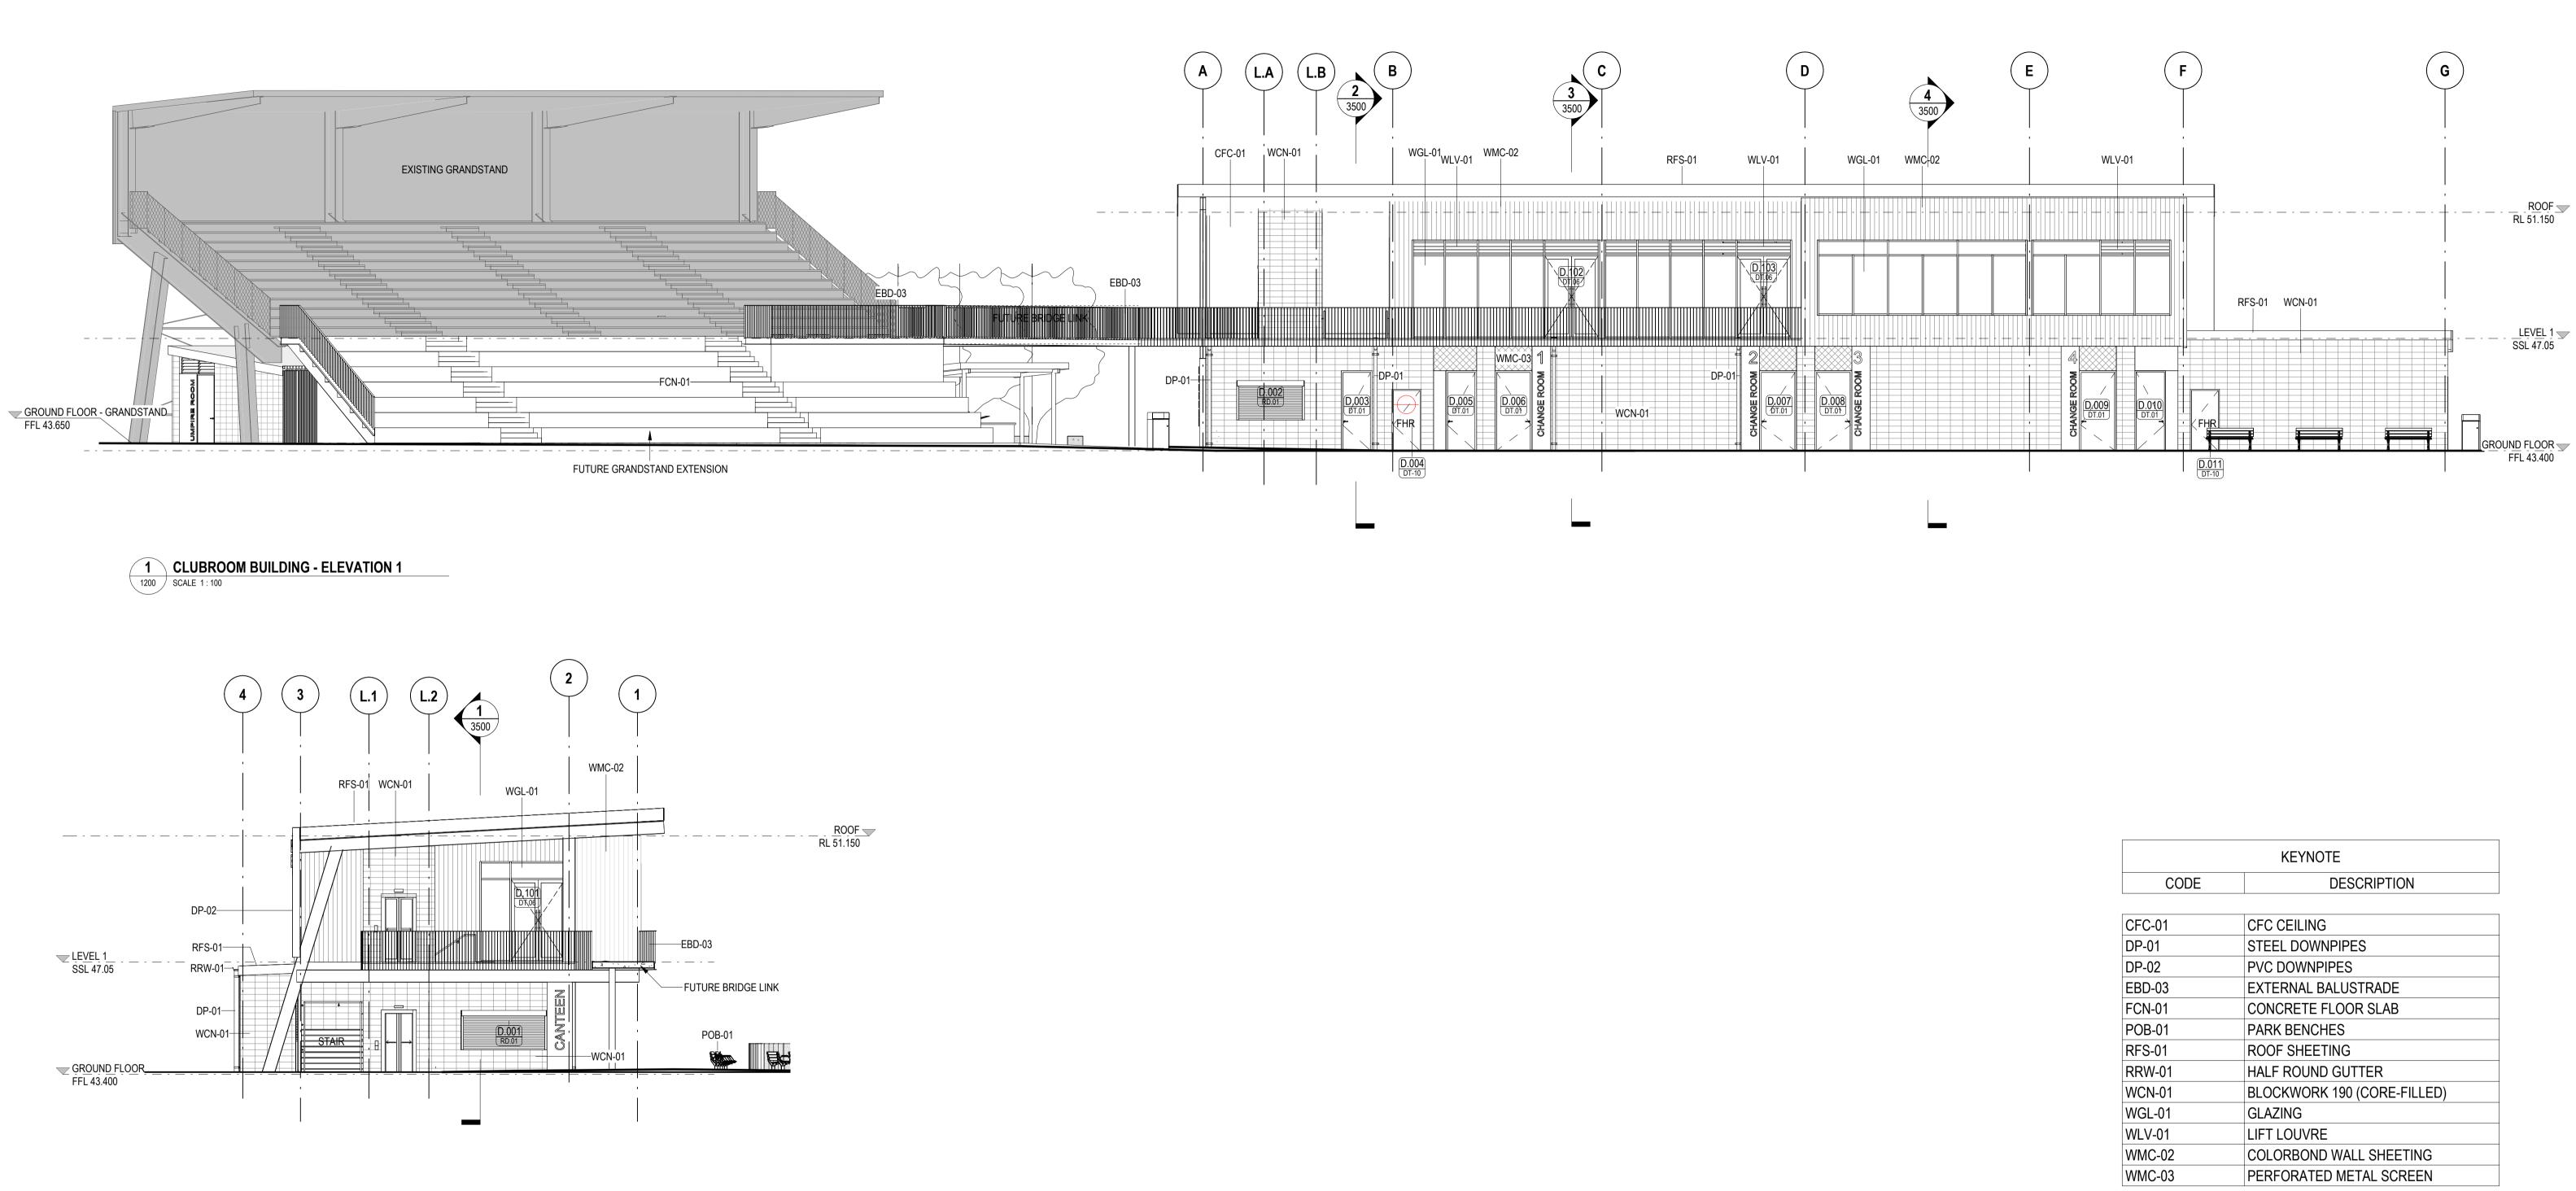

2 CLUBROOM BUILDING - ELEVATION 2 1200 SCALE 1:100

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7260 Cathryn Drew-Bredin 7269

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Cameron Martin 9194 Mary Anne McGirr 10946

Nominated Architects

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Ian Armstrong



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STATUS CONCEPT DESIGN


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TITLE **GA ELEVATIONS - SHEET 1** 


NOT FOR CONSTRUCTION DRAWING TO BE PRINTED IN COLOUR

CFC-01	CFC CEILING
DP-01	STEEL DOWNPIPES
DP-02	PVC DOWNPIPES
EBD-03	EXTERNAL BALUSTRADE
FCN-01	CONCRETE FLOOR SLAB
POB-01	PARK BENCHES
RFS-01	ROOF SHEETING
RRW-01	HALF ROUND GUTTER
WCN-01	BLOCKWORK 190 (CORE-FILLED)
WGL-01	GLAZING
WLV-01	LIFT LOUVRE
WMC-02	COLORBOND WALL SHEETING
WMC-03	PERFORATED METAL SCREEN

DRAWING NO. **BPR-DIS-AR-DRG-3000**  REVISION A

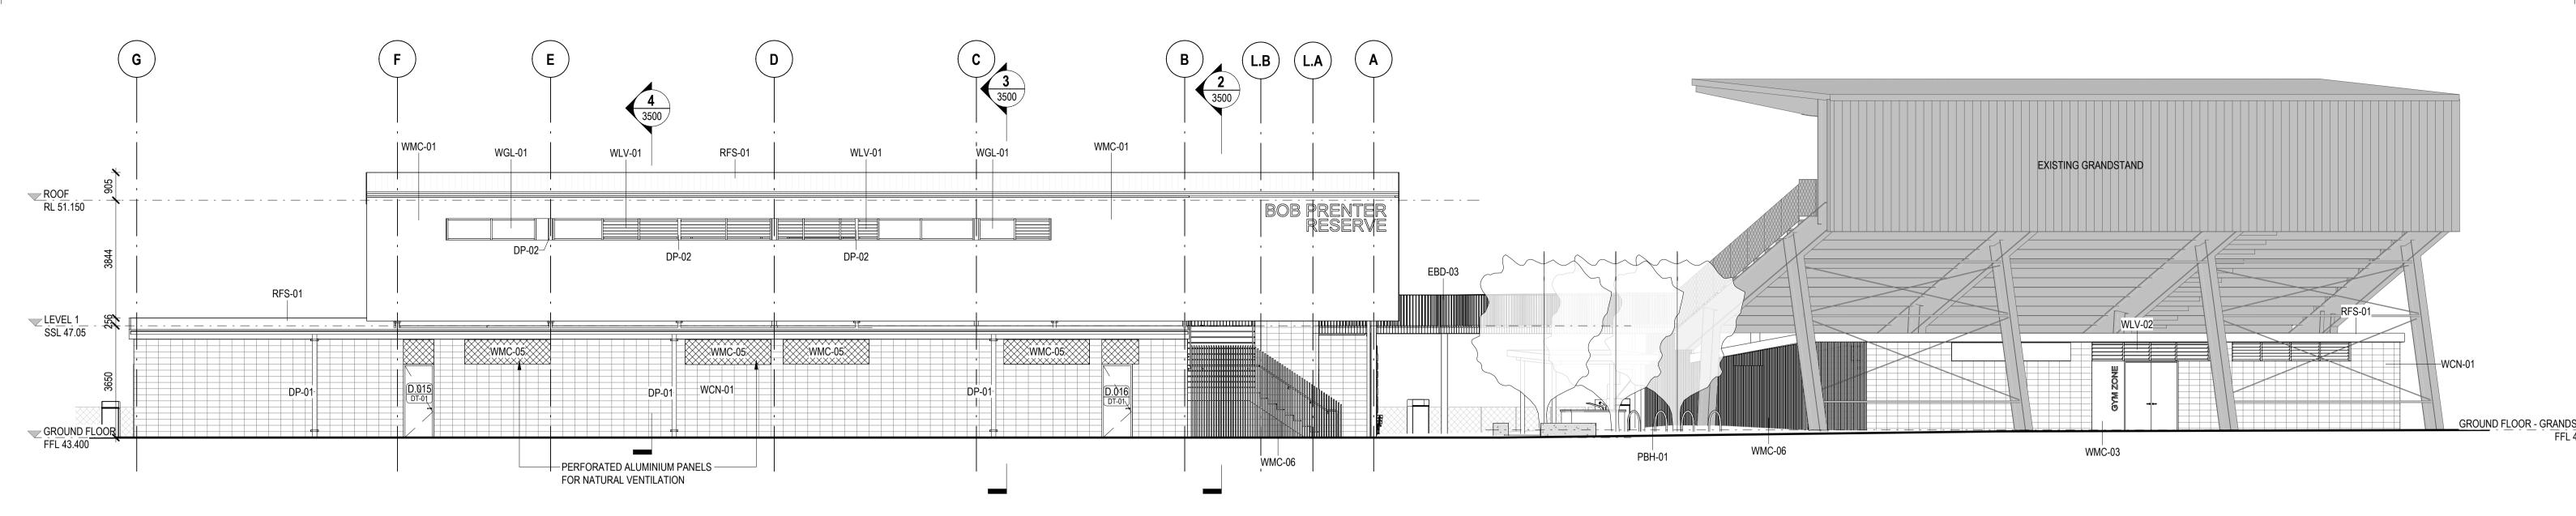

3 CLUBROOM BUILDING - ELEVATION 3 1200 SCALE 1:100

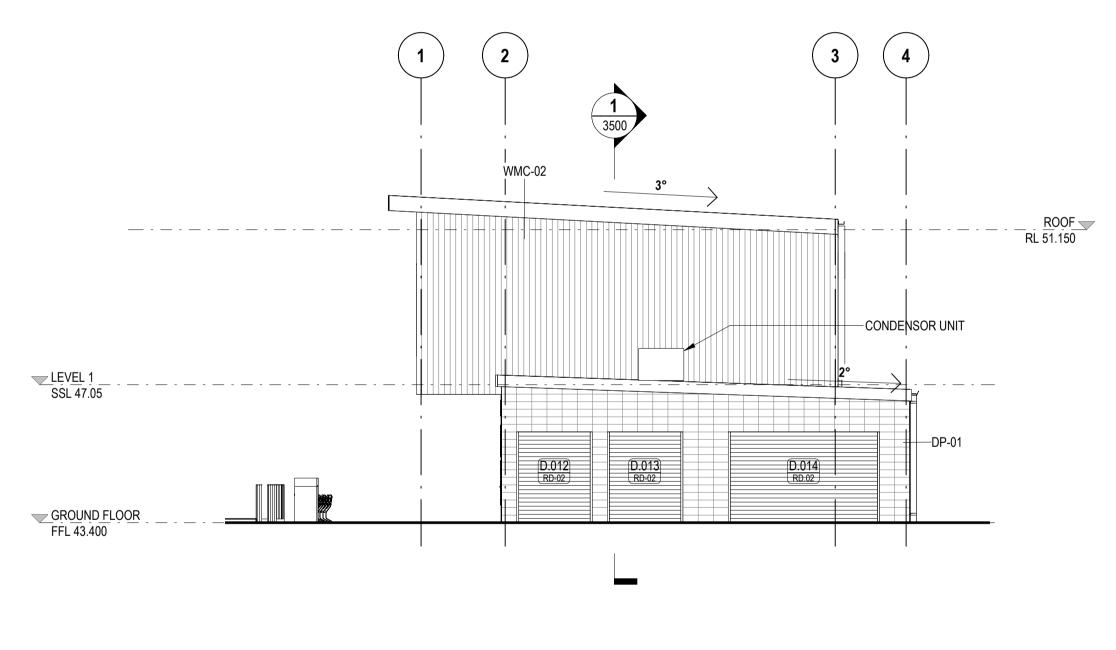

**4** CLUBROOM BUILDING - ELEVATION 4 1200 SCALE 1:100

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0 1 2 3 4 5 SCALE BAR - 1:100

**SCALES** 1 : 100 @ A1

STATUS CONCEPT DESIGN

DRAWING NO.

REVISION Α


TITLE **GA ELEVATIONS - SHEET 2** 

**BPR-DIS-AR-DRG-3001** 

NOT FOR CONSTRUCTION DRAWING TO BE PRINTED IN COLOUR

CODE	DESCRIPTION
DP-01	STEEL DOWNPIPES
DP-02	PVC DOWNPIPES
EBD-03	EXTERNAL BALUSTRADE
PBH-01	BIKE HOOPS
RFS-01	ROOF SHEETING
WCN-01	BLOCKWORK 190 (CORE-FILLED)
WGL-01	GLAZING
WLV-01	LIFT LOUVRE
WLV-02	
WMC-01	COLORBOND WALL SHEETING
WMC-02	COLORBOND WALL SHEETING
WMC-03	PERFORATED METAL SCREEN
WMC-05	PERFORATED METAL SCREEN
WMC-06	FAÇADE BATTENS

KEYNOTE

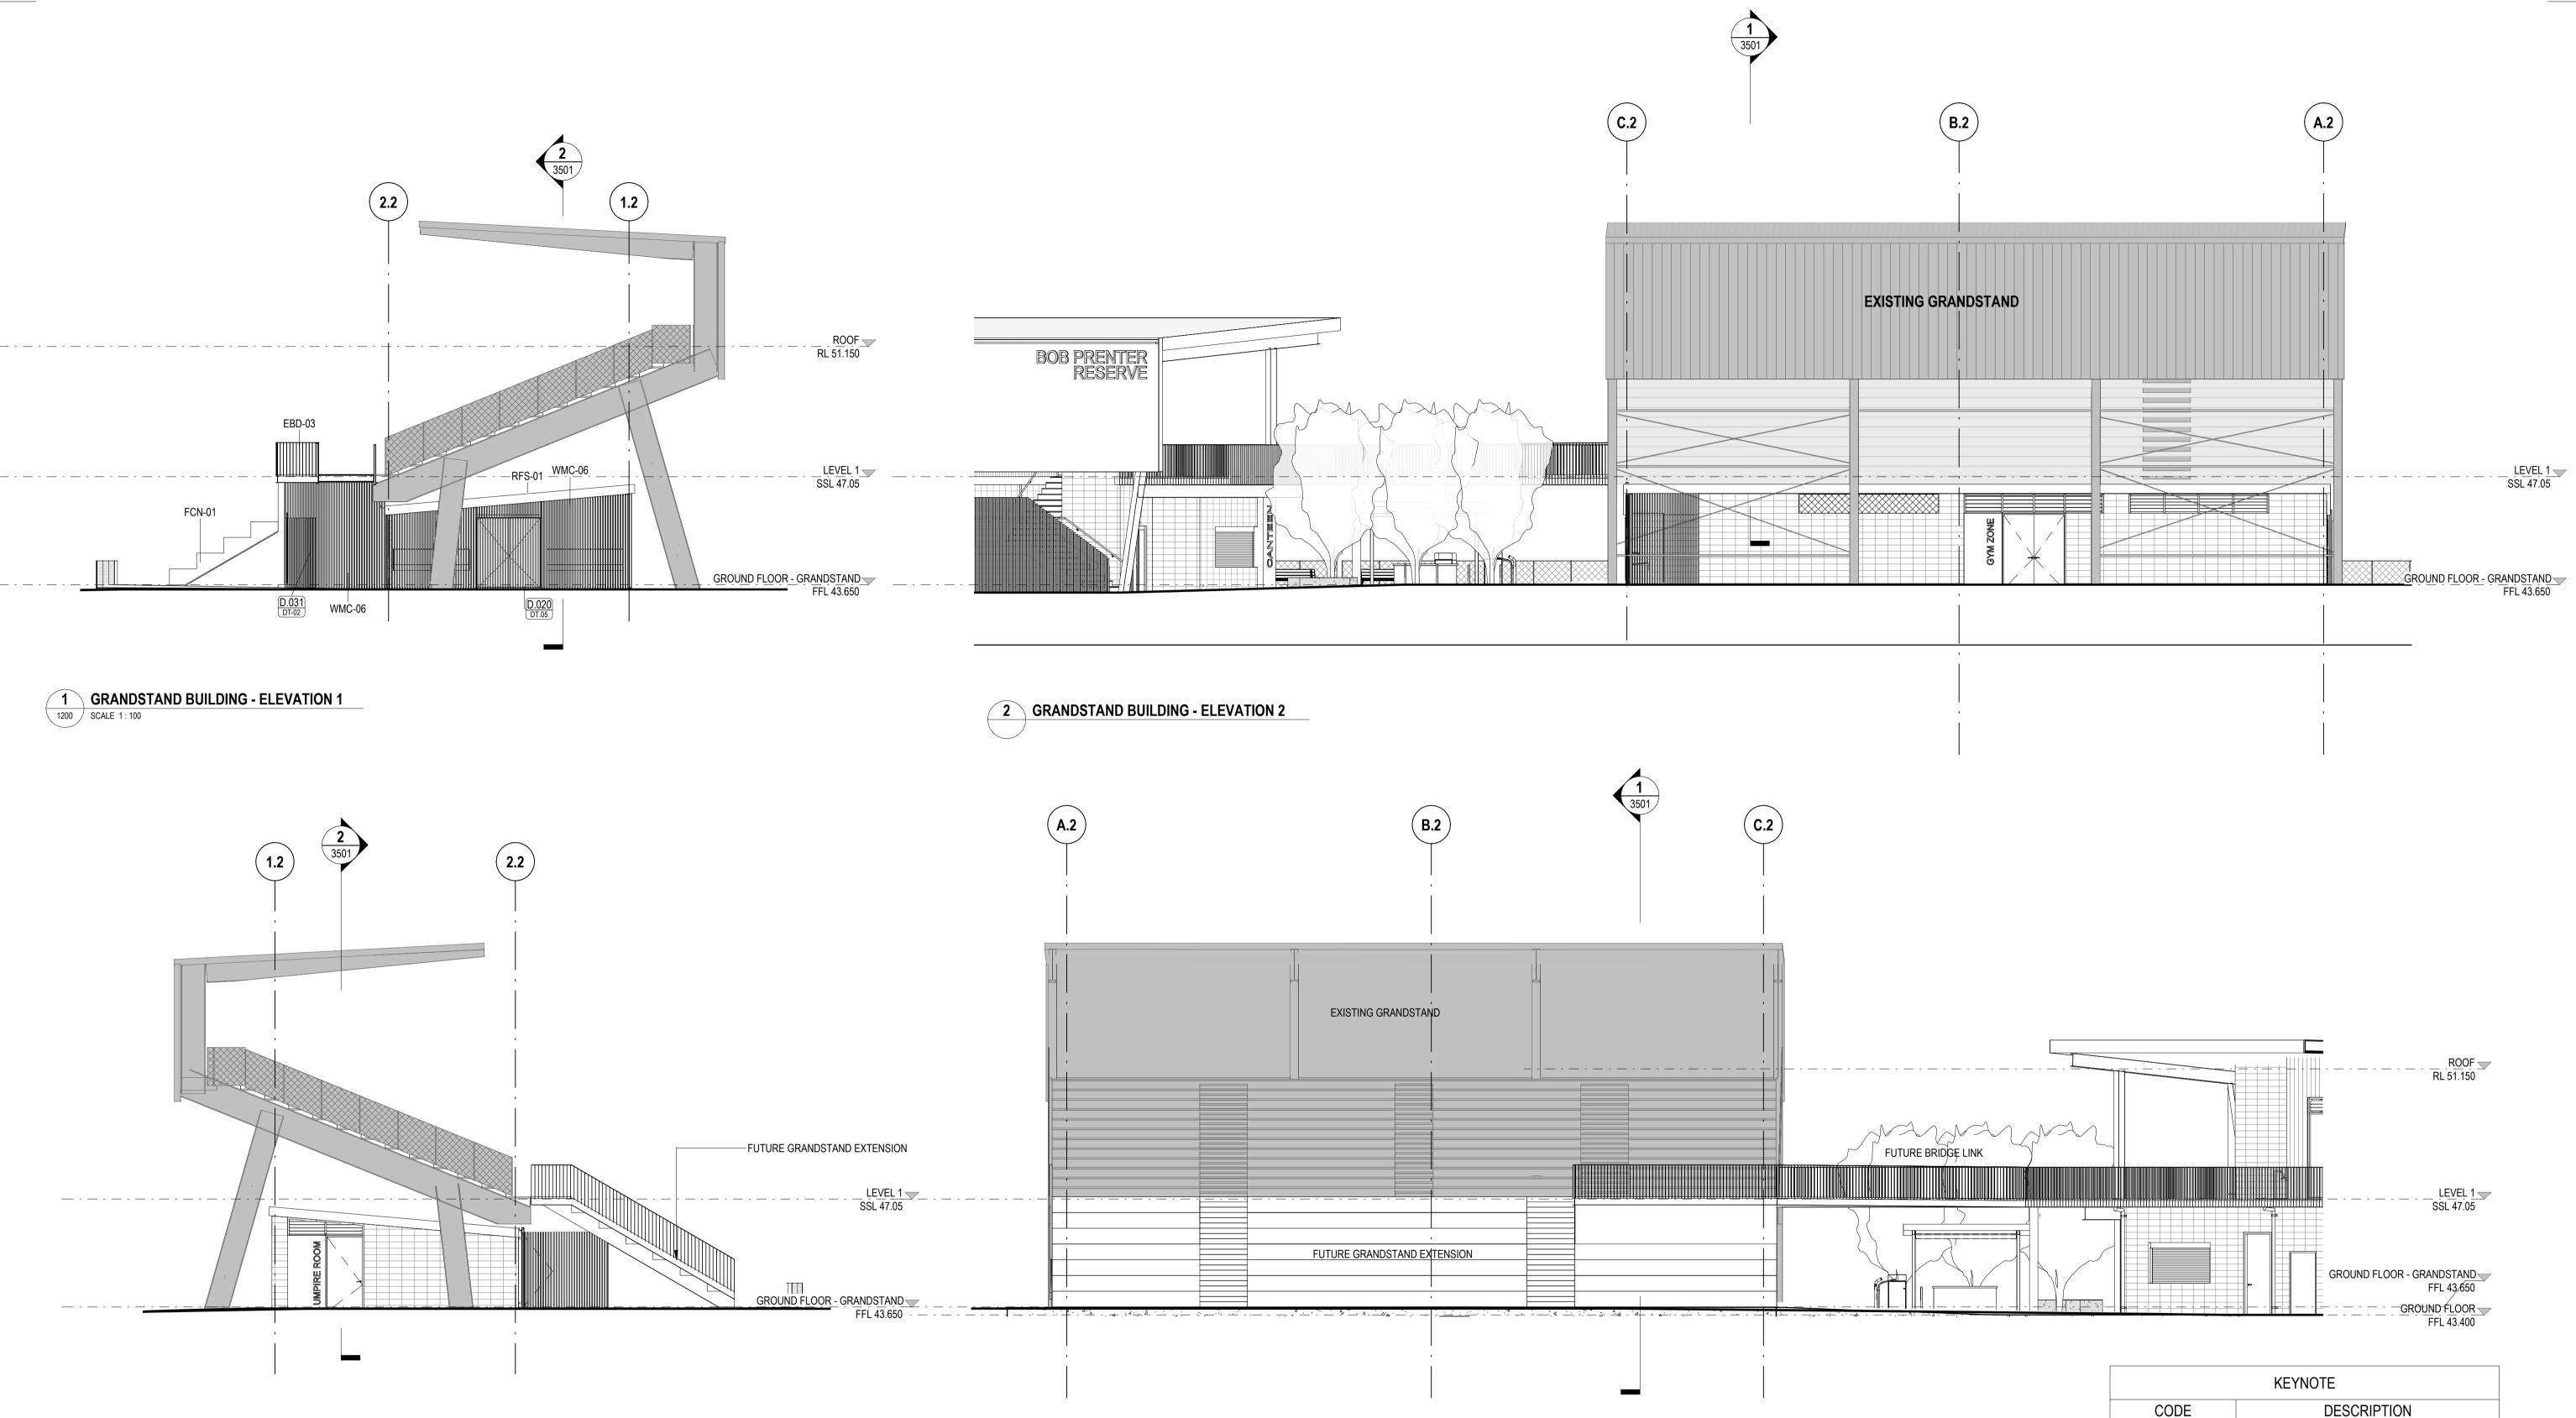

**3** GRANDSTAND BUILDING - ELEVATION 3

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Cameron Martin 9194 Mary Anne McGirr 10946

**Nominated Architects** 

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lan Armstrong



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**4** GRANDSTAND BUILDING - ELEVATION 4




# PROJECT **BOB PRENTER RESERVE** AMENITY BUILDING

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TITLE **GA ELEVATIONS - SHEET 3** 


# NOT FOR CONSTRUCTION DRAWING TO BE PRINTED IN COLOUR

CODE	DESCRIPTION		
EBD-03	EXTERNAL BALUSTRADE		
FCN-01	CONCRETE FLOOR SLAB		
RFS-01	ROOF SHEETING		
WMC-06	FAÇADE BATTENS		
L			

**SCALES** 1 : 100 @ A1

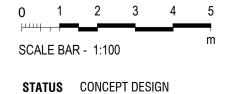DRAWING NO. **BPR-DIS-AR-DRG-3002** 



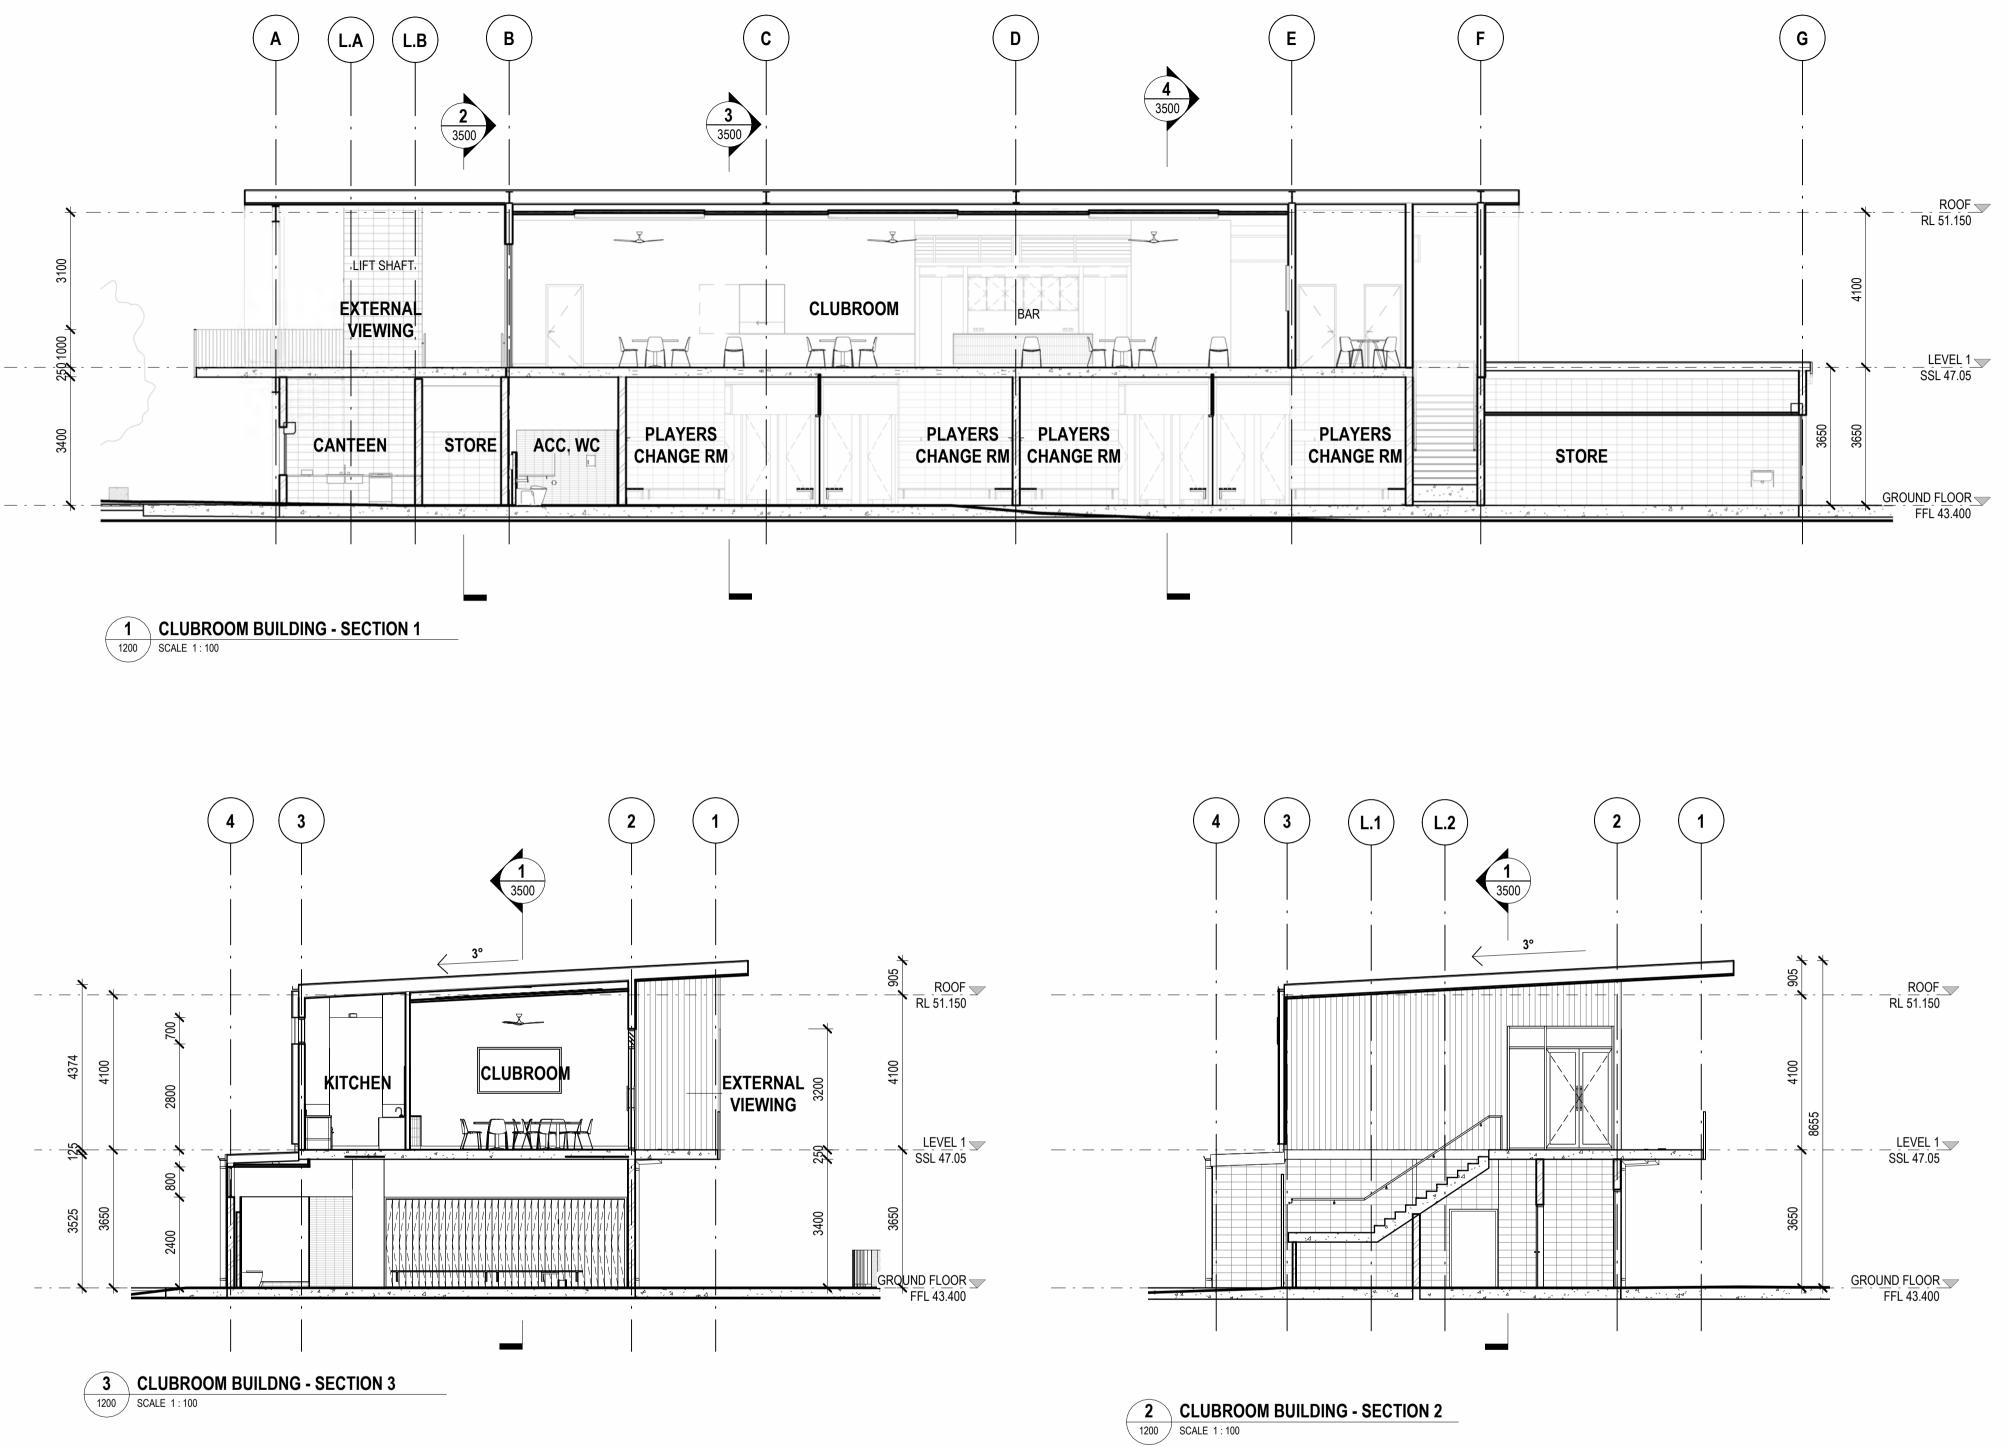

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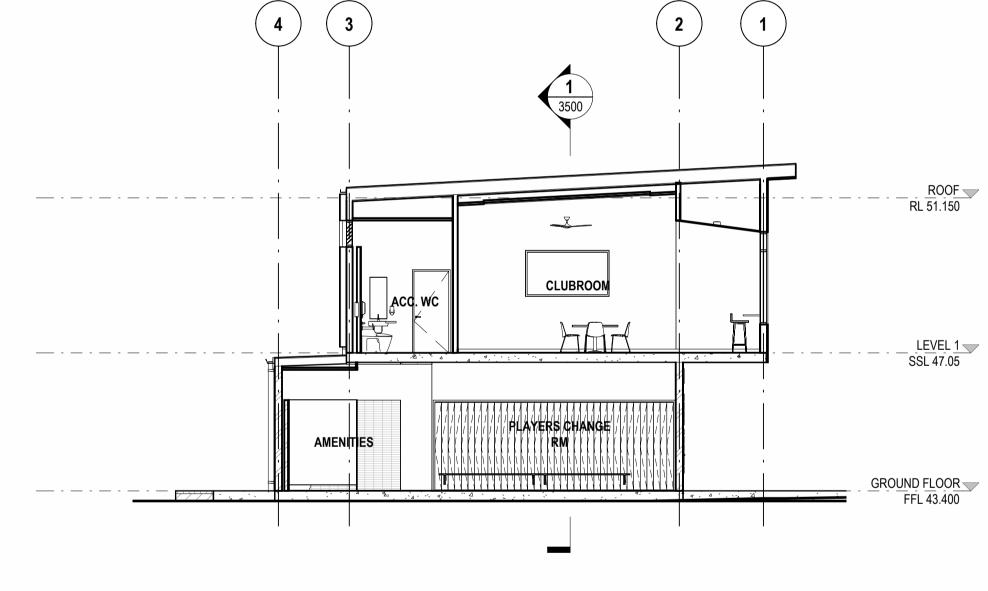
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• •

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4 CLUBROOM BUILDING - SECTION 4



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STATUS CONCEPT DESIGN

**SCALES** 1 : 100 @ A1

TITLE **GA SECTIONS - SHEET 1** 

**BPR-DIS-AR-DRG-3500** 

DRAWING NO.


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REVISION

Α

CODE

DESCRIPTION

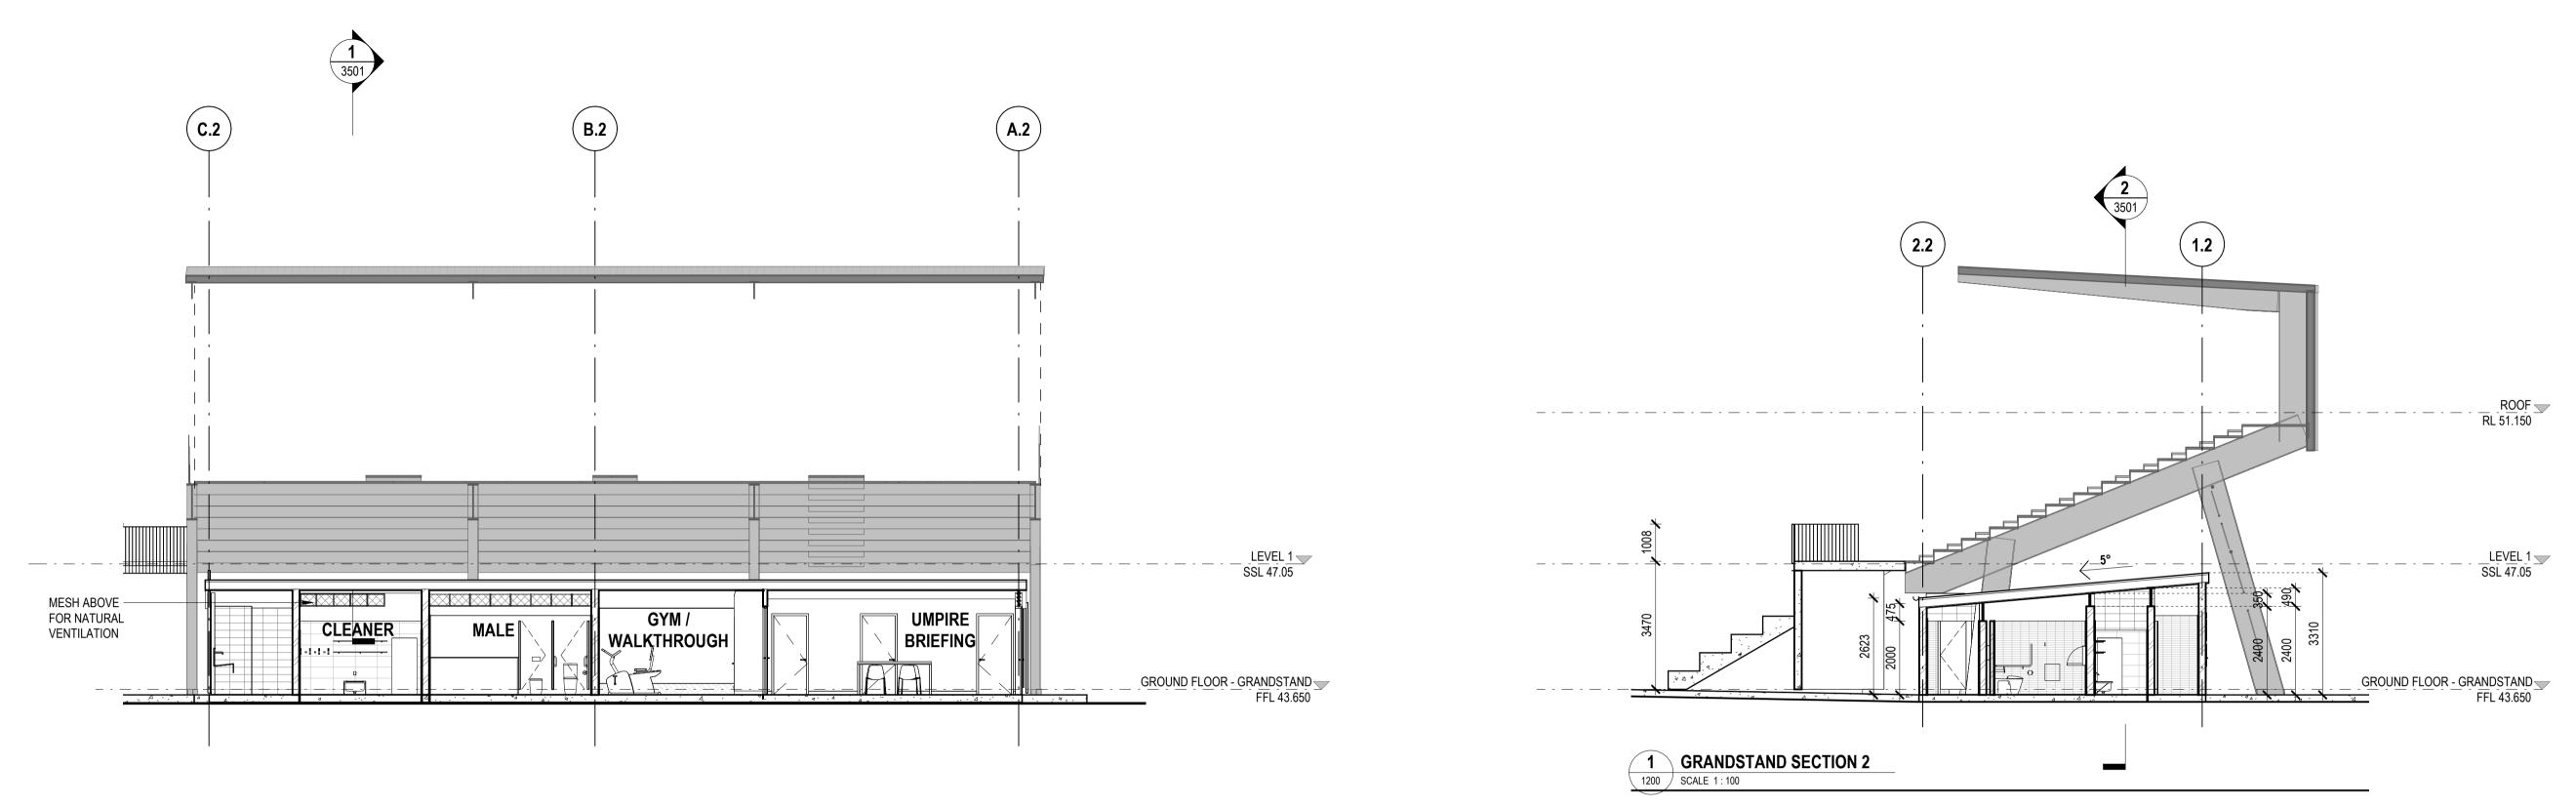

**2** GRANDSTAND - SECTION 1 1200 SCALE 1:100



lan Armstrong 7260 Cathryn Drew-Bredin 7269 Cameron Martin 9194 Mary Anne McGirr 10946

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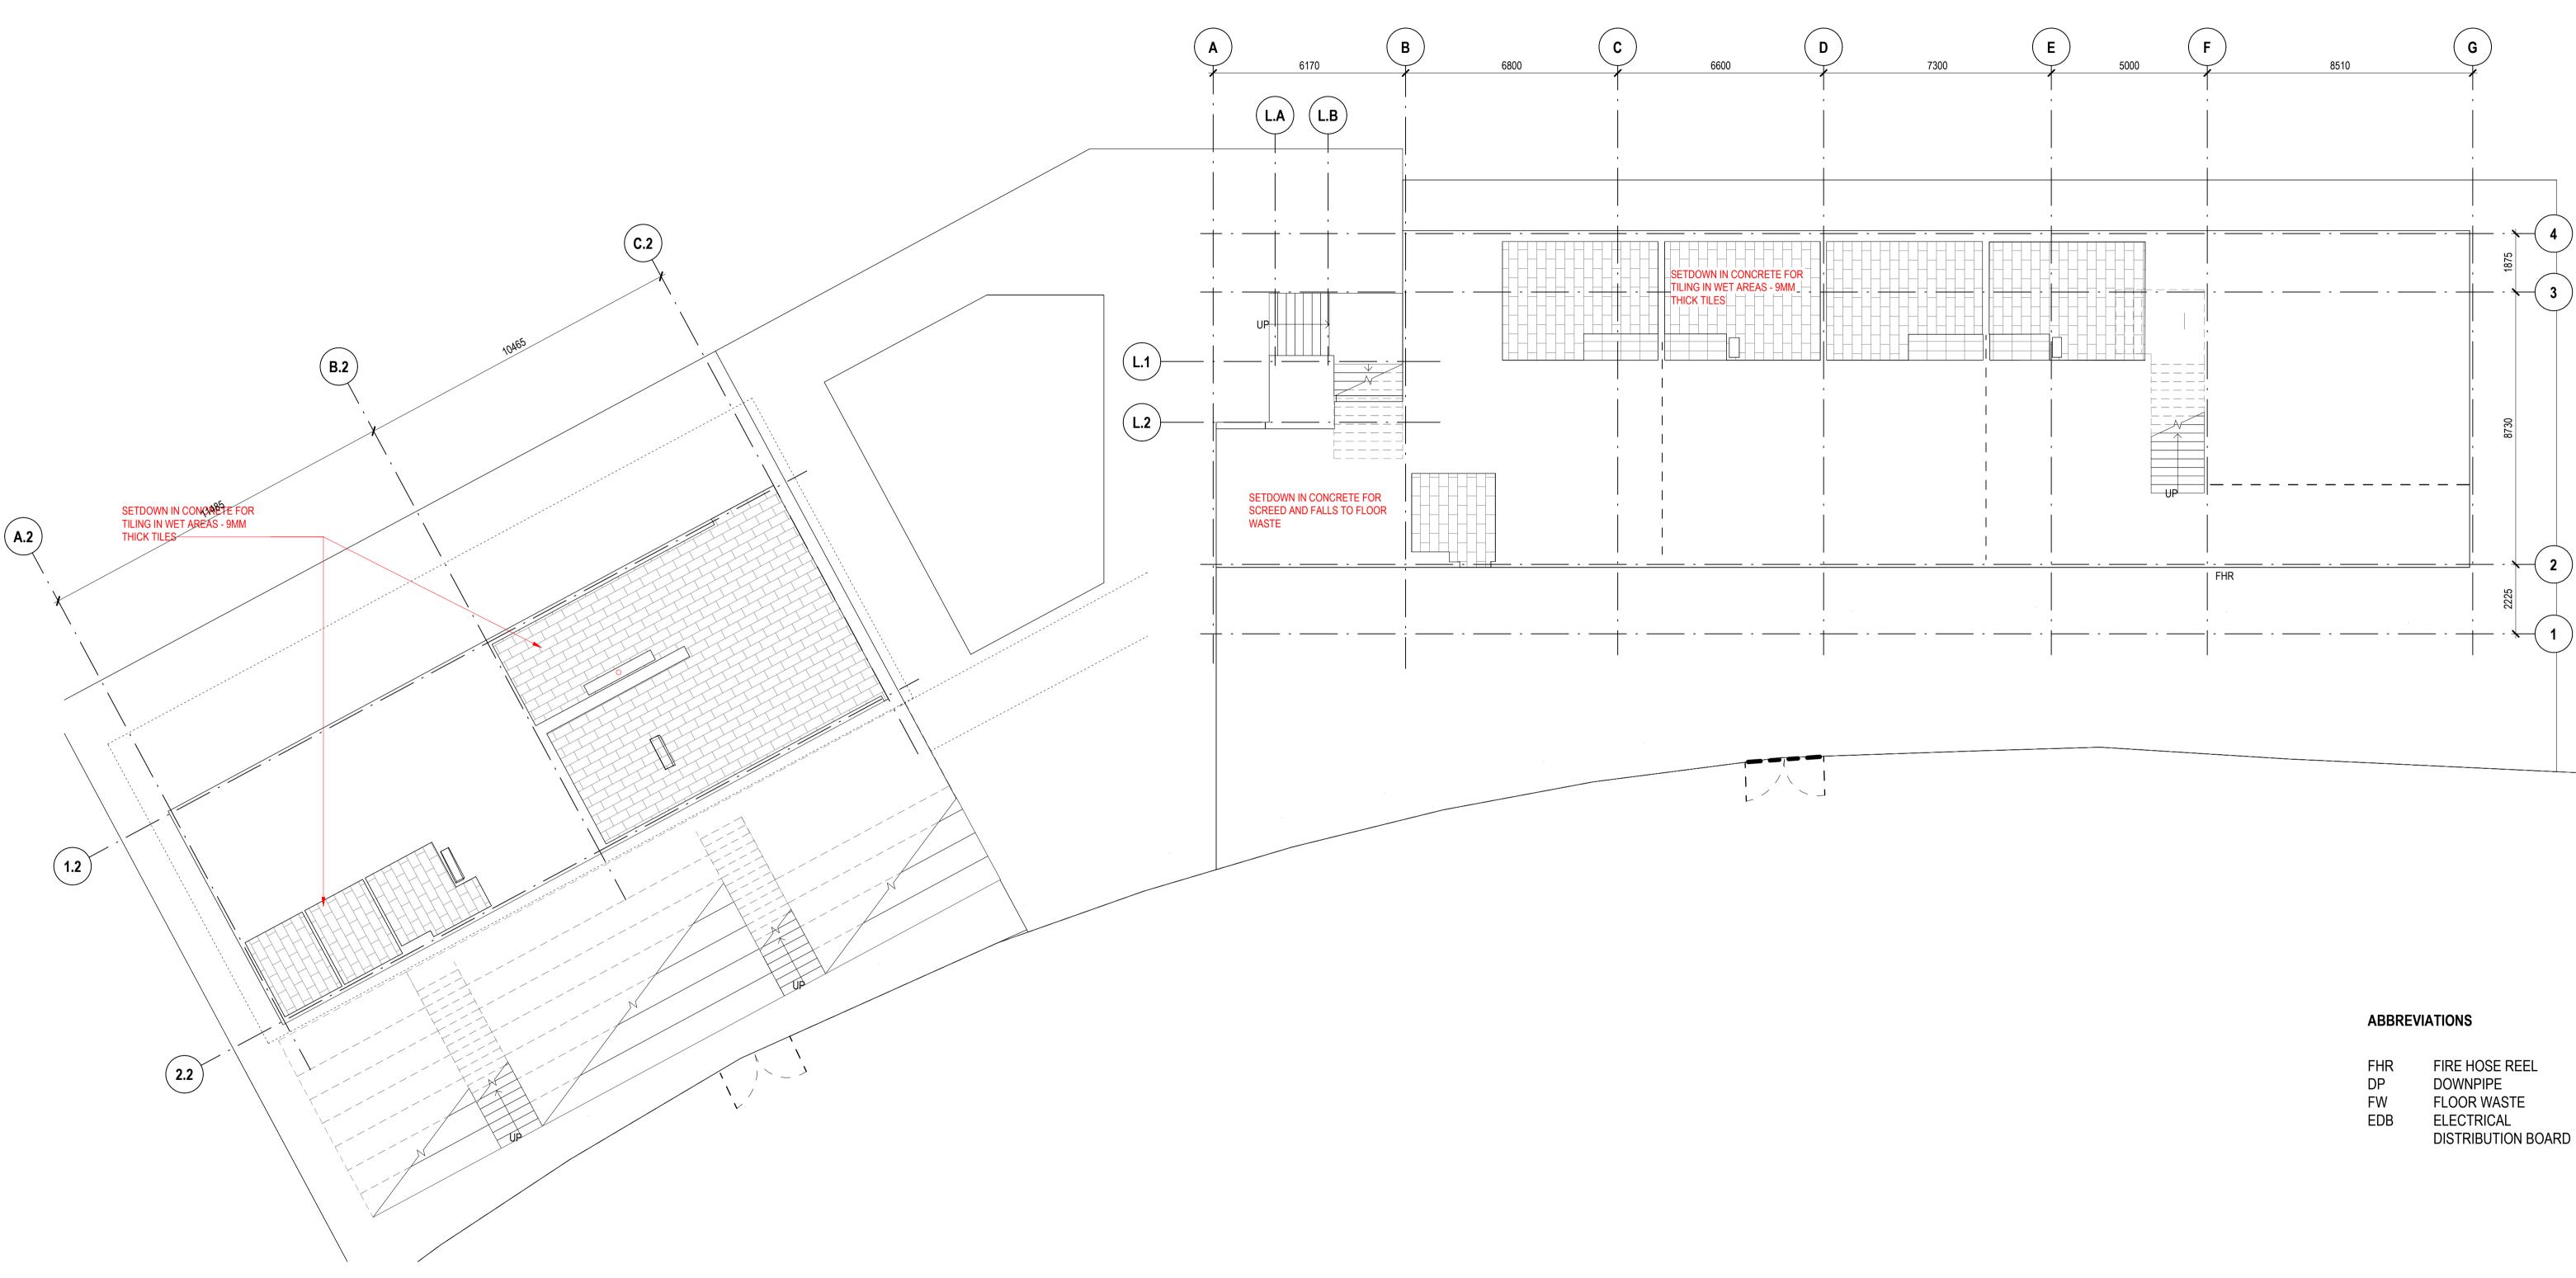
DRAWING NO. BPR-DIS-AR-DRG-3501



TITLE 0 1 2 3 4 5 **GA SECTIONS - SHEET 2** 

NOT FOR CONSTRUCTION DRAWING TO BE PRINTED IN COLOUR

KEYNOTE CODE DESCRIPTION



**1** CONCRETE SETOUT PLAN - GROUND FLOOR 020 SCALE 1:100

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FHR	FIRE HOSE REEL
DP	DOWNPIPE
FW	FLOOR WASTE
EDB	ELECTRICAL
	DISTRIBUTION BOARD




TITLE **CONCRETE SETOUT PLAN -GROUND FLOOR** DRAWING NO. **BPR-DIS-AR-DRG-5000** 

1	
$\checkmark$	

0 1 2 3 4 5 SCALE BAR - 1:100

STATUS CONCEPT DESIGN SCALES As indicated @ A1

REVISION Α

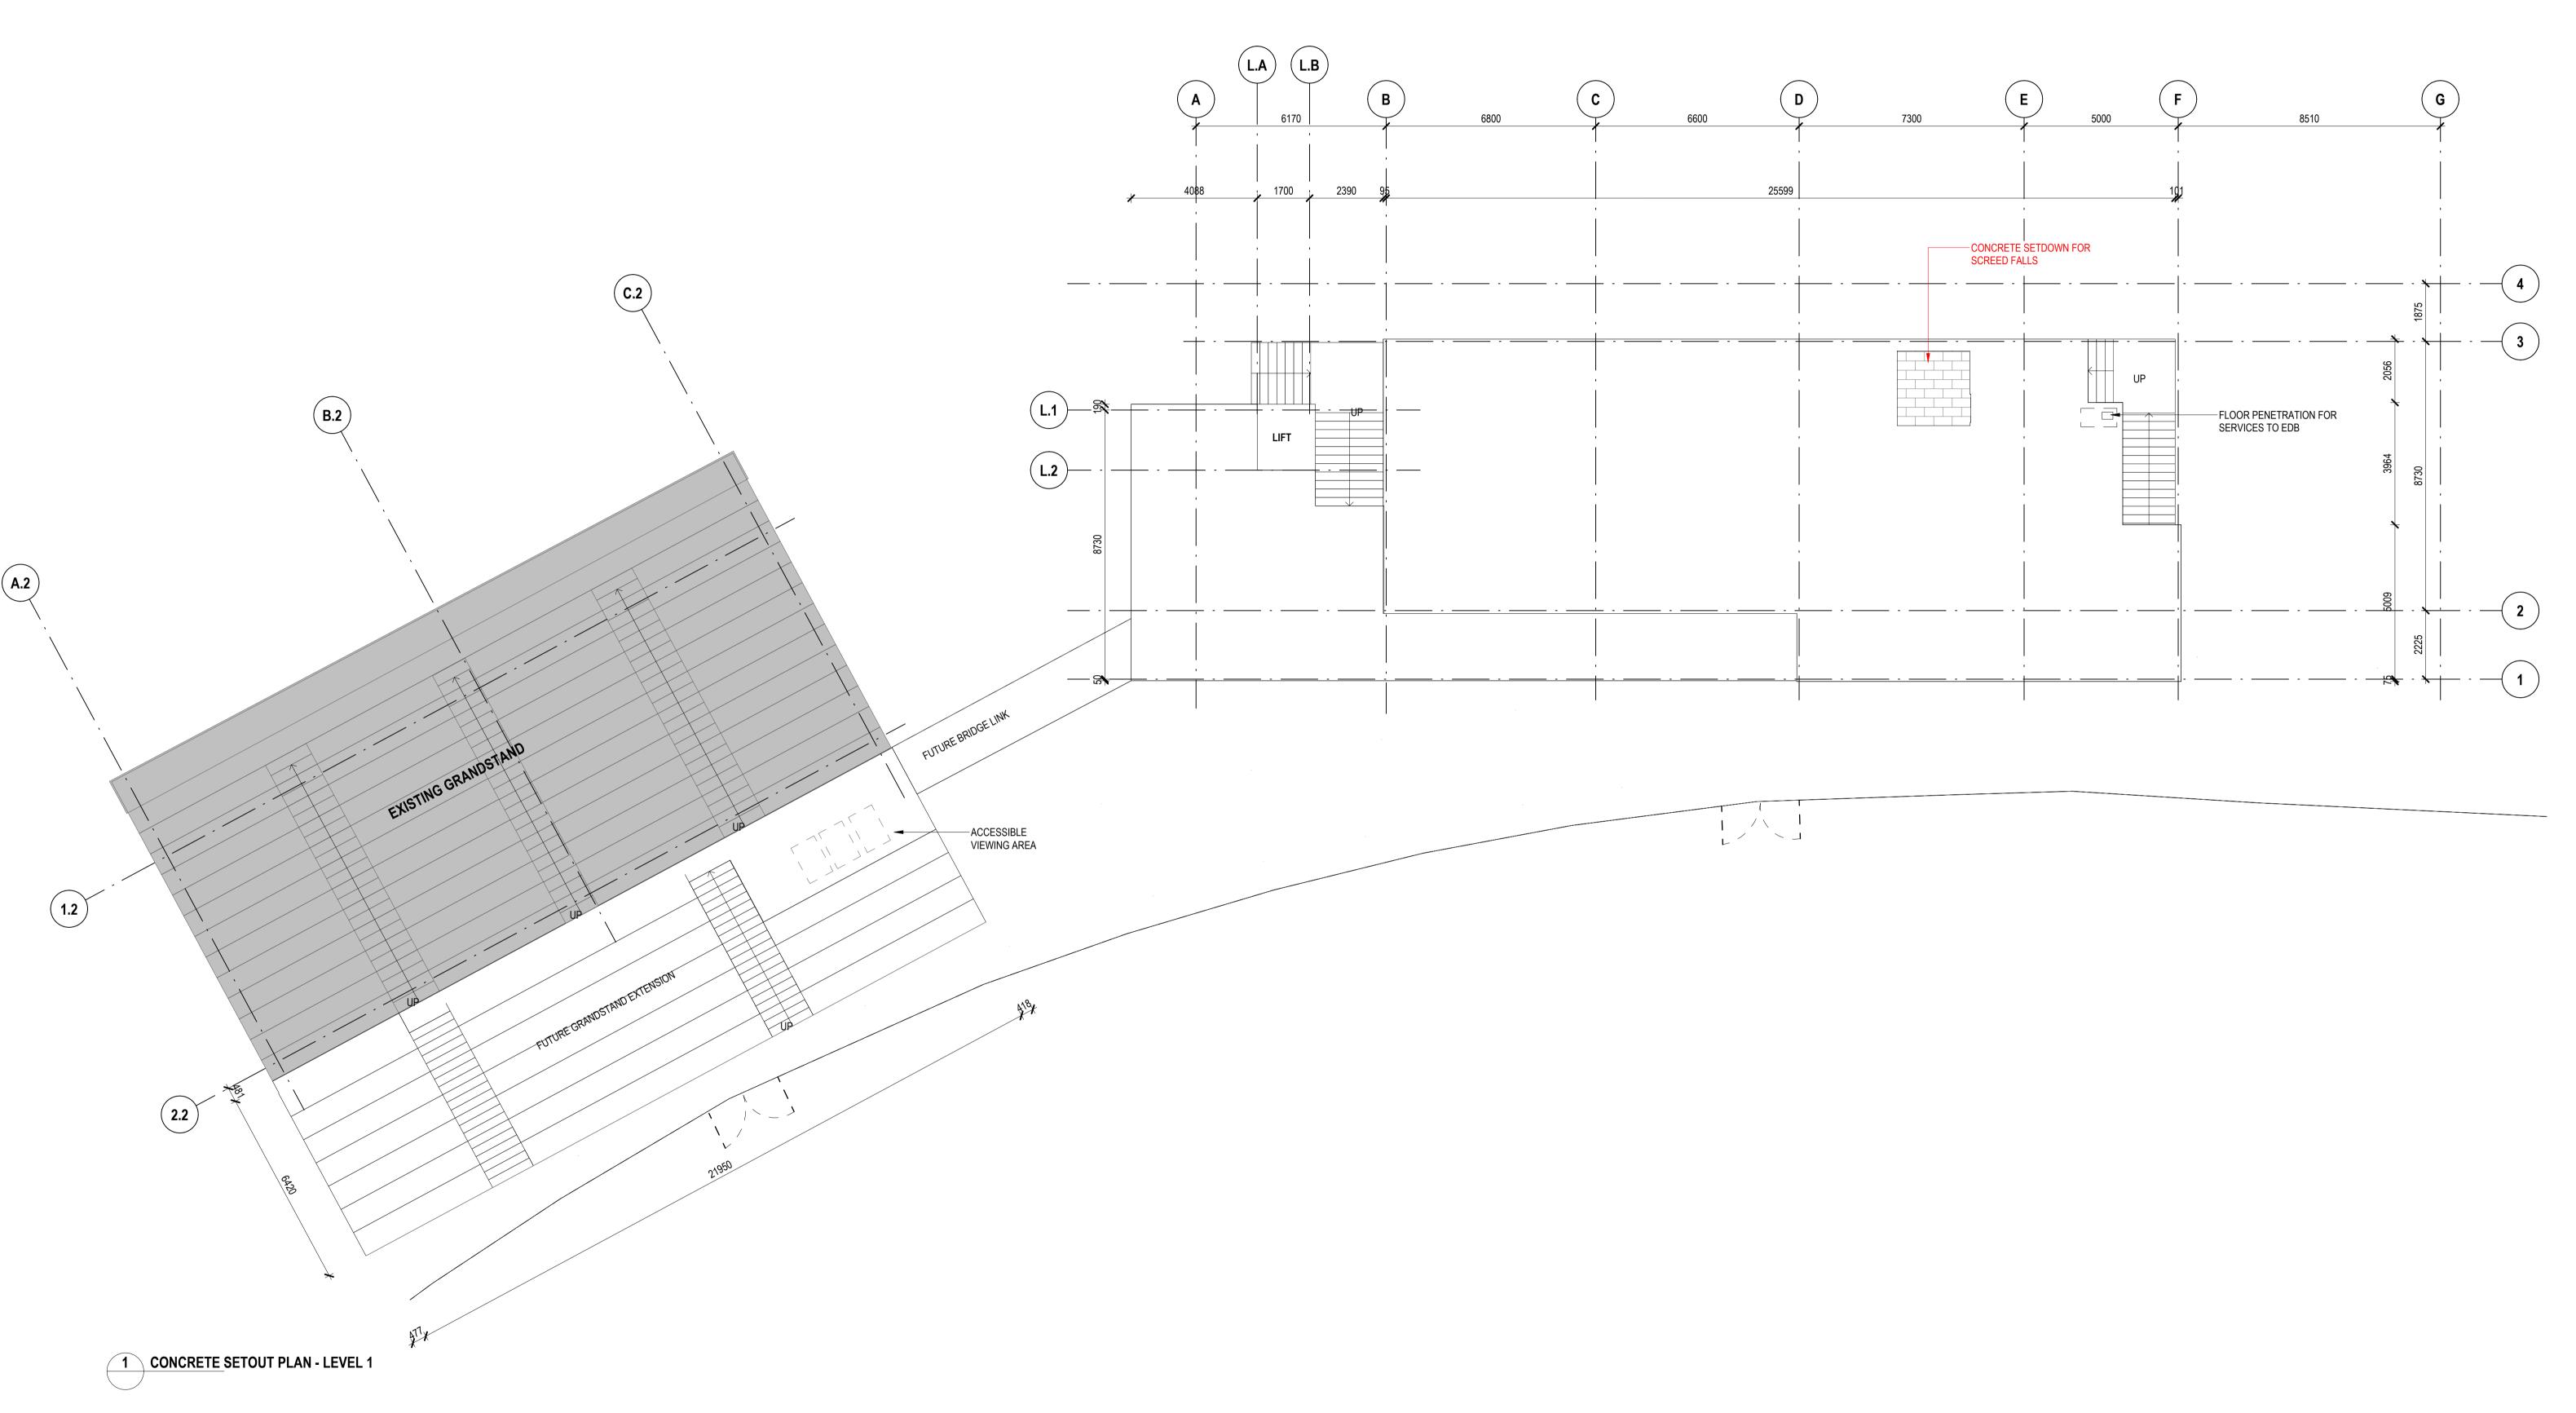

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lan Armstrong 7260 Cathryn Drew-Bredin 7269 Cameron Martin 9194 Mary Anne McGirr 10946

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STATUS CONCEPT DESIGN **SCALES** 1 : 100 @ A1

0 1 2 3 4 5 SCALE BAR - 1:100


TITLE **CONCRETE SETOUT PLAN - LEVEL 1** 

**BPR-DIS-AR-DRG-5001** 

REVISION

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DRAWING NO.

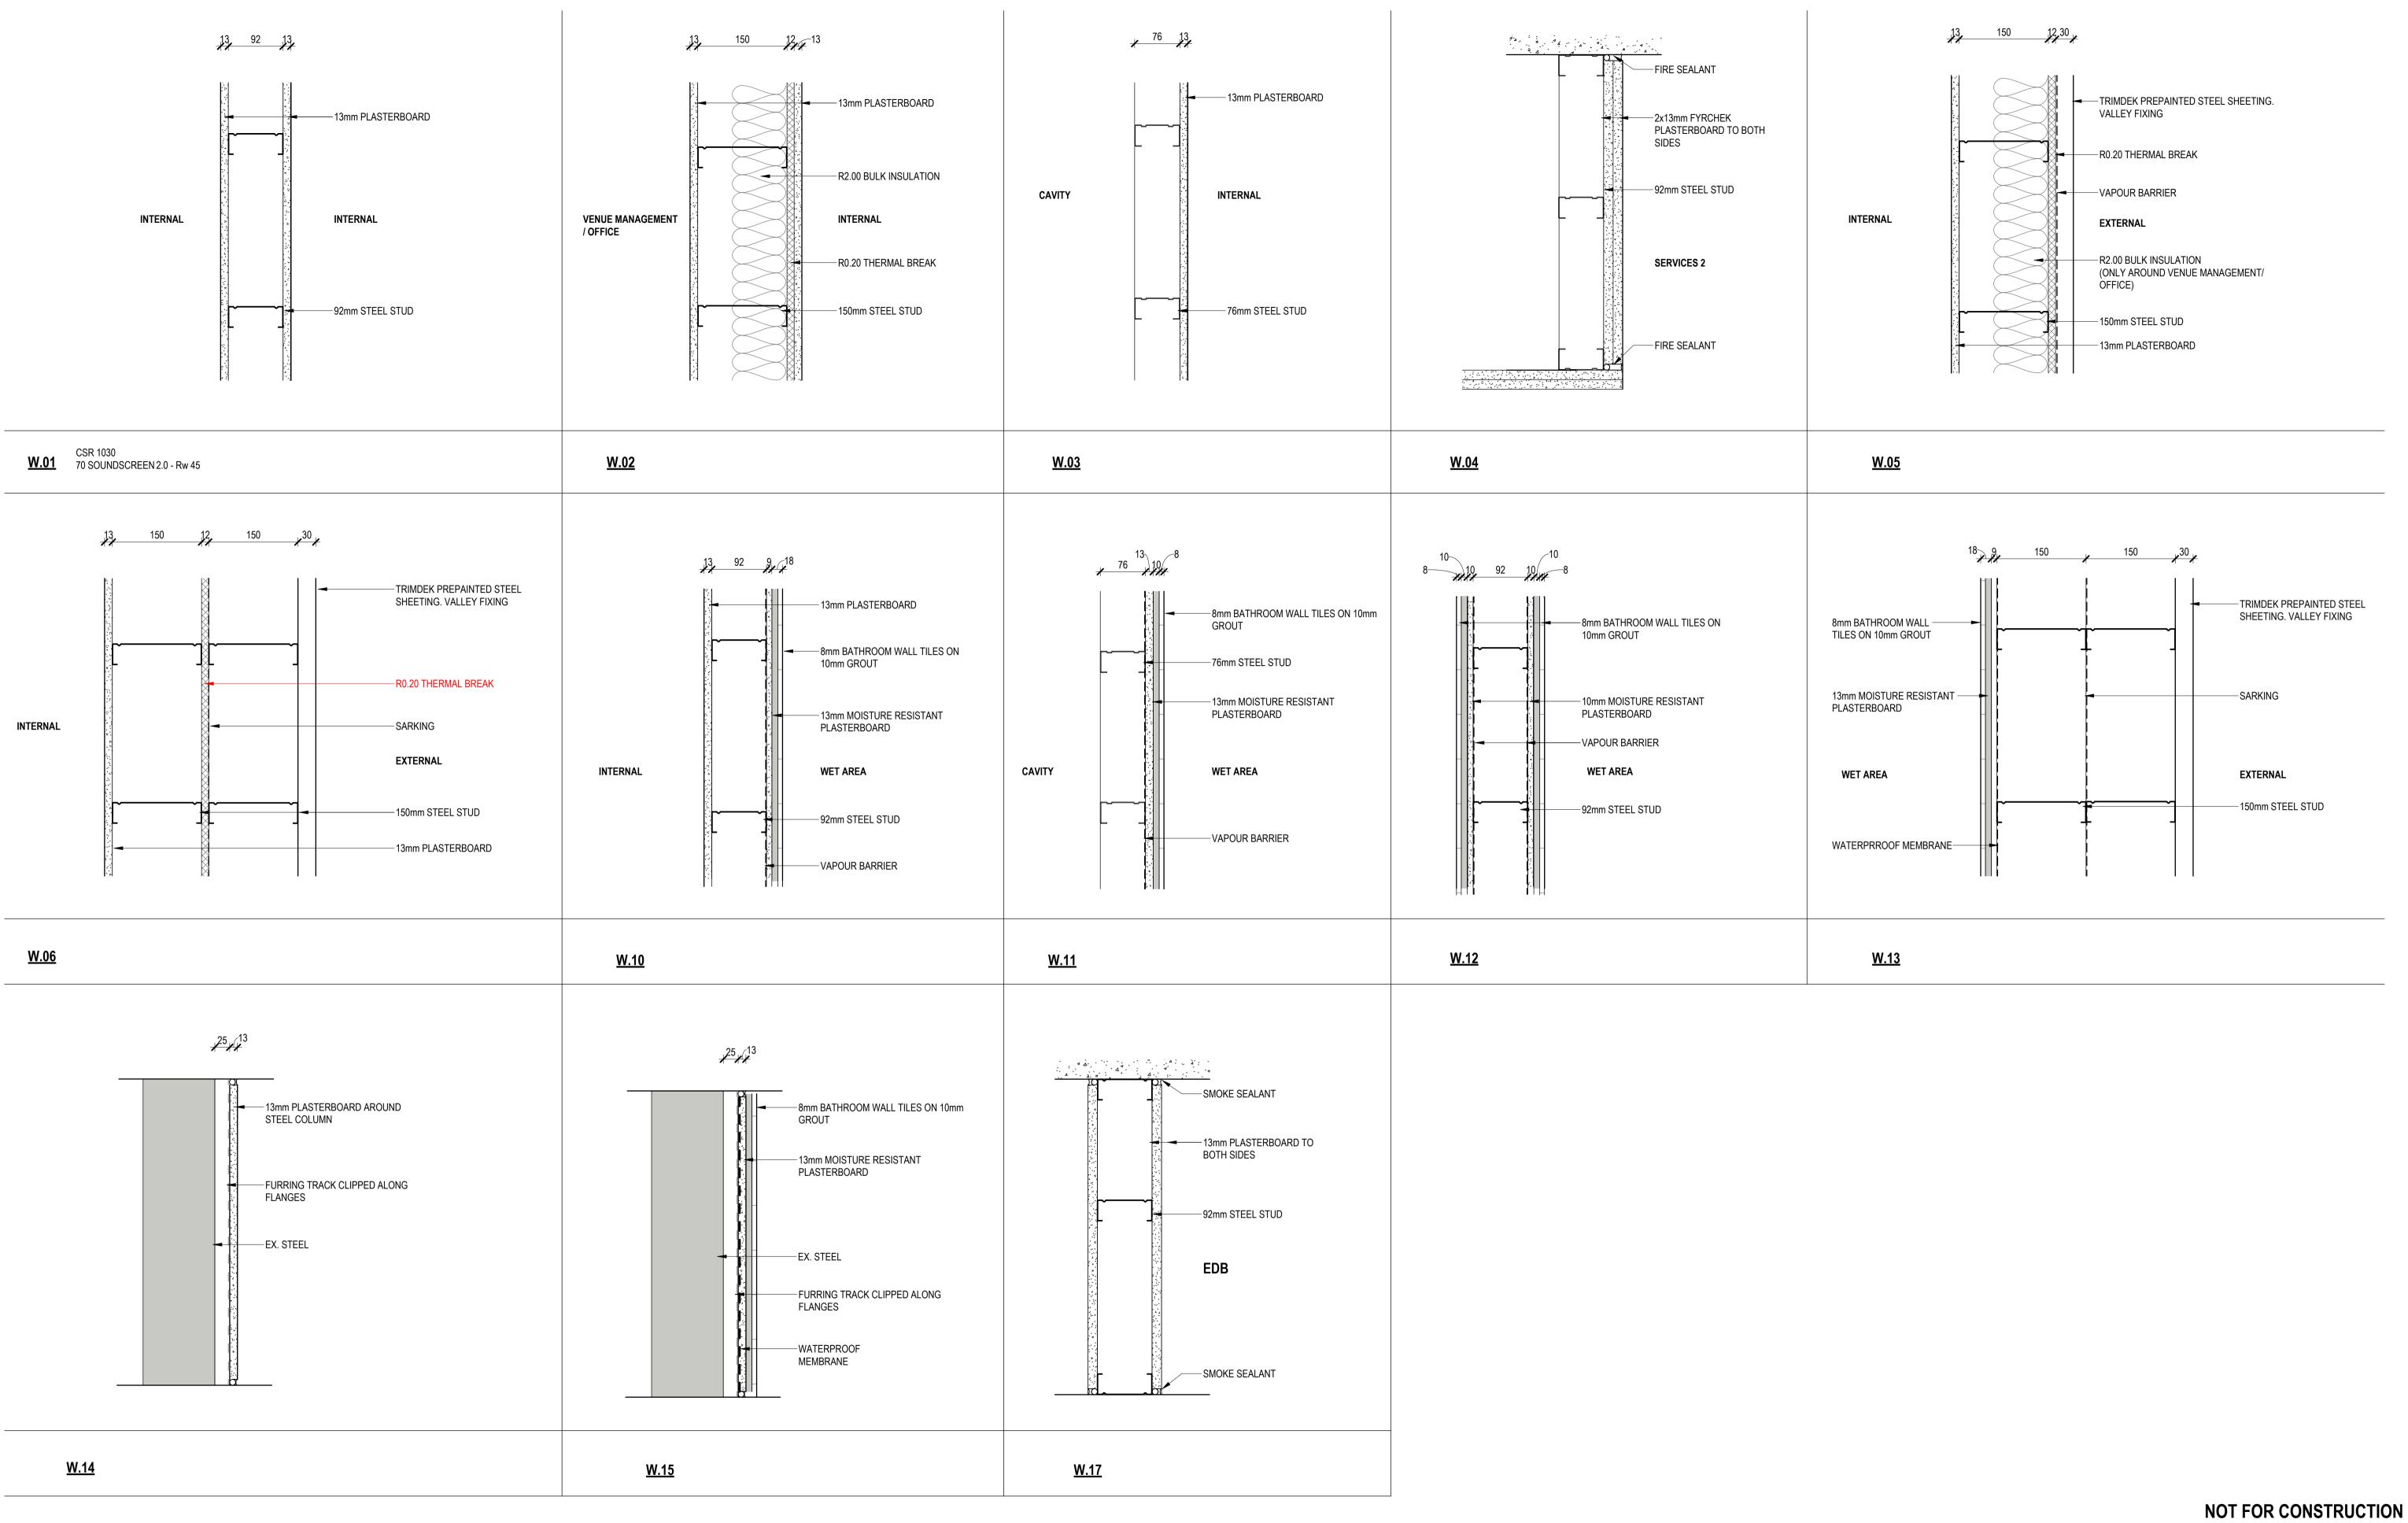

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**Nominated Architects** 

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lan Armstrong



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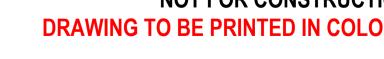
# WORK-IN-PROGRESS

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0 1 2 3 4 5 SCALE BAR - 1:100

WALL TYPE DETAILS - SHEET 1

# **DRAWING TO BE PRINTED IN COLOUR**




**BPR-DIS-AR-DRG-5500** 

TITLE

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STATUS CONCEPT DESIGN SCALES 1 : 5 @ A1


0 1 2 3 4 5 HILL BAR - 1:100

> DRAWING NO. BPR-DIS-AR-DRG-5501

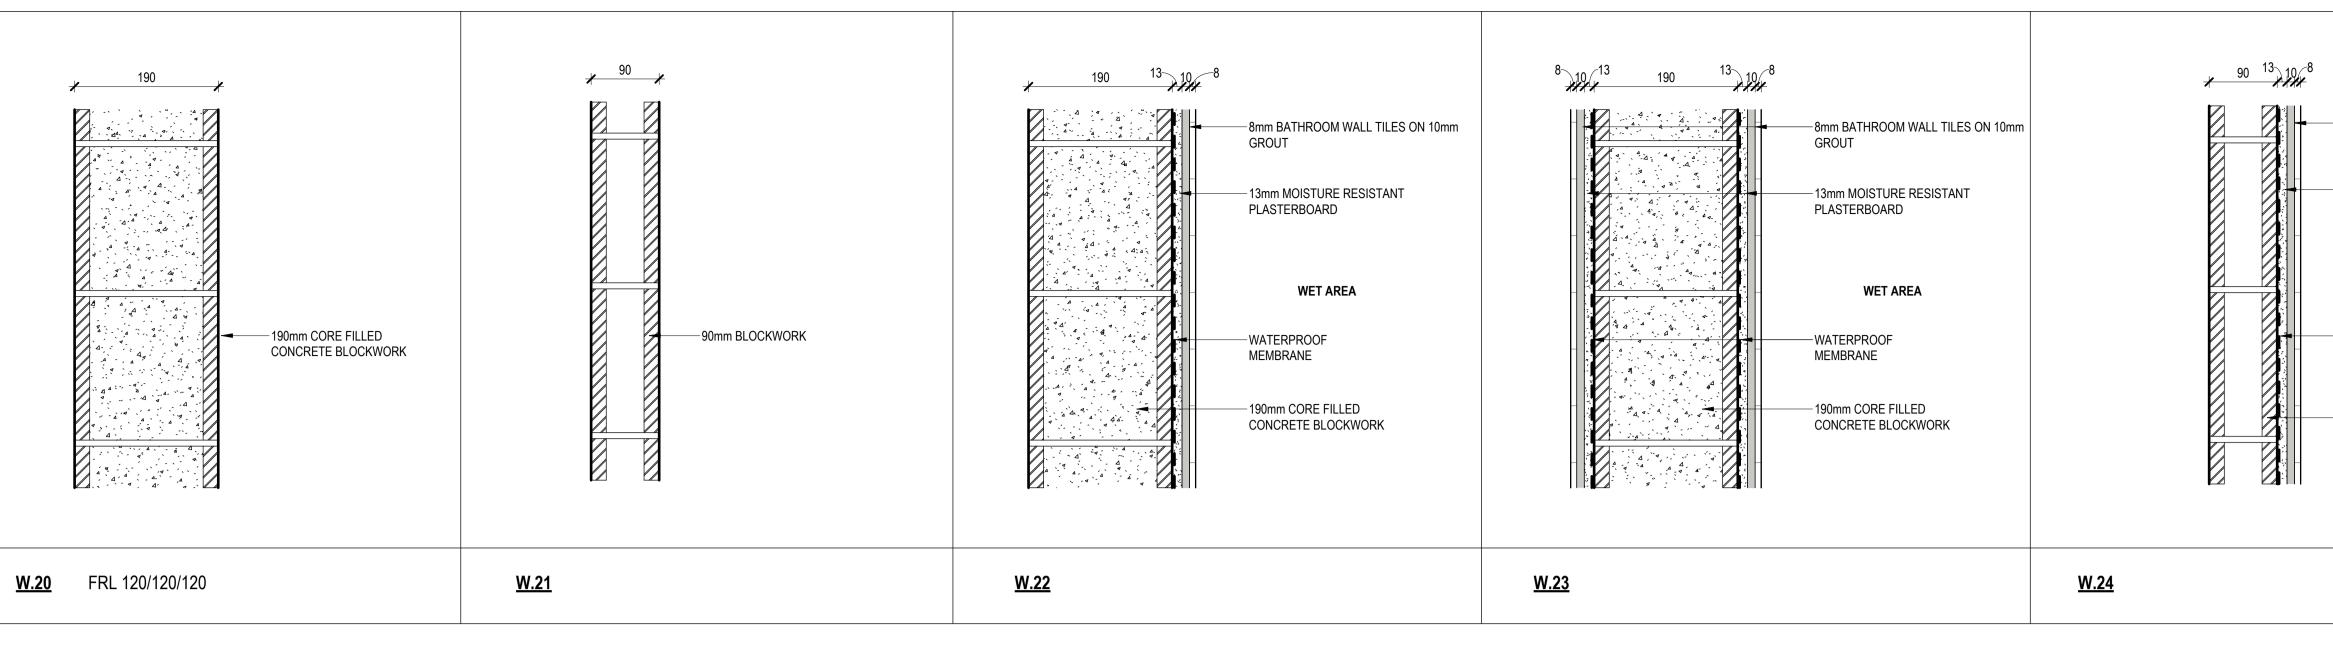revision **A** 

TITLE WALL TYPE DETAILS - SHEET 2

WET AREA
WATERPROOF MEMBRANE
90mm BLOCKWORK

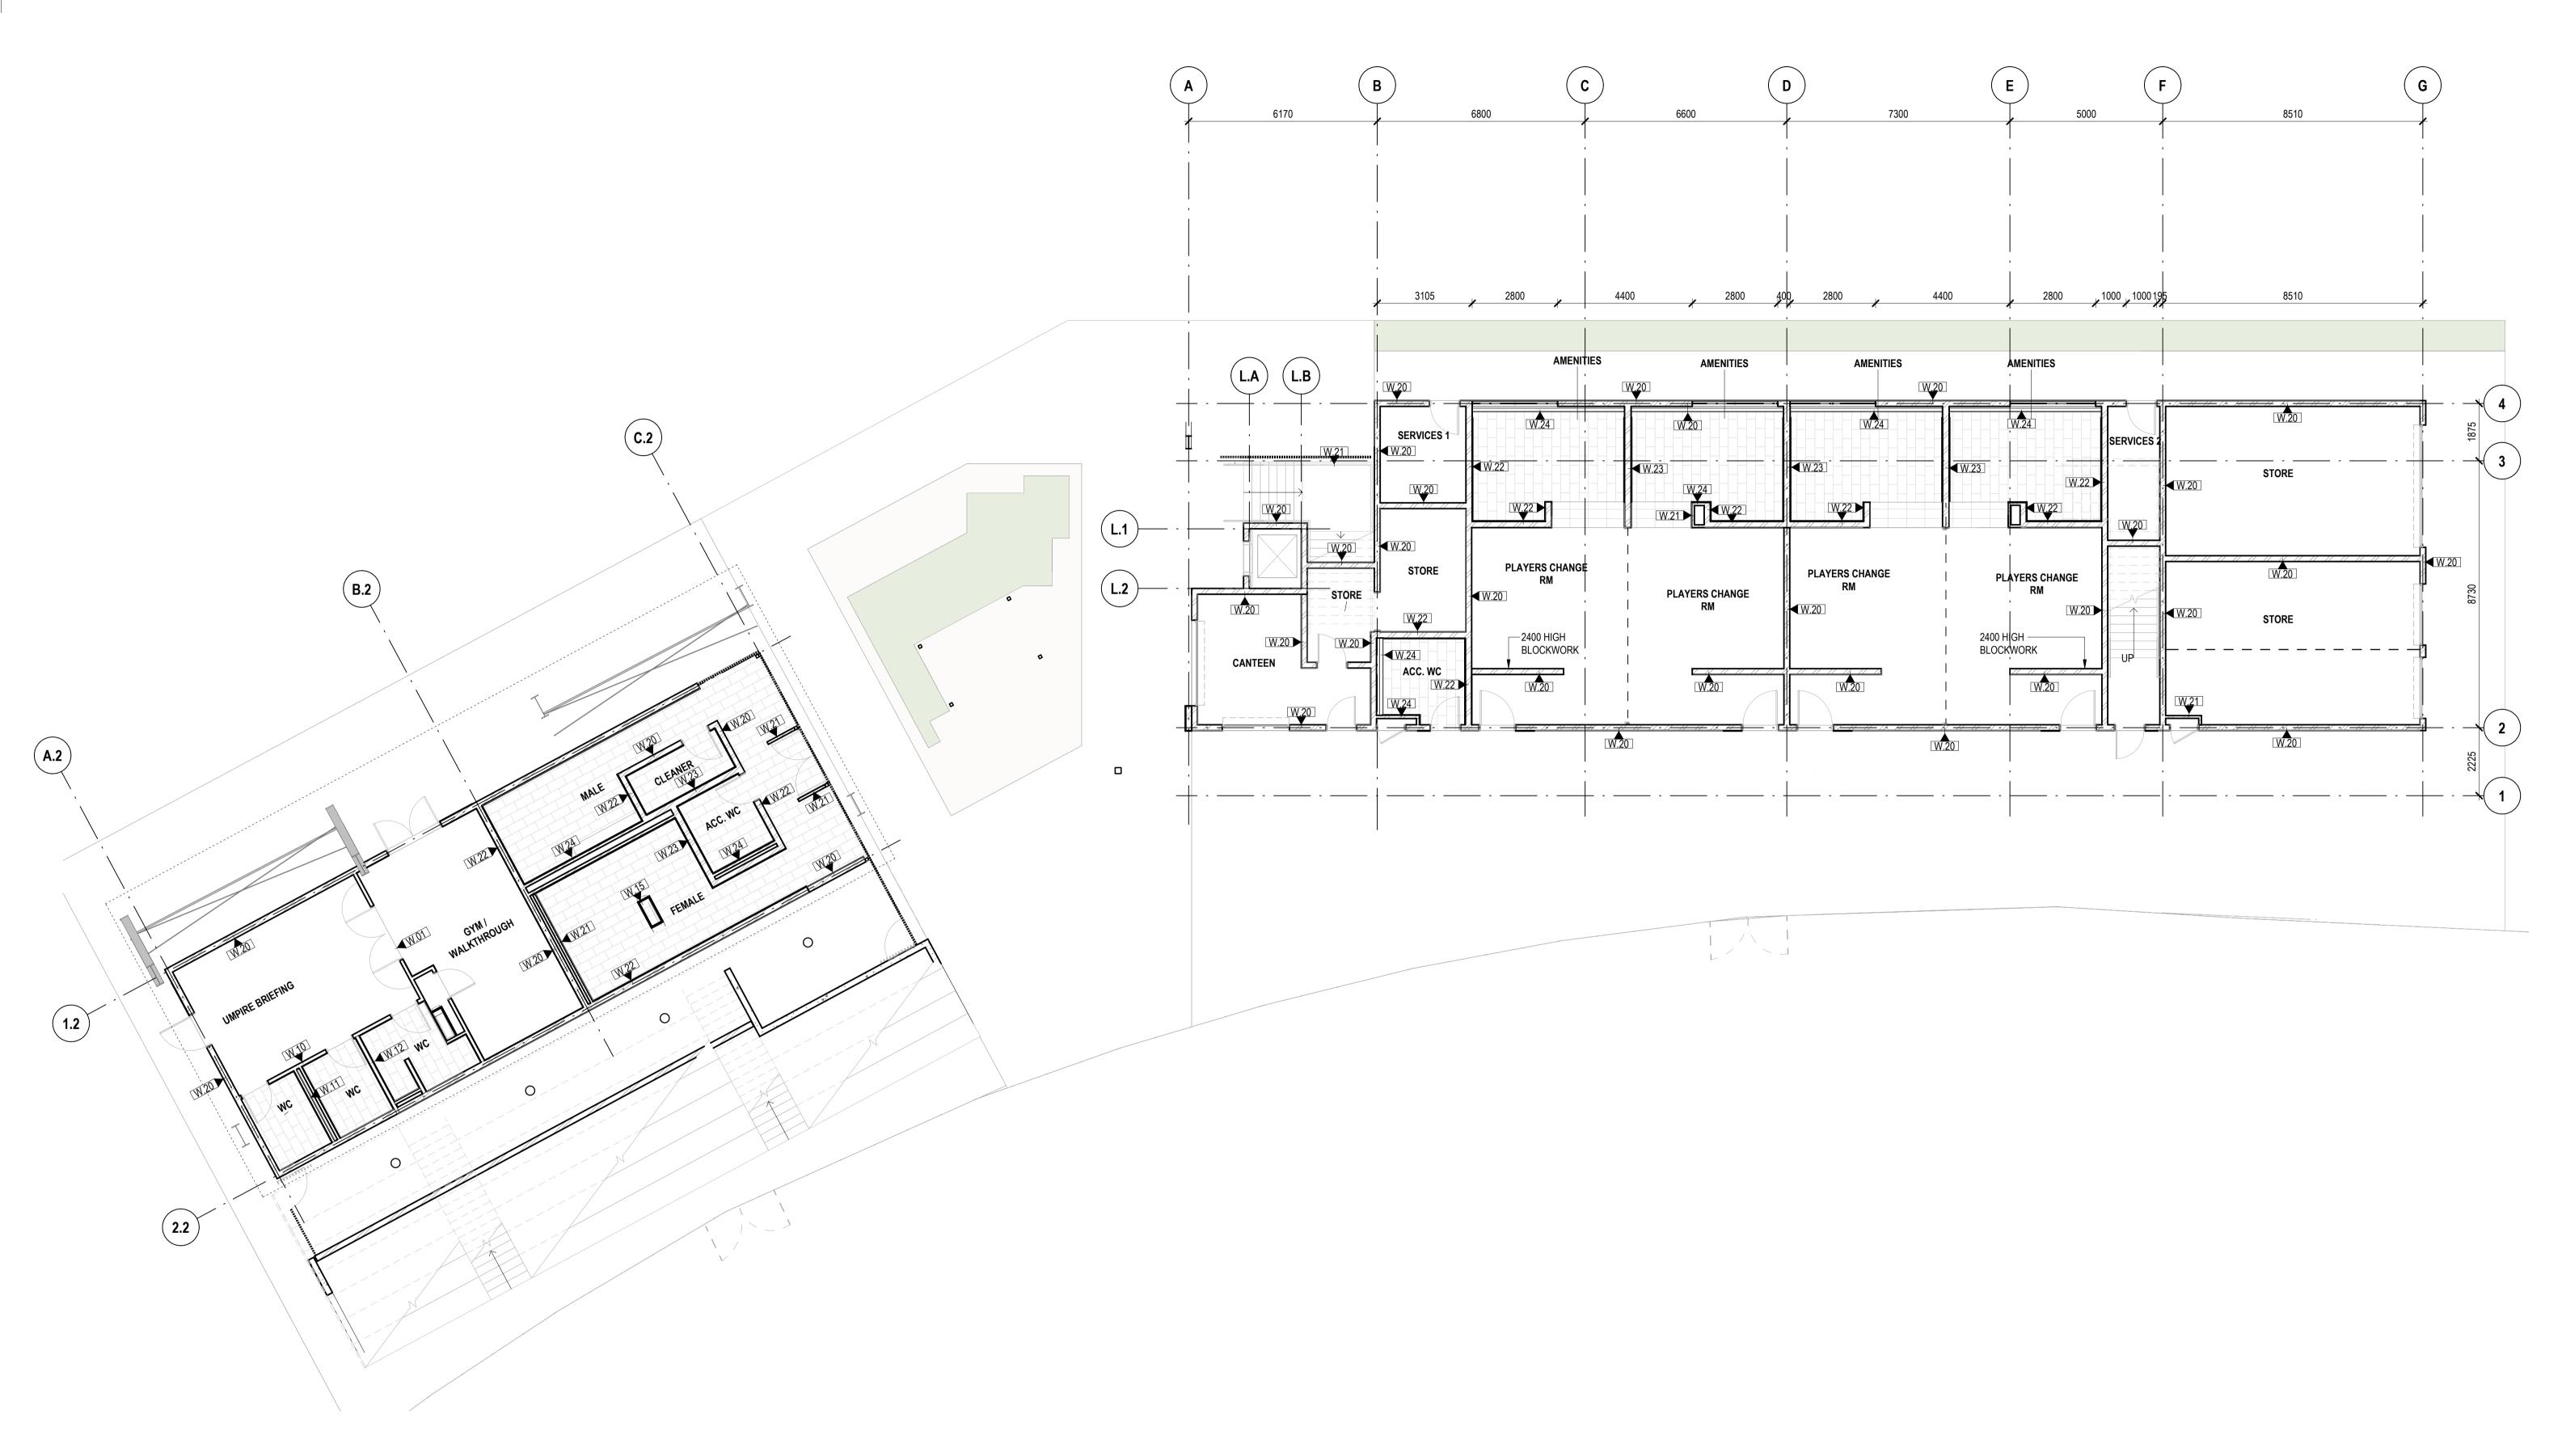



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# PROJECT BOB PRENTER RESERVE **AMENITY BUILDING**

PROJECT ADDRESS Fields Rd, Macquarie Fields NSW 2564

# WORK-IN-PROGRESS

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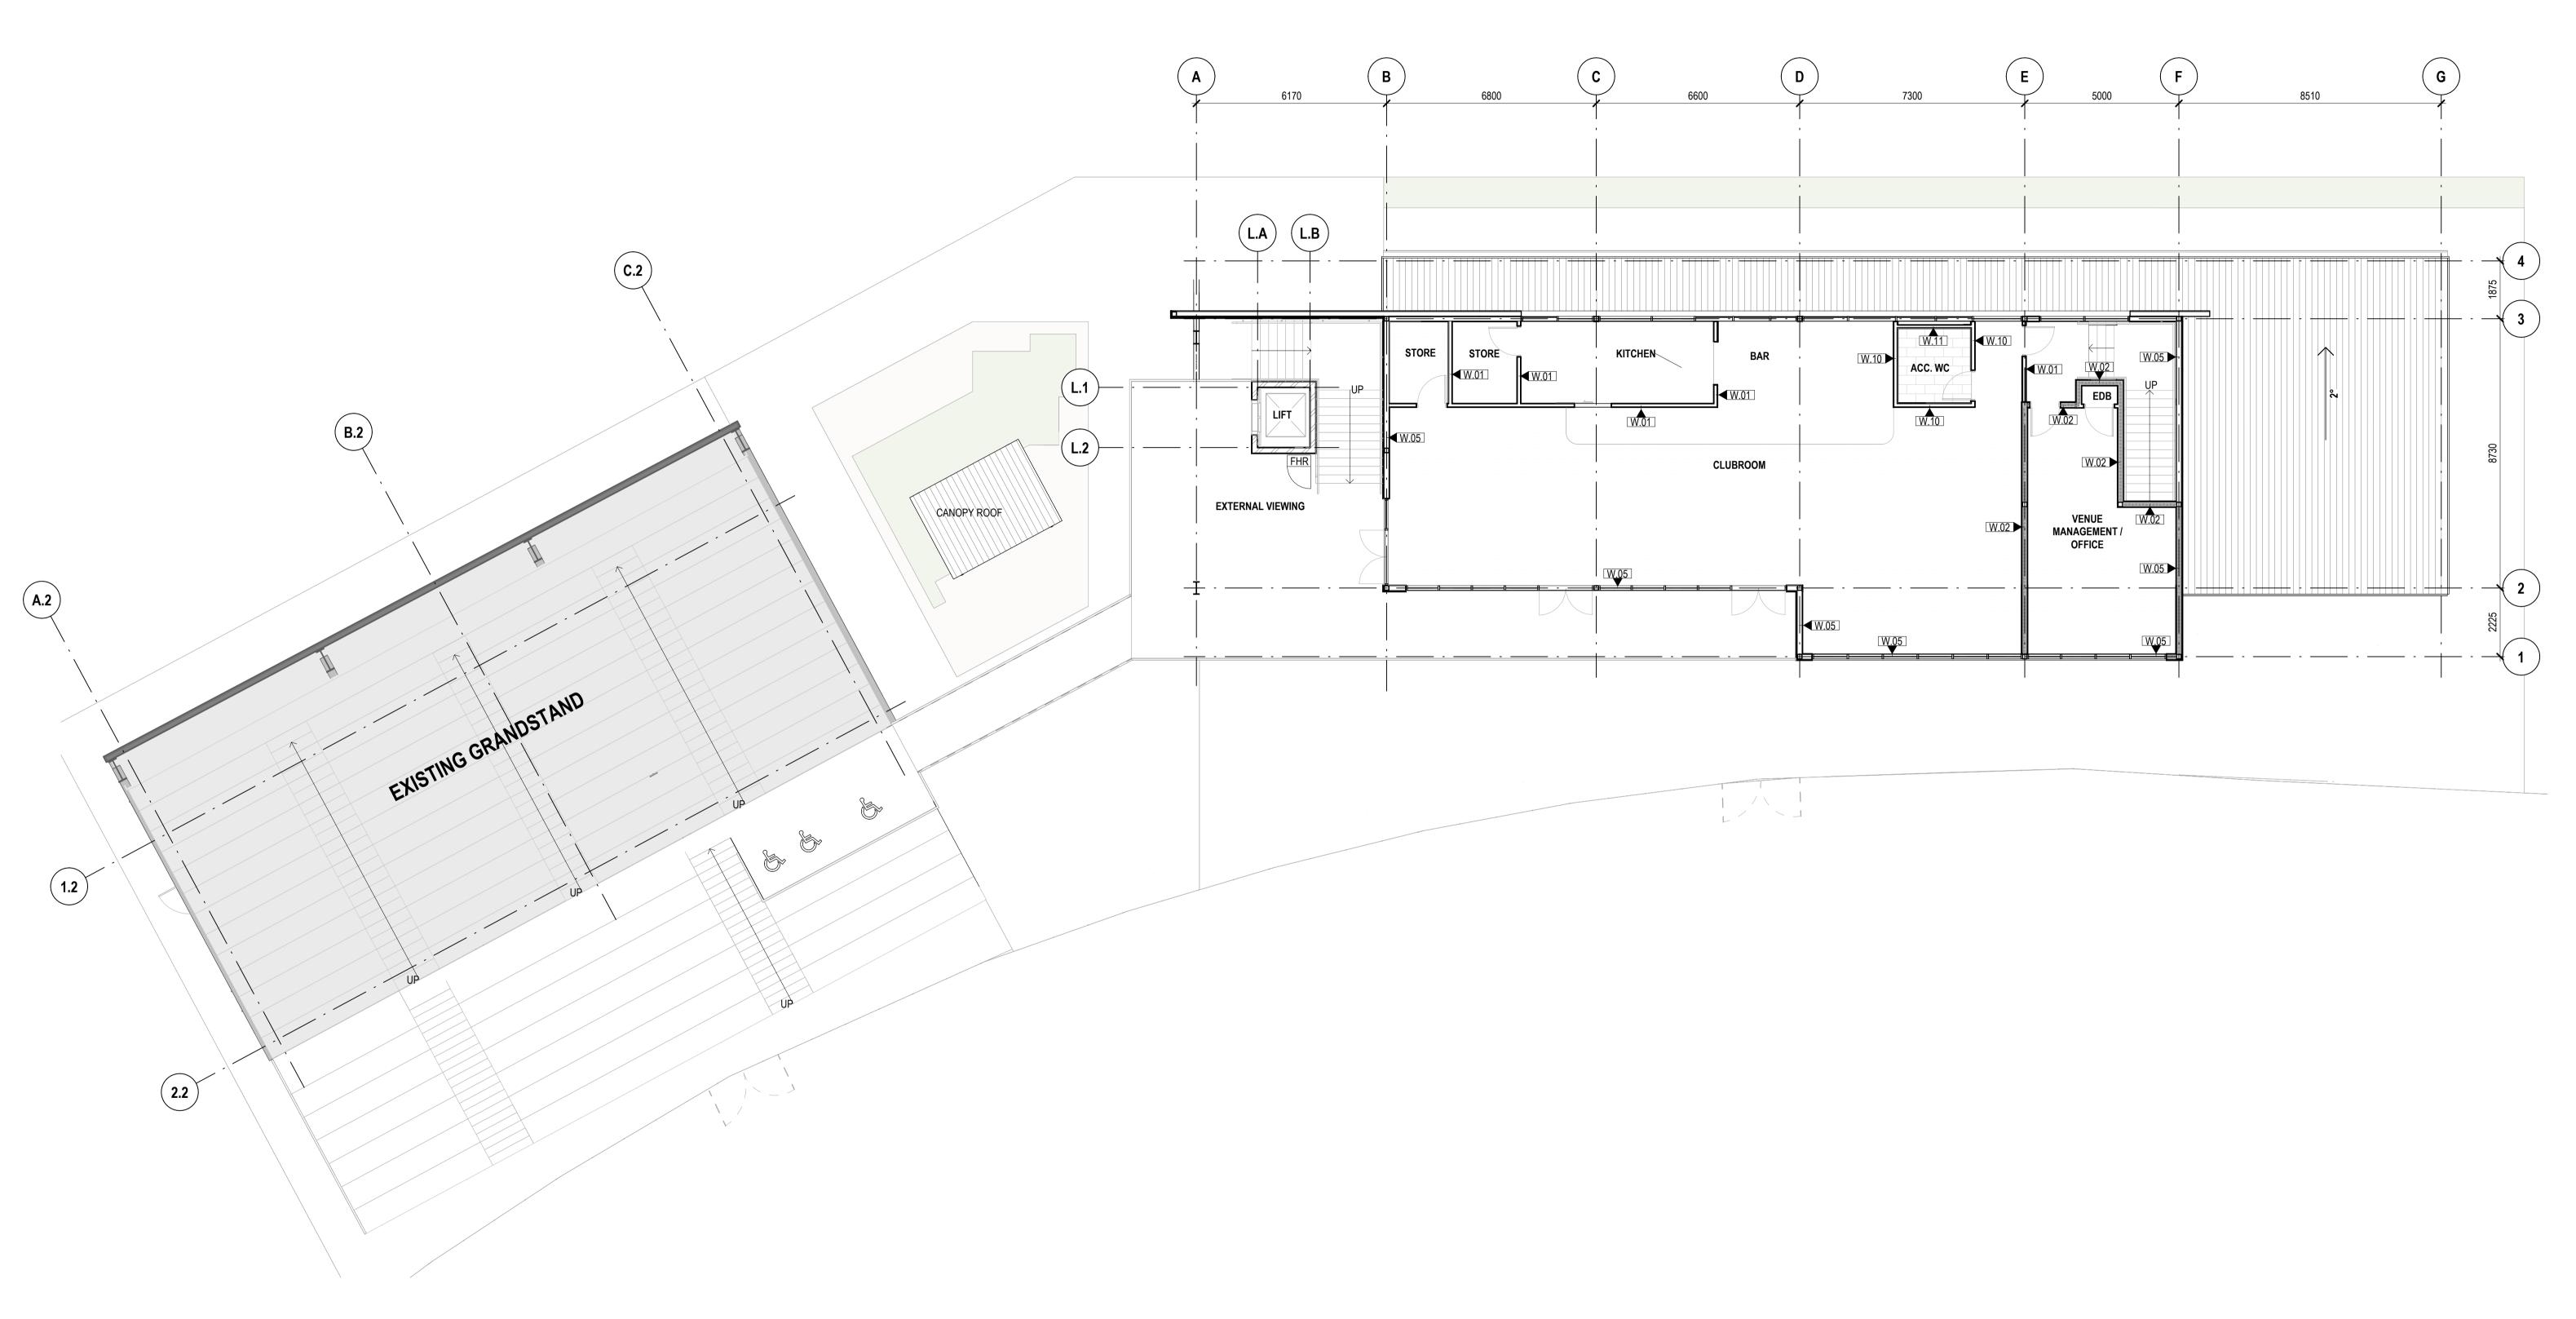
					DRAWING TO BE PRINTED I		
0 ⊮ SCA	1 LE BAF	2 R - 1:10	3 0	4	5 m	TITLE WALL SETOUT PLAN - G FLOOR	
	ATUS ALES		PT DES ) @ A1	IGN		DRAWING NO. BPR-DIS-AR-DRG-5600	

NOT FOR CONSTRUCTION DRAWING TO BE PRINTED IN COLOUR

GROUND

REVISION

Α





**Designing** Gadigal Country Level 12, 126 Phillip Street, Sydney NSW 2000 +61 2 8905 7100 Reception@sydney.designinc.com.au

Ian Armstrong7260Cathryn Drew-Bredin7269Cameron Martin9194Mary Anne McGirr10946

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Nominated Architects

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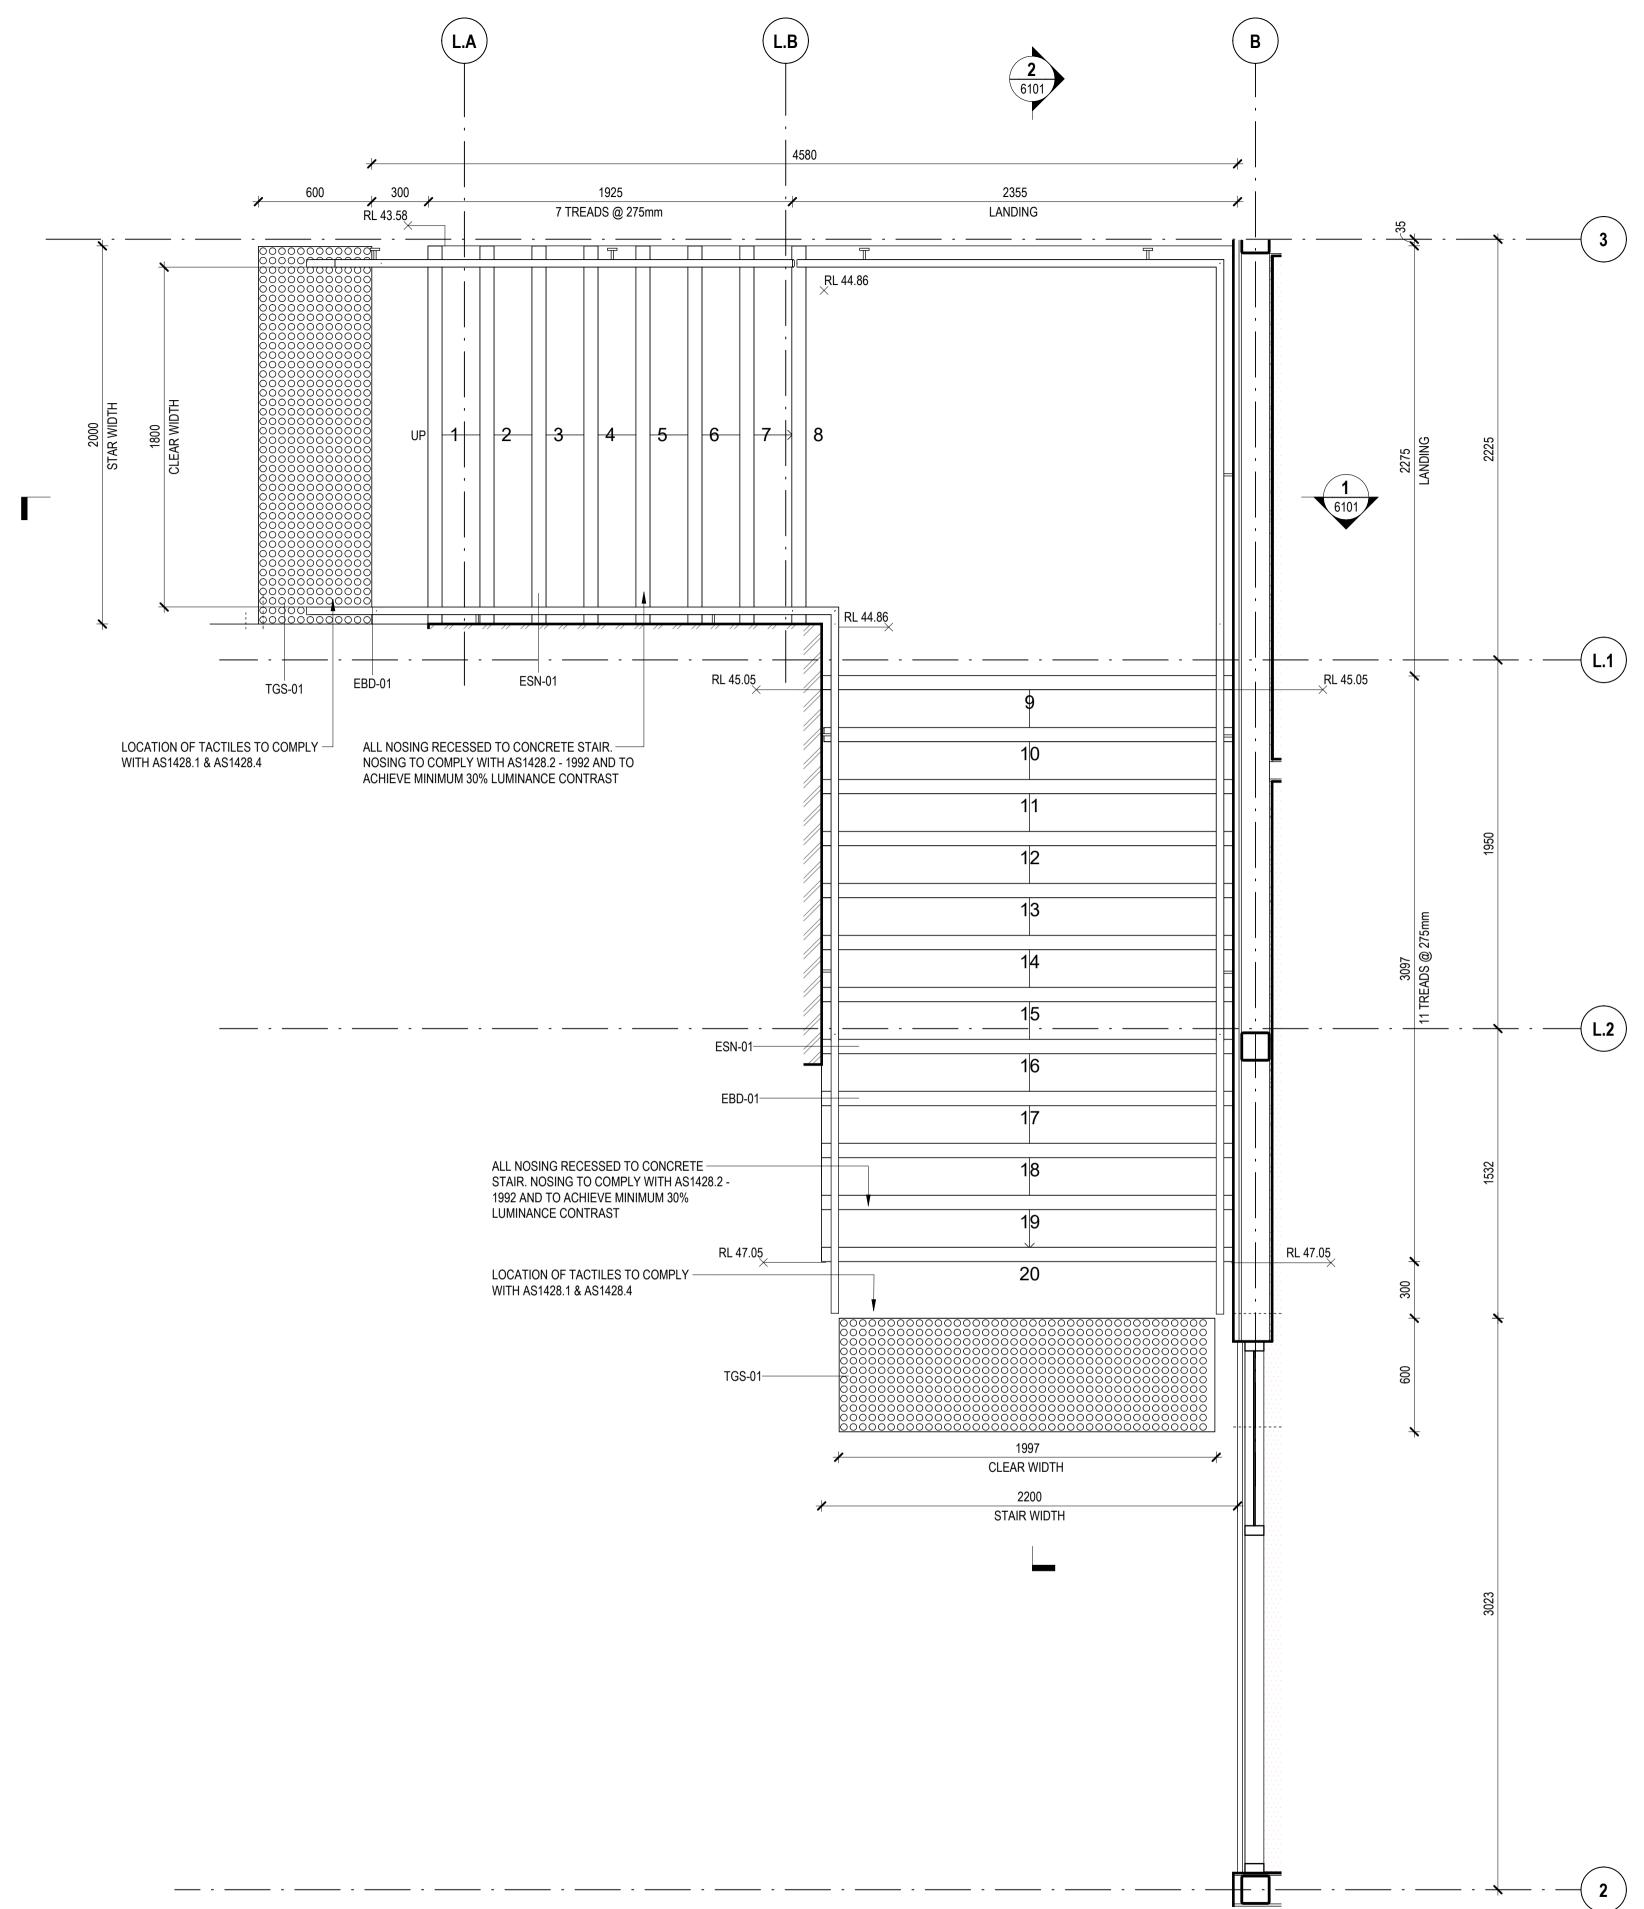
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STATUS CONCEPT DESIGN **SCALES** 1 : 100 @ A1

DRAWING NO. **BPR-DIS-AR-DRG-5601**  REVISION A

TITLE WALL SETOUT PLAN - LEVEL 1





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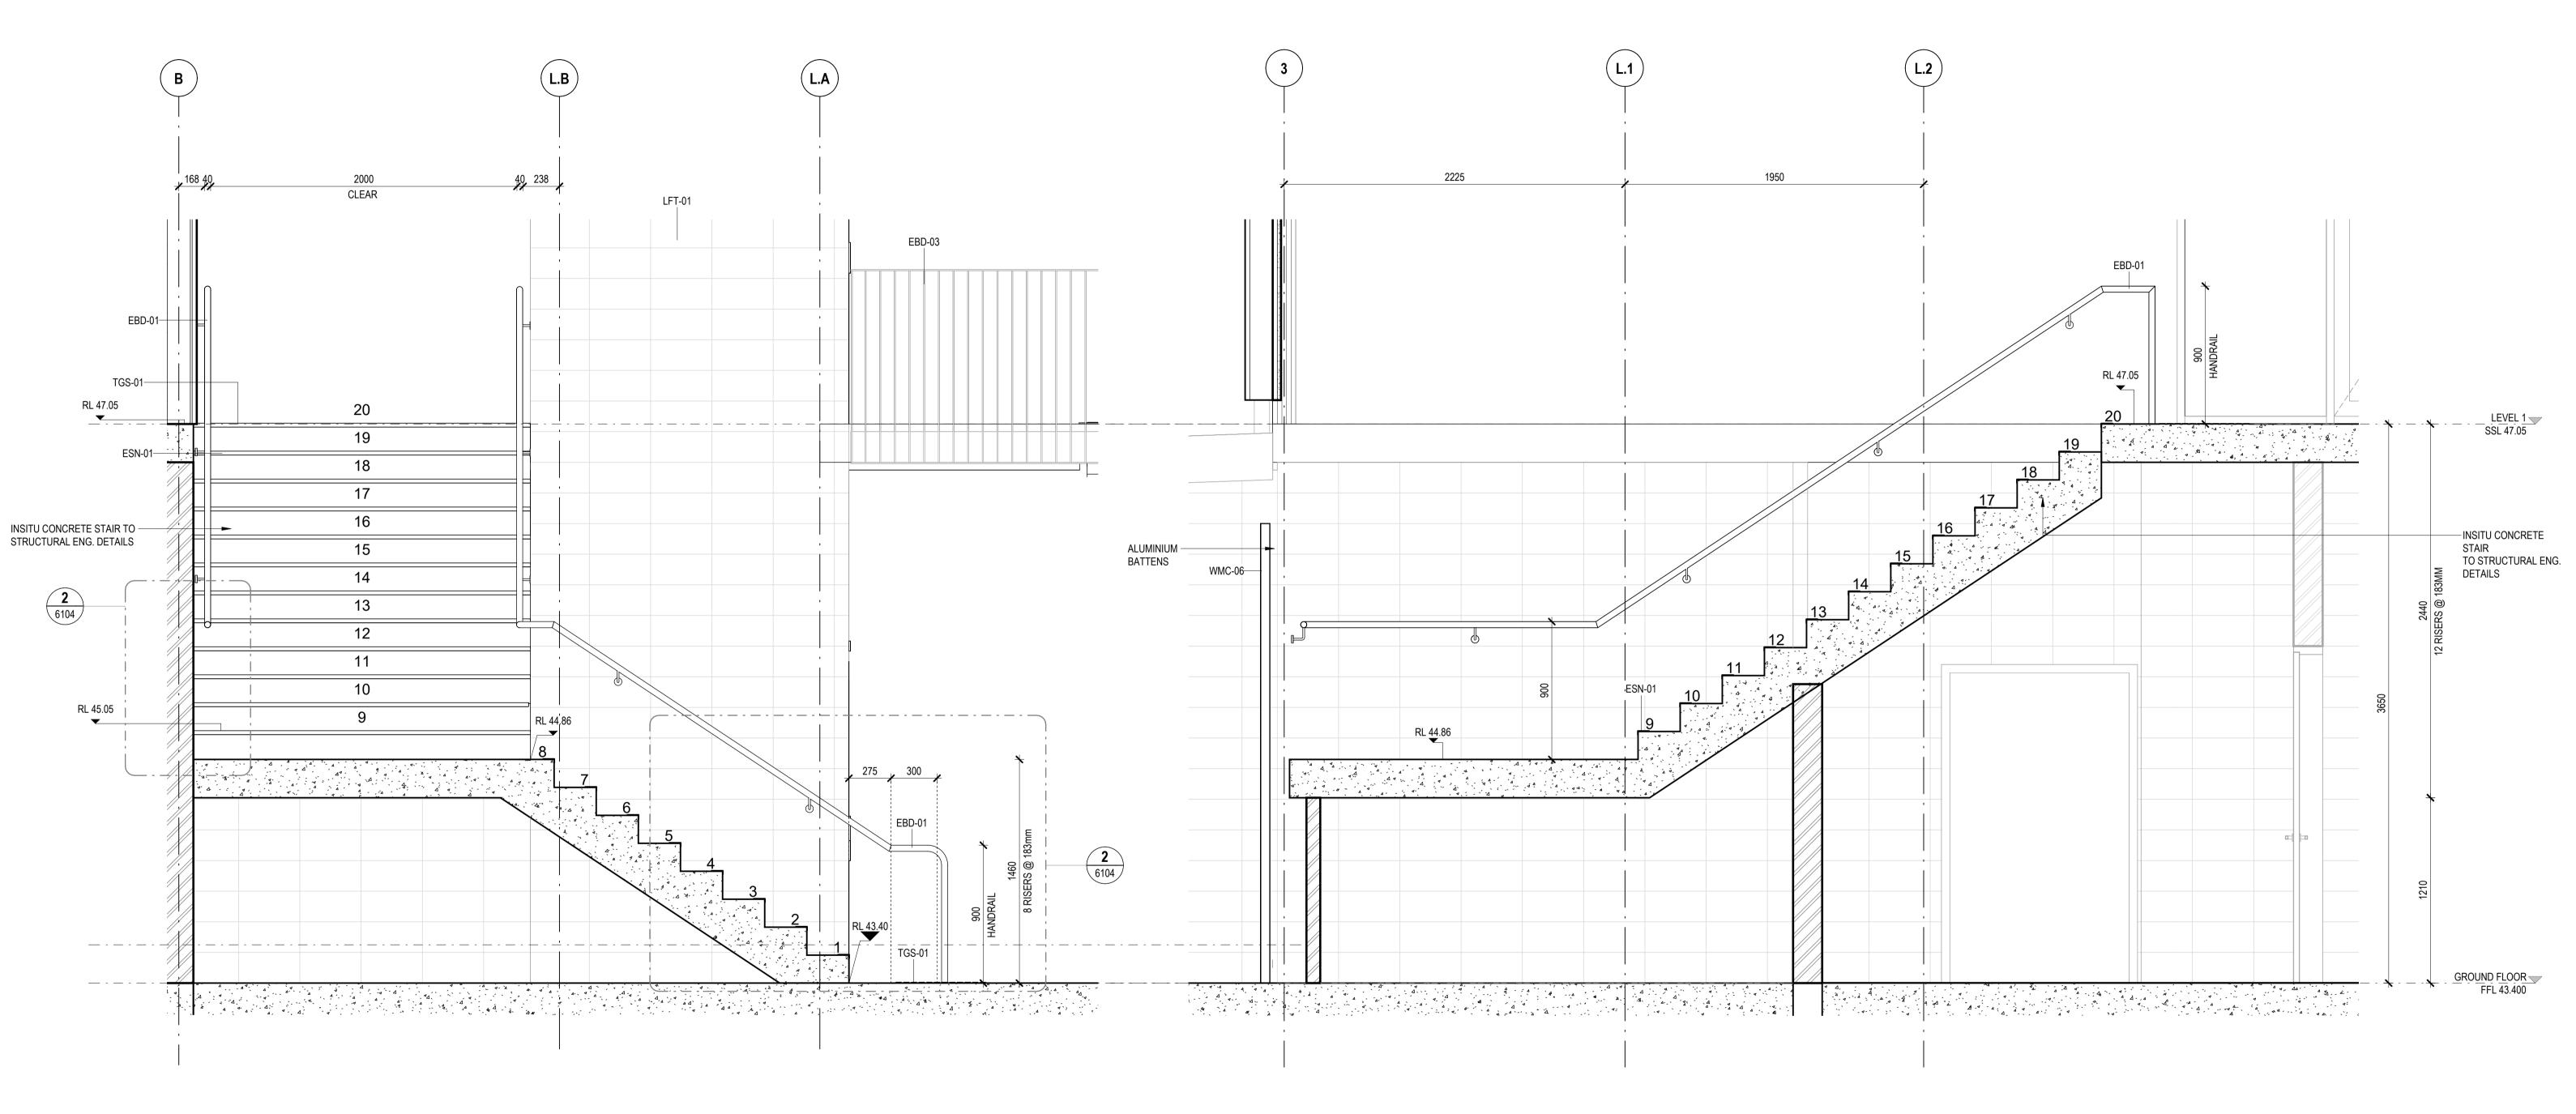
SCALES 1 : 20 @ A1

0 1 2 3 4 5

DRAWING NO. **BPR-DIS-AR-DRG-6100** 



TITLE STAIR 1 - PLANS



1 STAIR 1 - SECTION A SCALE 1:20

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0 1 2 3 4 5 SCALE BAR - 1:100 STATUS CONCEPT DESIGN

SCALES 1 : 20 @ A1

**STAIR 1 - SECTIONS** 

BPR-DIS-AR-DRG-6101


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STATUS CONCEPT DESIGN DRAWN BY Author SCALES 1 : 20 @ A1 CHECKED BY Checker APPROVED BY Approver

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0 1 2 3 4 5 ╎╵╵╵┼╶╷╴┍╾╍┑╻╻╻╻ SCALE BAR - 1:100

STAIR 2 - PLANS

BPR-DIS-AR-DRG-6102


TITLE
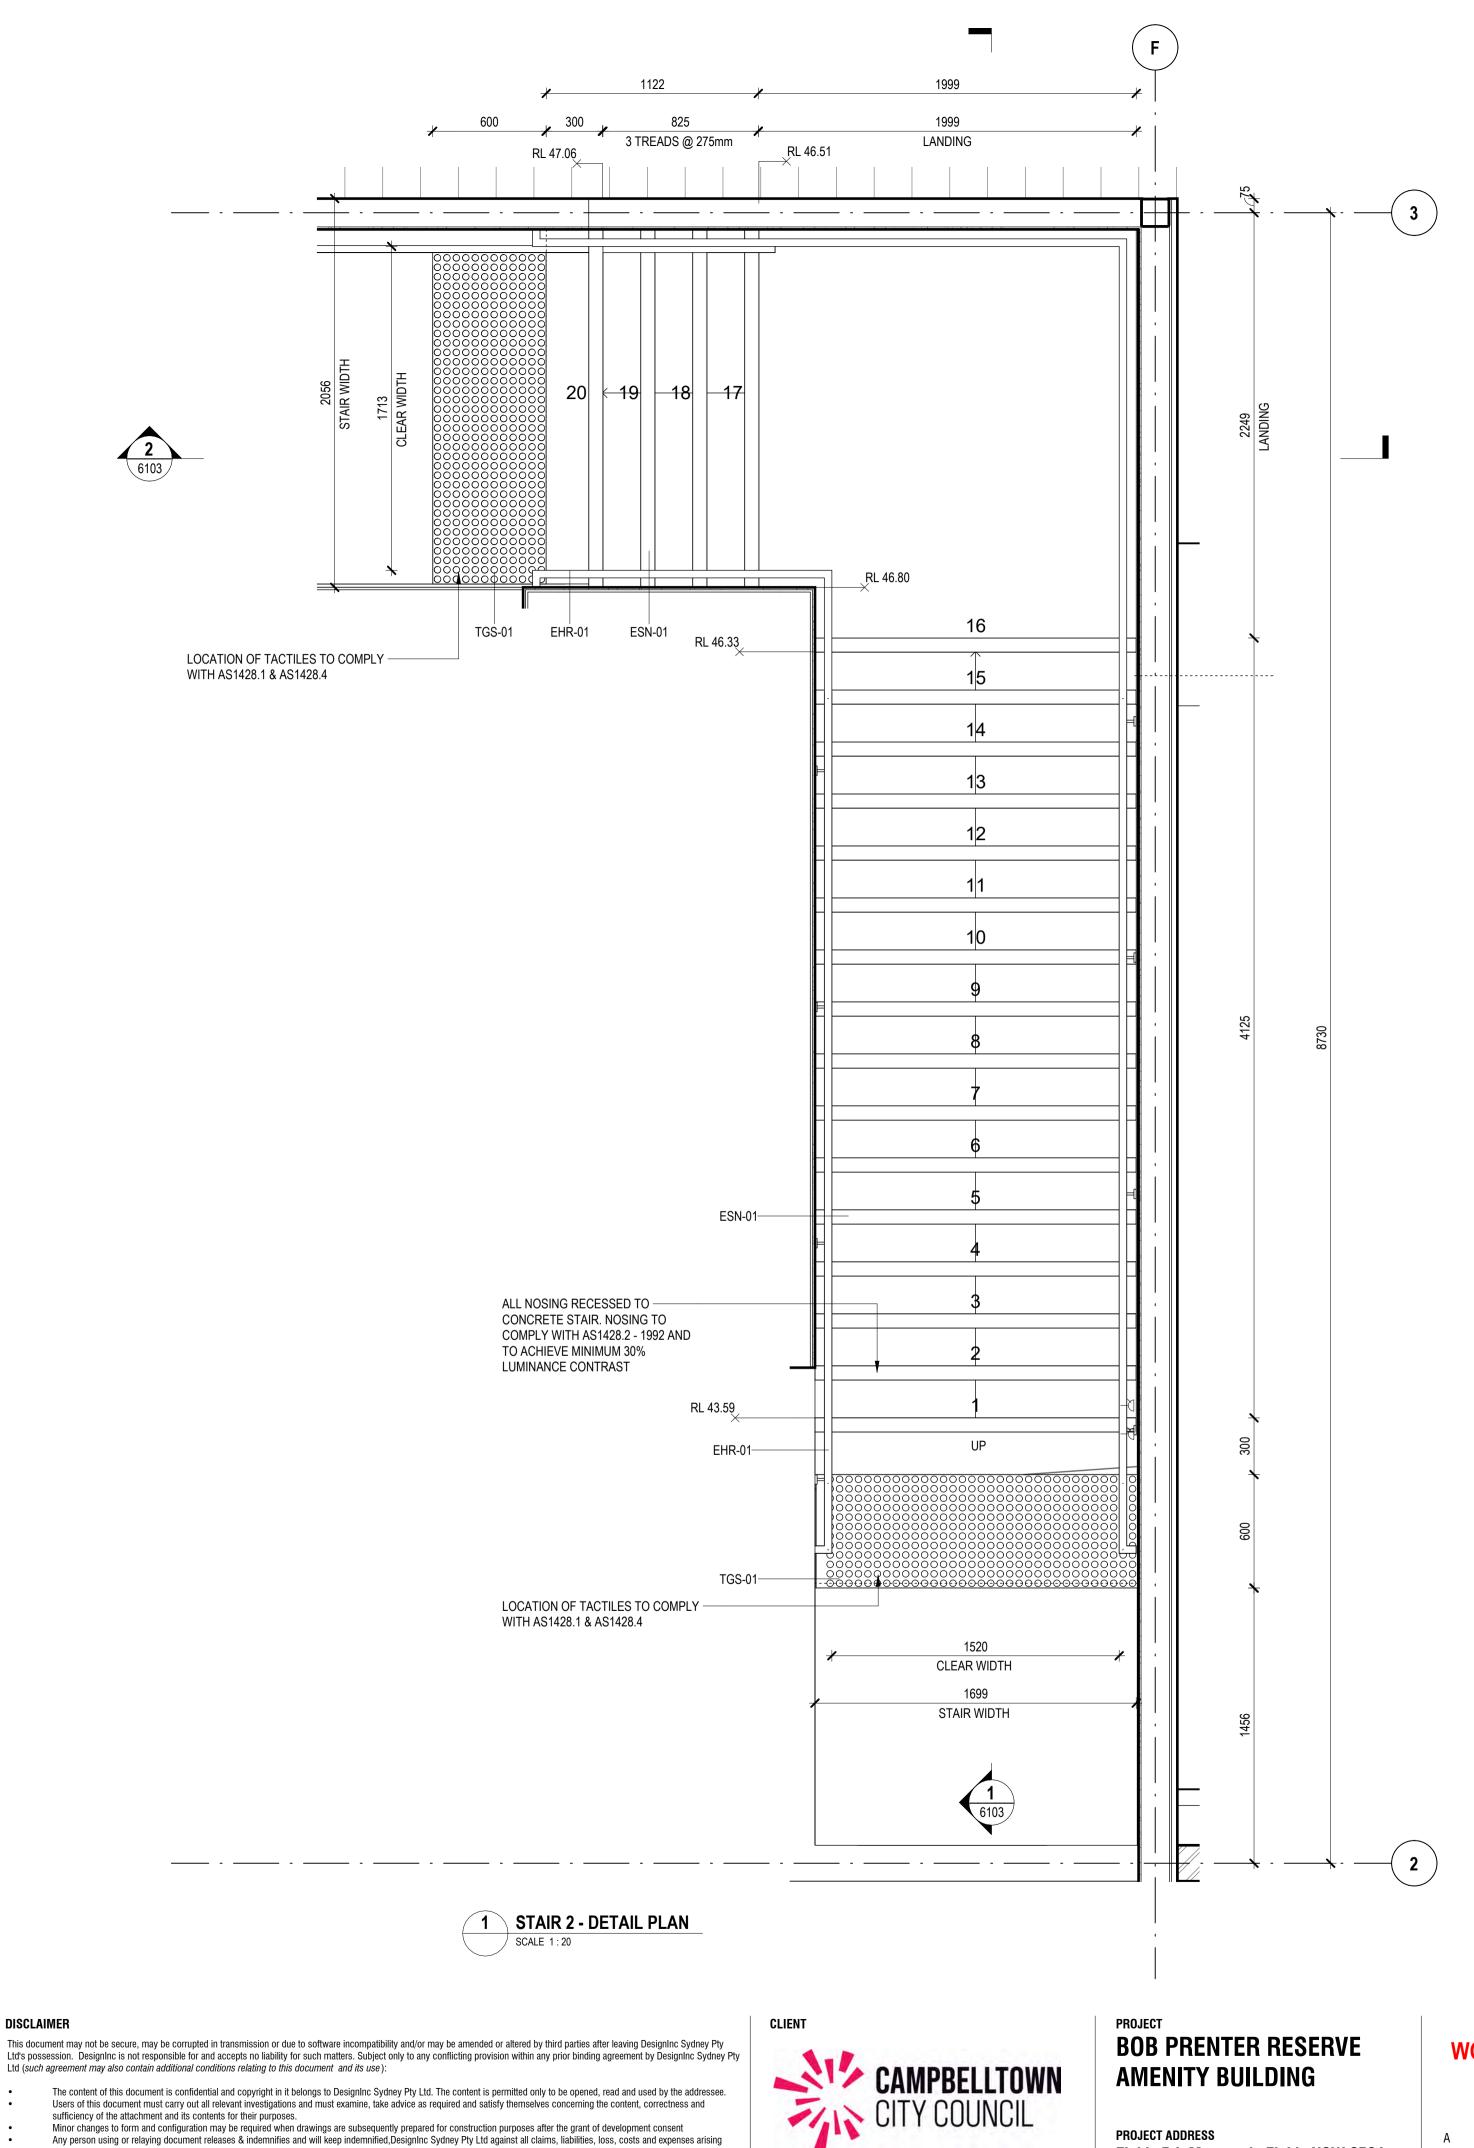
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1 STAIR 2 - SECTION A SCALE 1:20

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**SCALES** 1 : 20 @ A1

**STAIR 2 - SECTIONS** 


**BPR-DIS-AR-DRG-6103** 

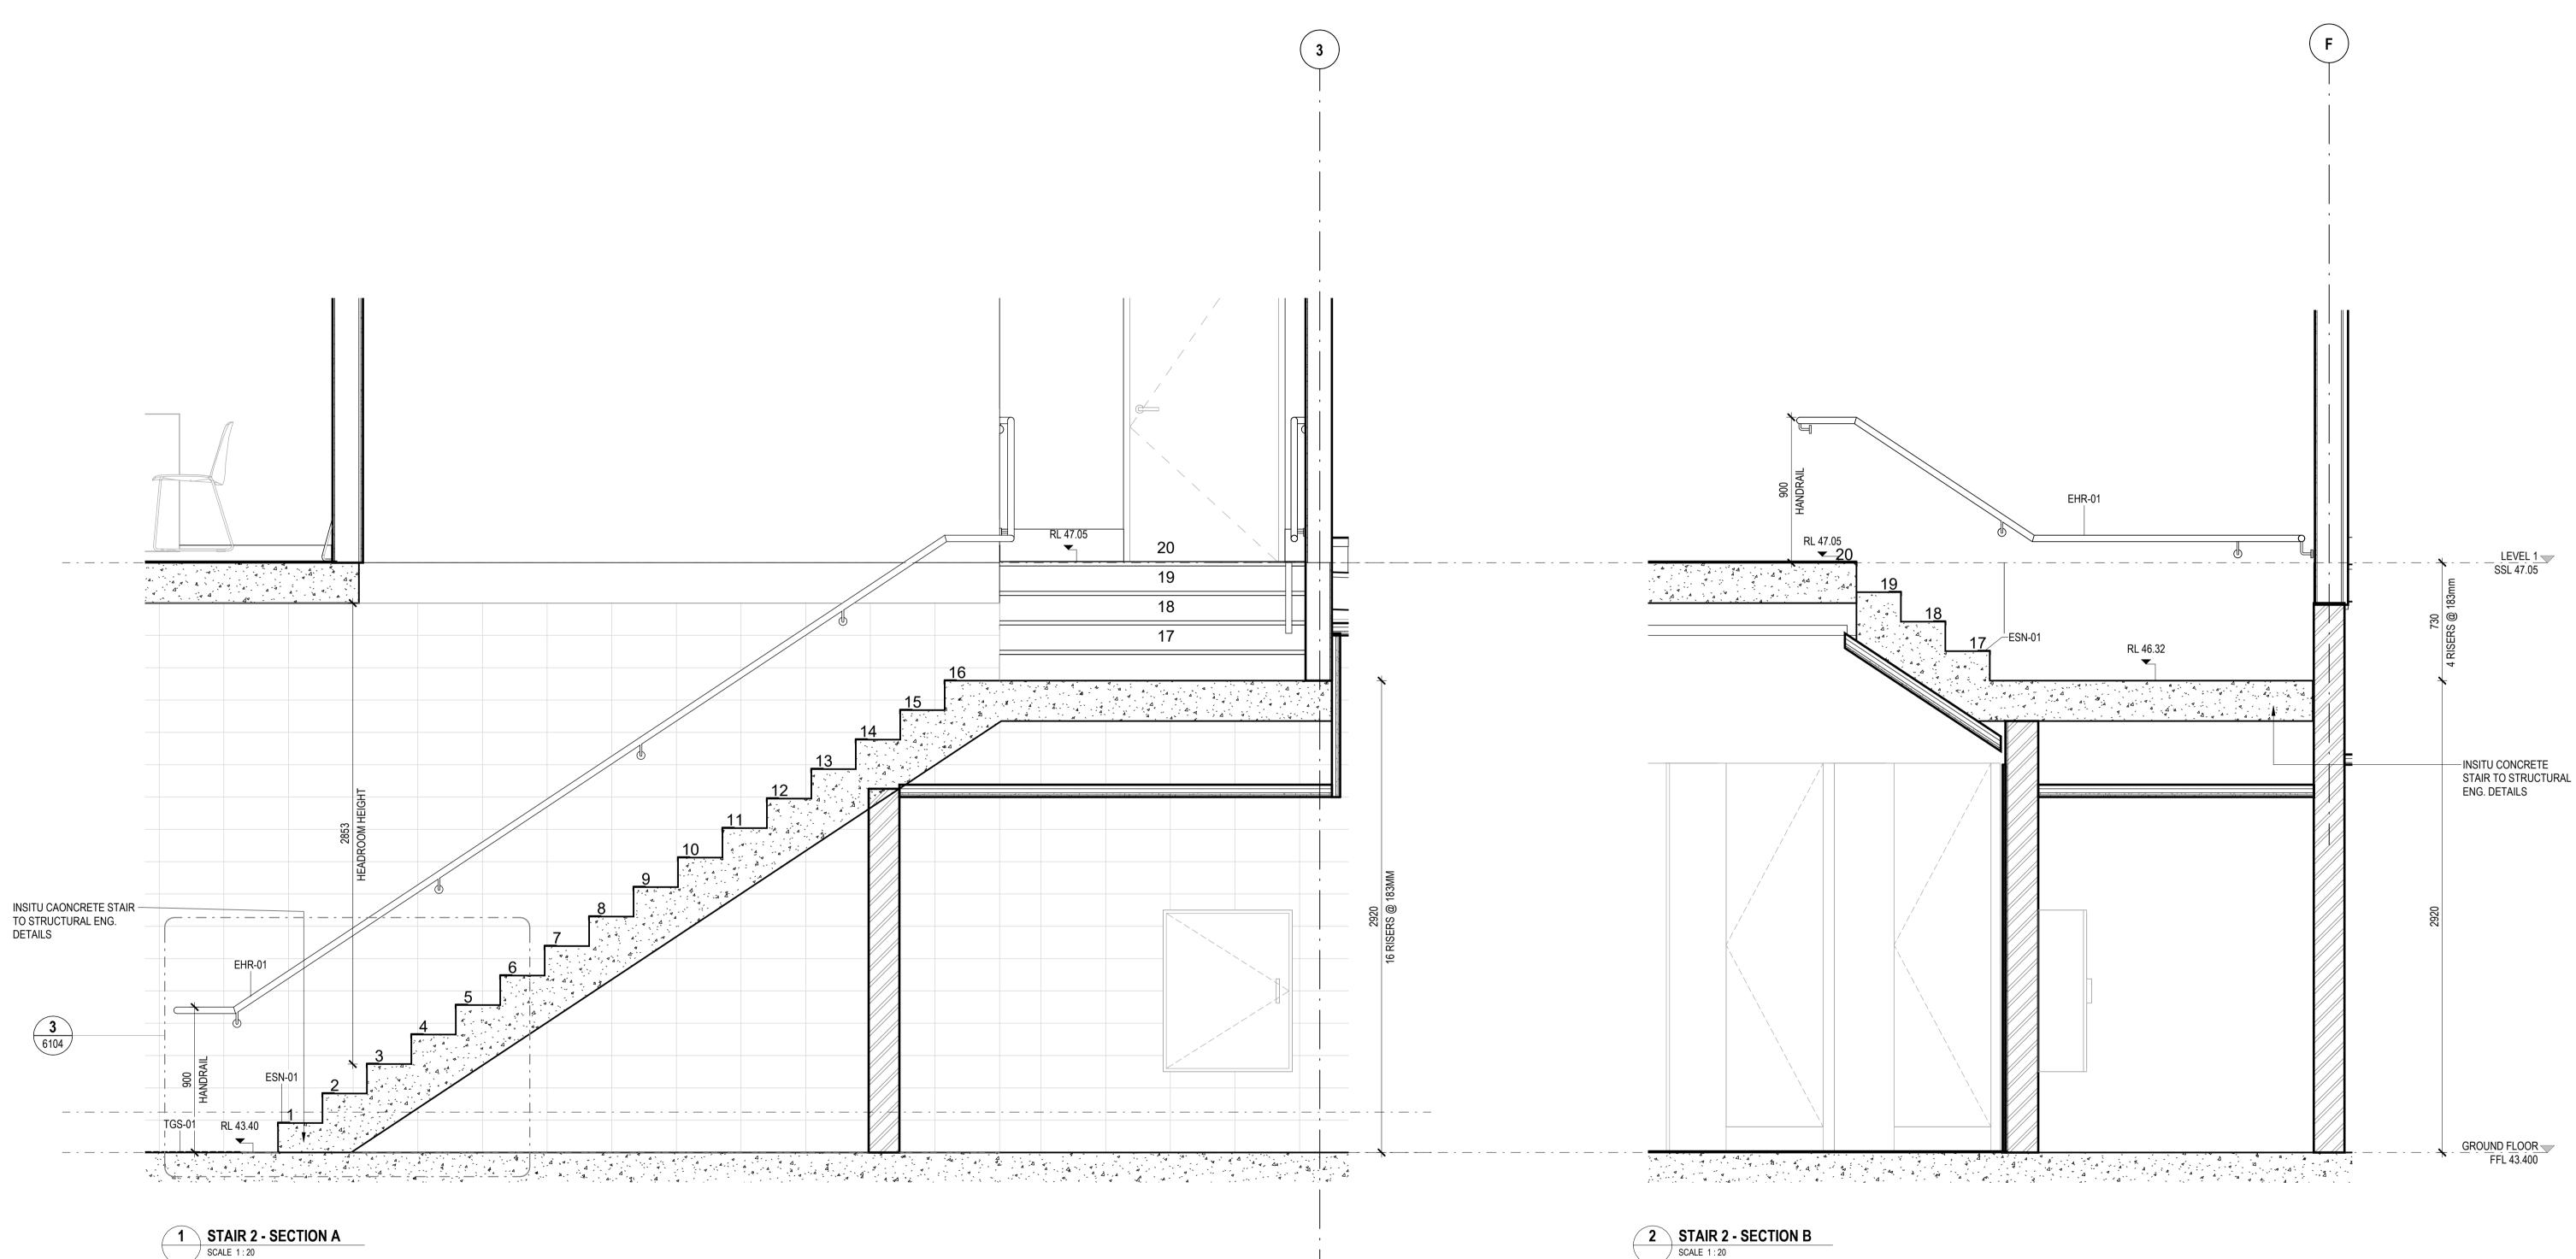TITLE

DRAWING NO.

REVISION

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2 STAIR 1 DETAIL - FLOOR MOUNTED HANDRAIL TERMINATION SCALE 1:10
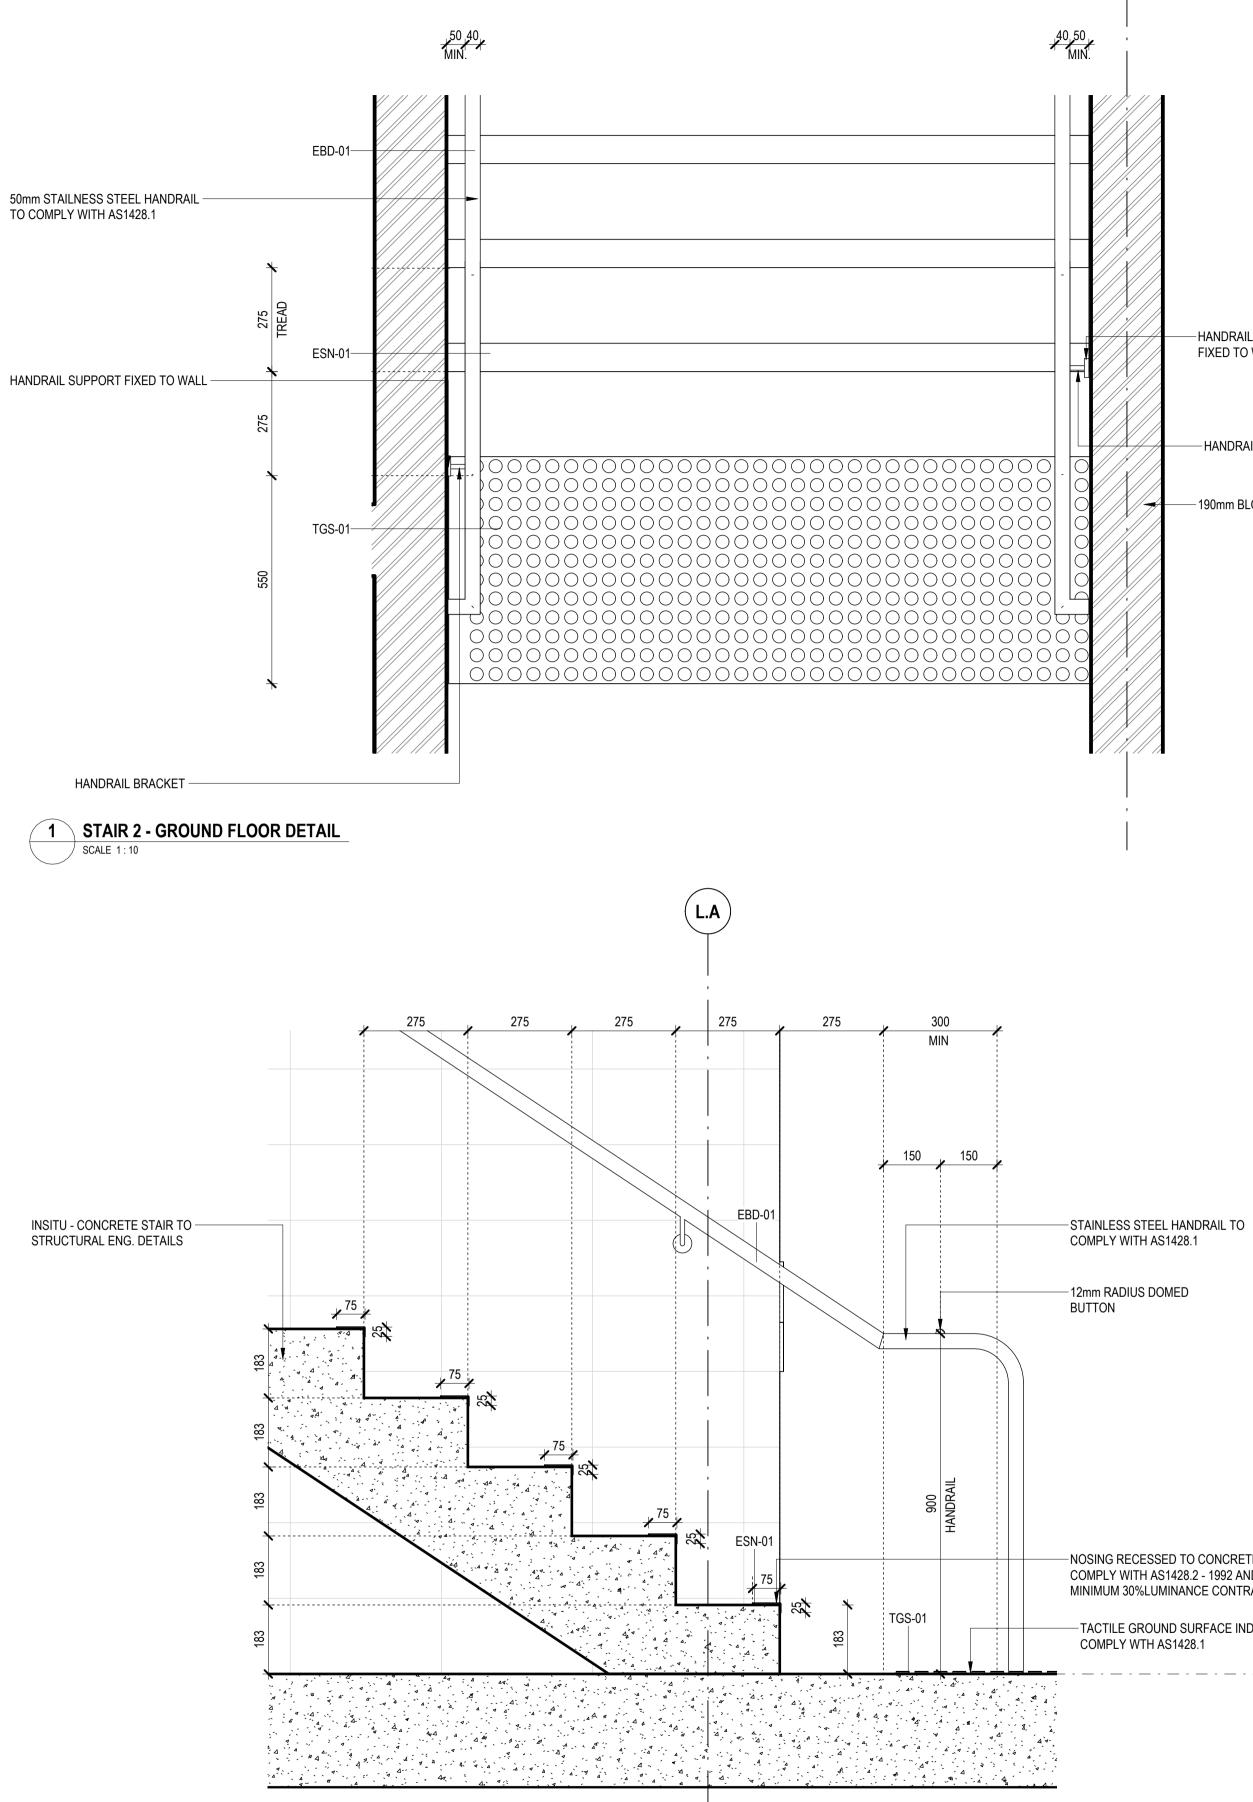
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41 -

SCALE 1:10

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**3** STAIR 2 - WALL MOUNTED HANDRAIL TERMINATION


NOSING RECESSED TO CONCRETE STAIR TO

COMPLY WITH AS1428.2 - 1992 AND TO ACHIEVE

MINIMUM 30%LUMINANCE CONTRAST TACTILE GROUND SURFACE INDICATORS TO

COMPLY WTH AS1428.1

GROUND FLOOR FFL 43.400

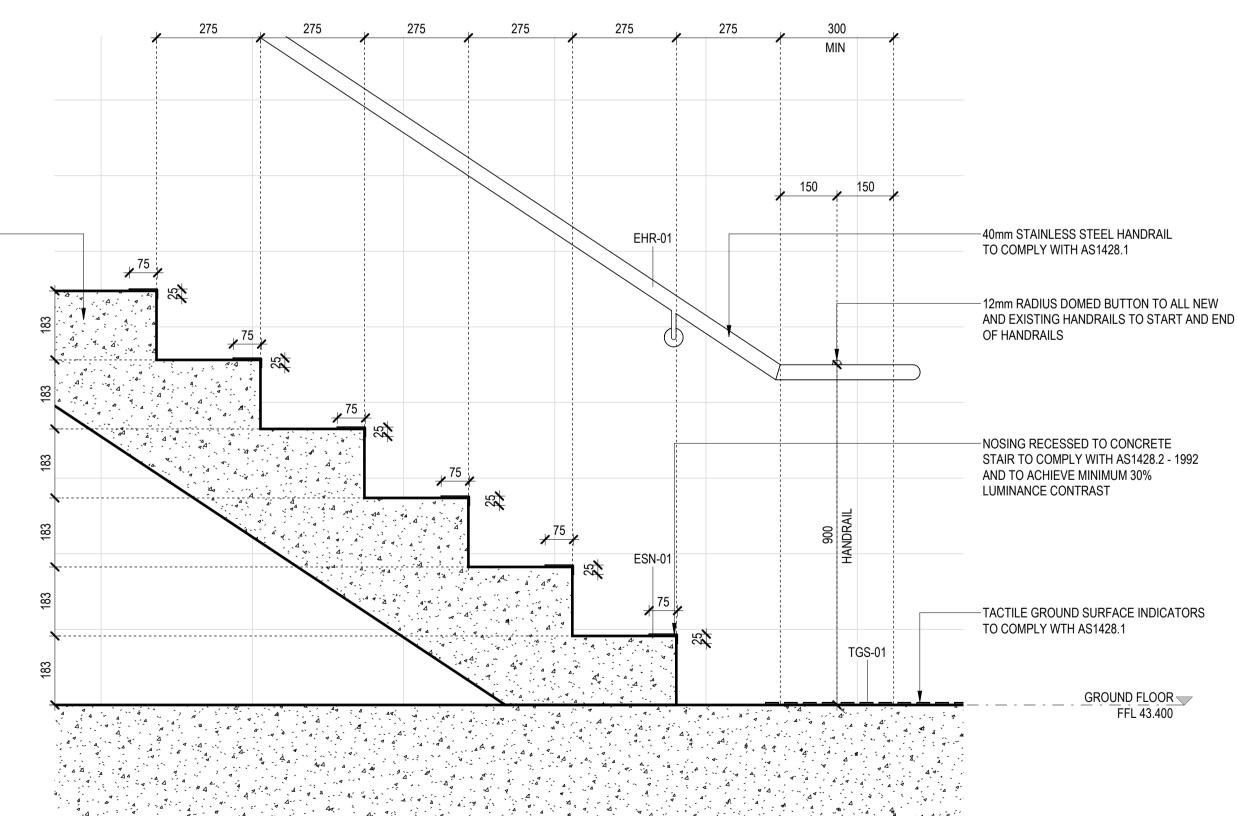

-HANDRAIL SUPPORT FIXED TO WALL

-HANDRAIL BRACKET

— 190mm BLOCK WALL

INSITU - CONCRETE STAIR TO


STRUCTURAL ENG. DETAILS

CHECKED BY Checker APPROVED BY Approver ┝┘┘┘┼╶╷╴┍╍╍┓╻╍╍╸ SCALE BAR - 1:100 STATUS CONCEPT DESIGN **SCALES** 1 : 10 @ A1

0 1 2 3 4 5

DRAWING NO. **BPR-DIS-AR-DRG-6104**  REVISION Α

TITLE **STAIR DETAILS - SHEET 1** 

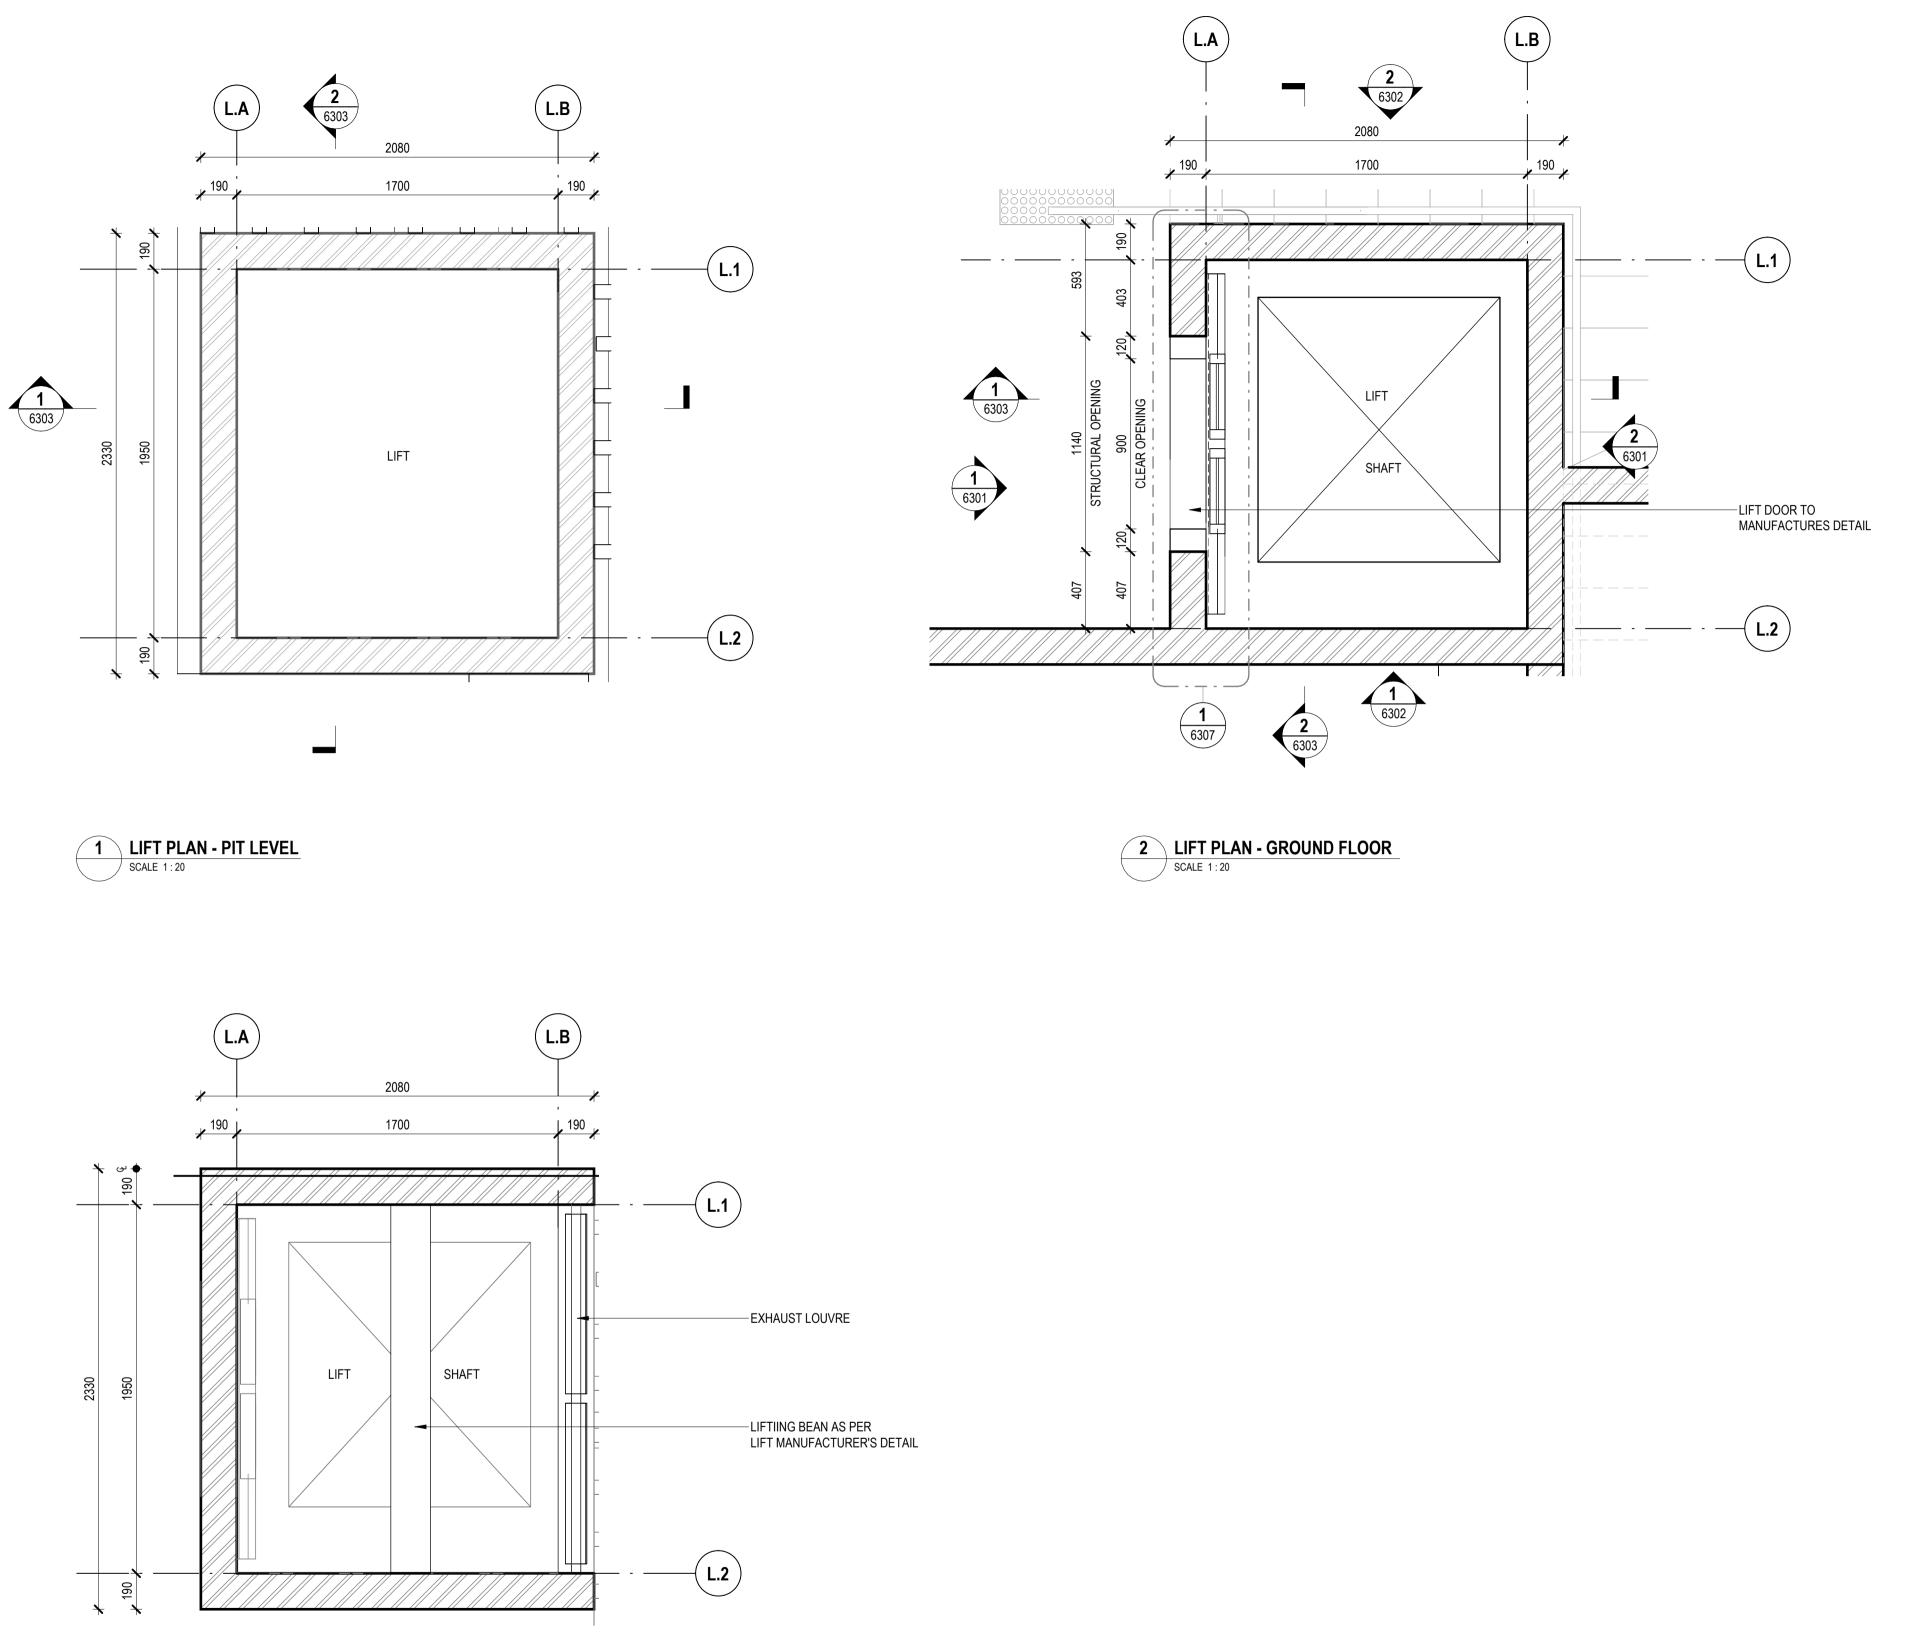

4 LIFT - REFLECTED CEILING PLAN SCALE 1:20

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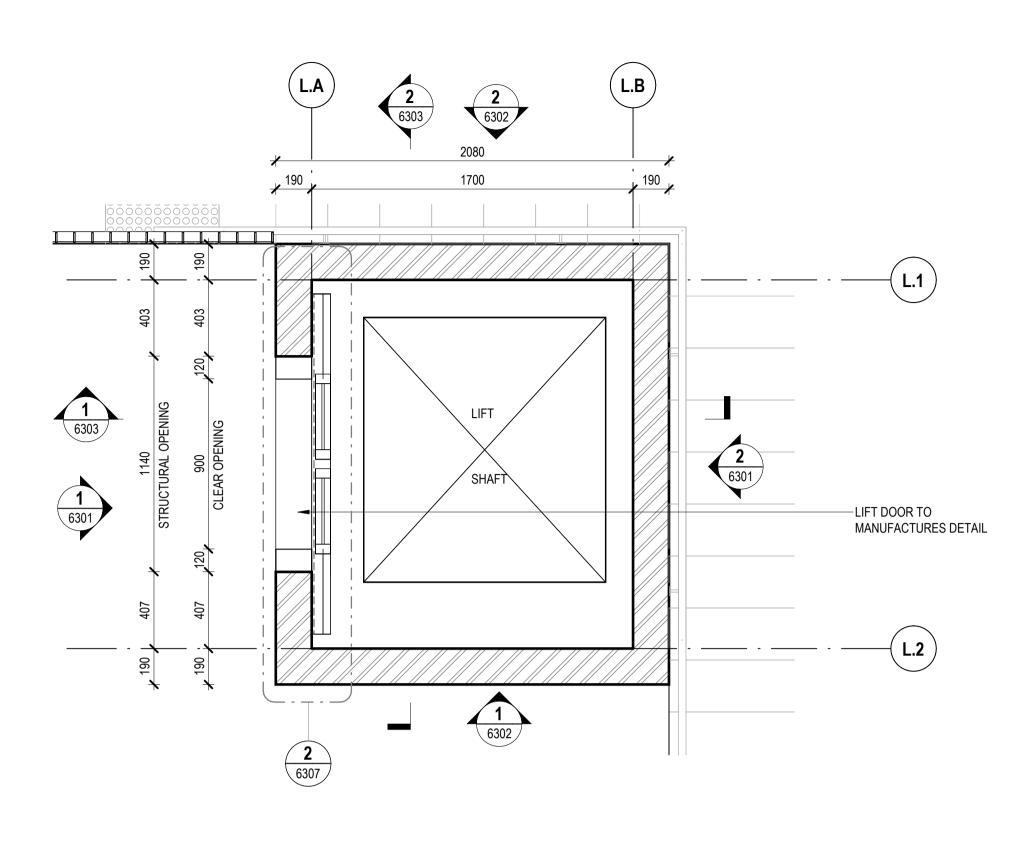
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3 LIFT PLAN - LEVEL ONE SCALE 1:20

CLIENT



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STATUS CONCEPT DESIGN

SCALES 1 : 20 @ A1

TITLE


DRAWING NO.

LIFT - DETAIL PLAN

**BPR-DIS-AR-DRG-6300** 

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0 1 2 3 4 5 SCALE BAR - 1:100

> DRAWING NO. **BPR-DIS-AR-DRG-6301**

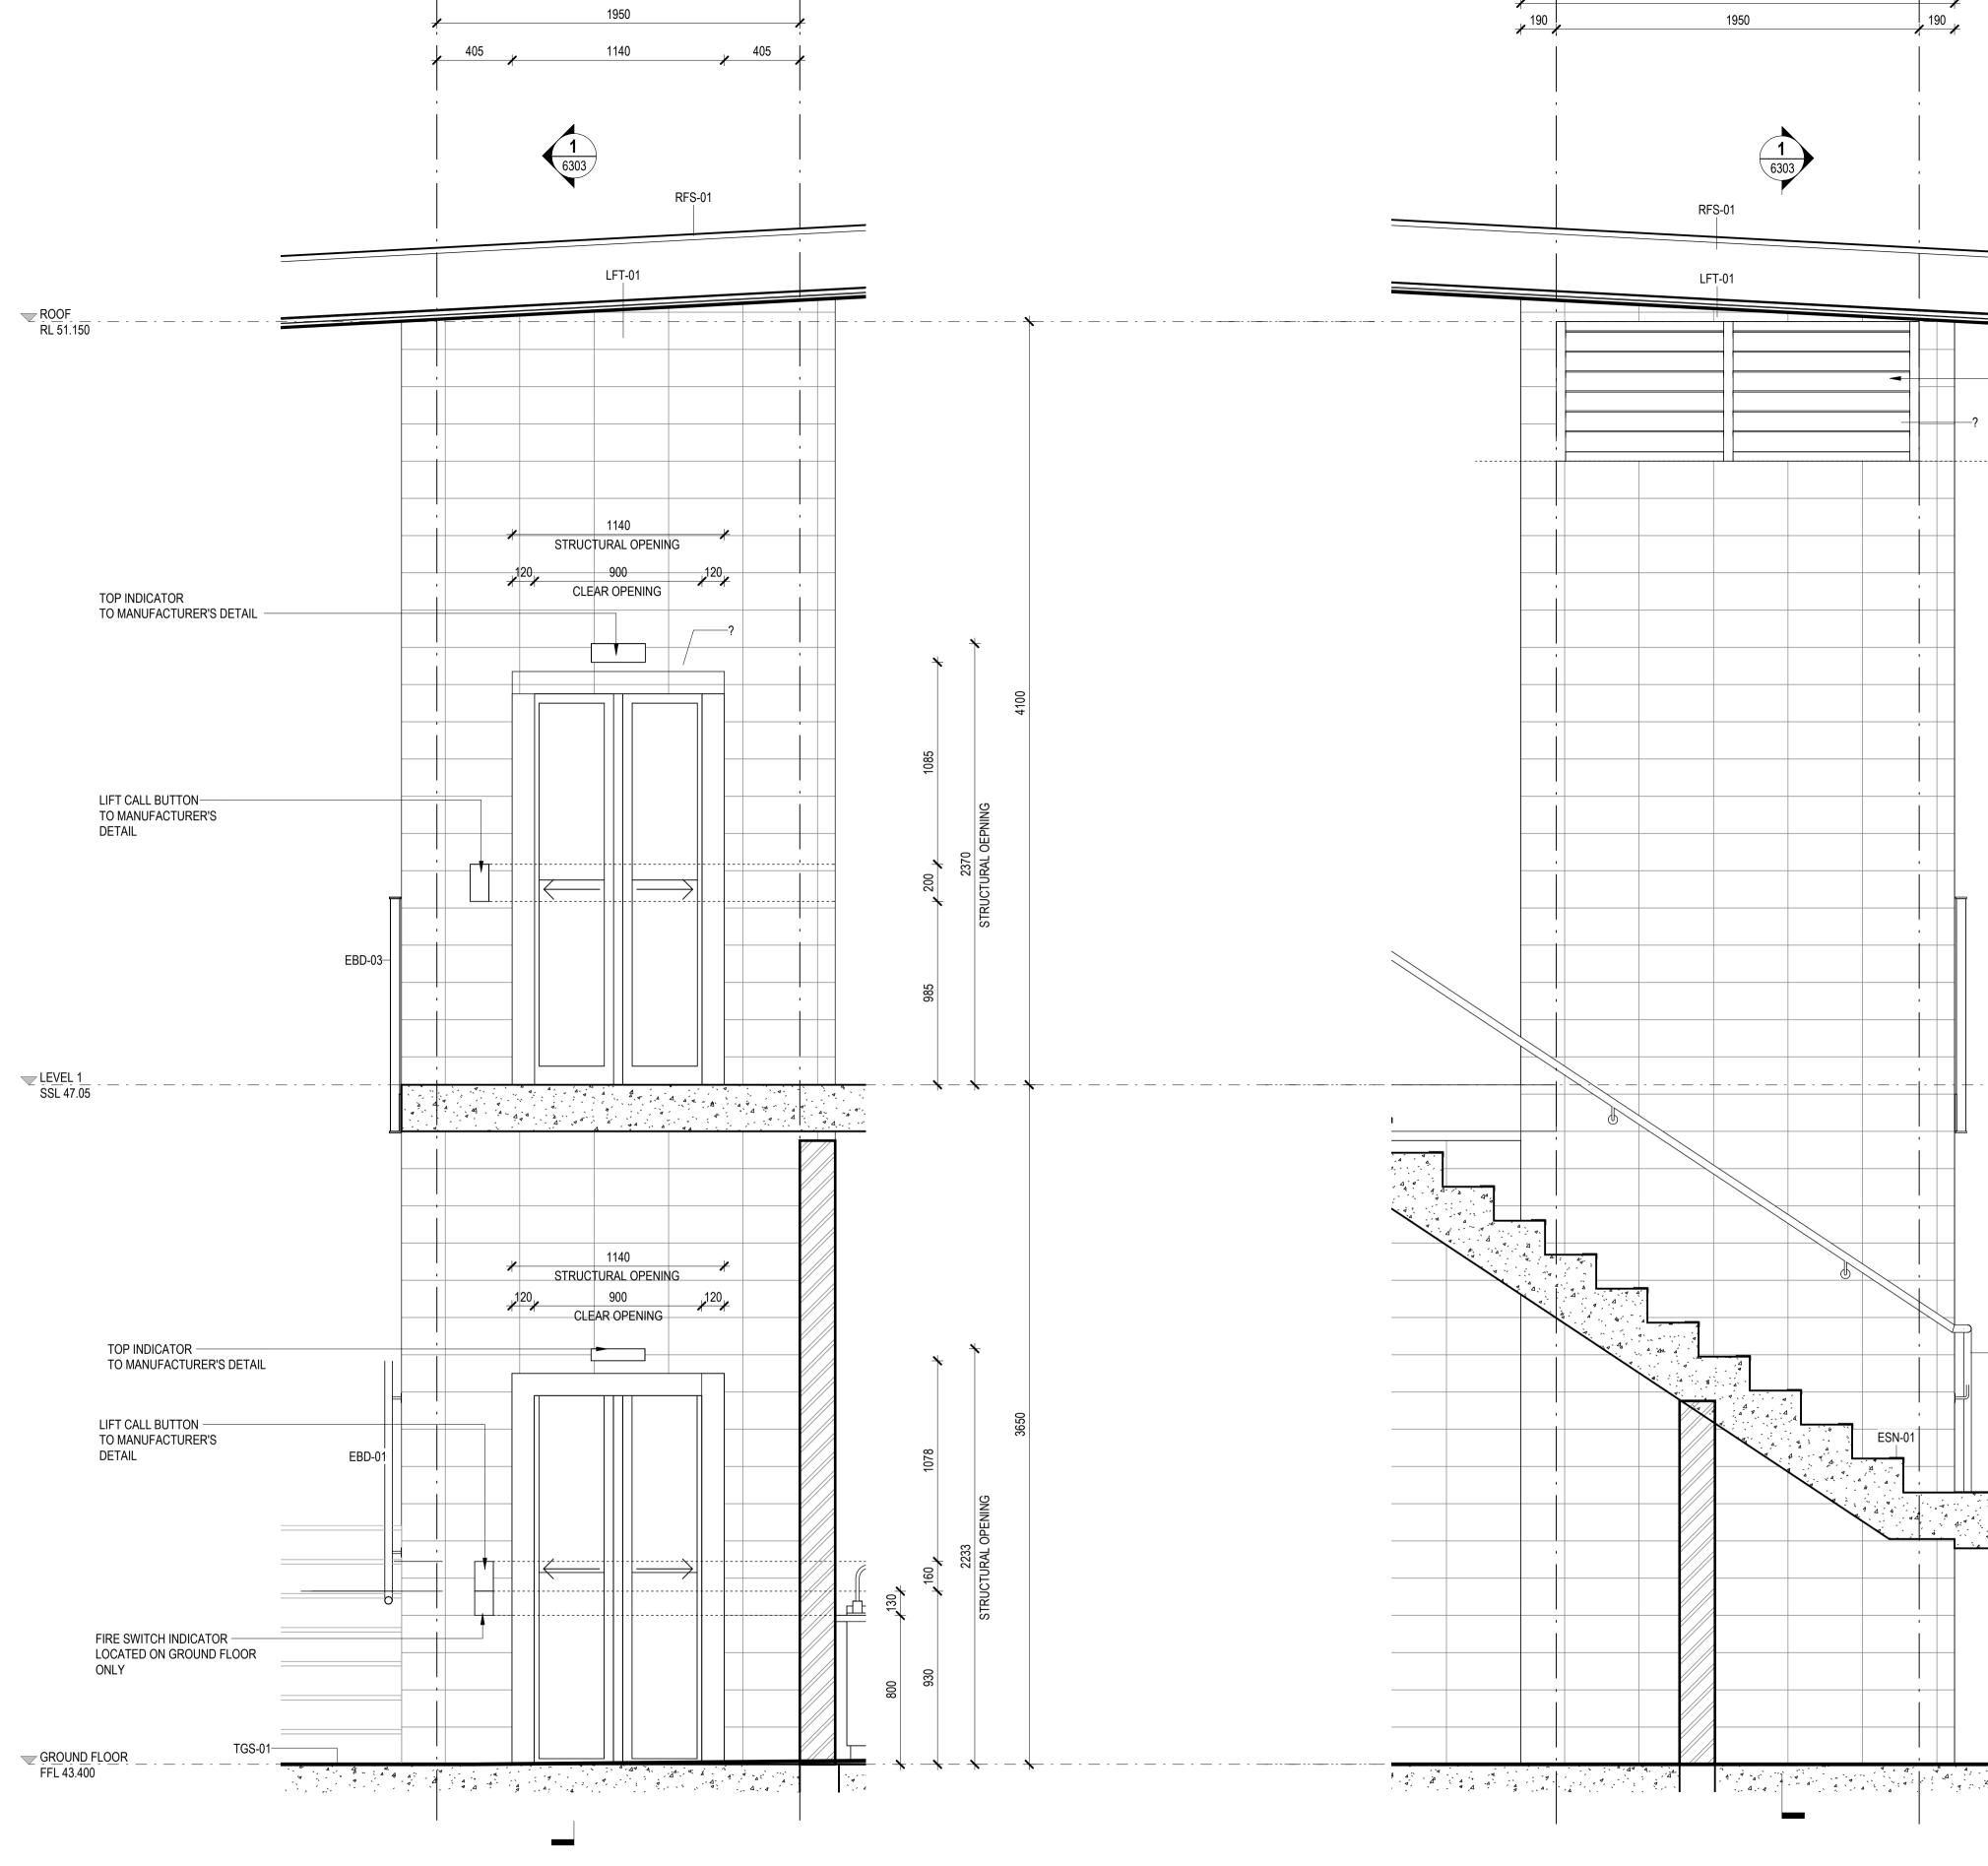REVISION A

TITLE LIFT - ELEVATION SHEET 1

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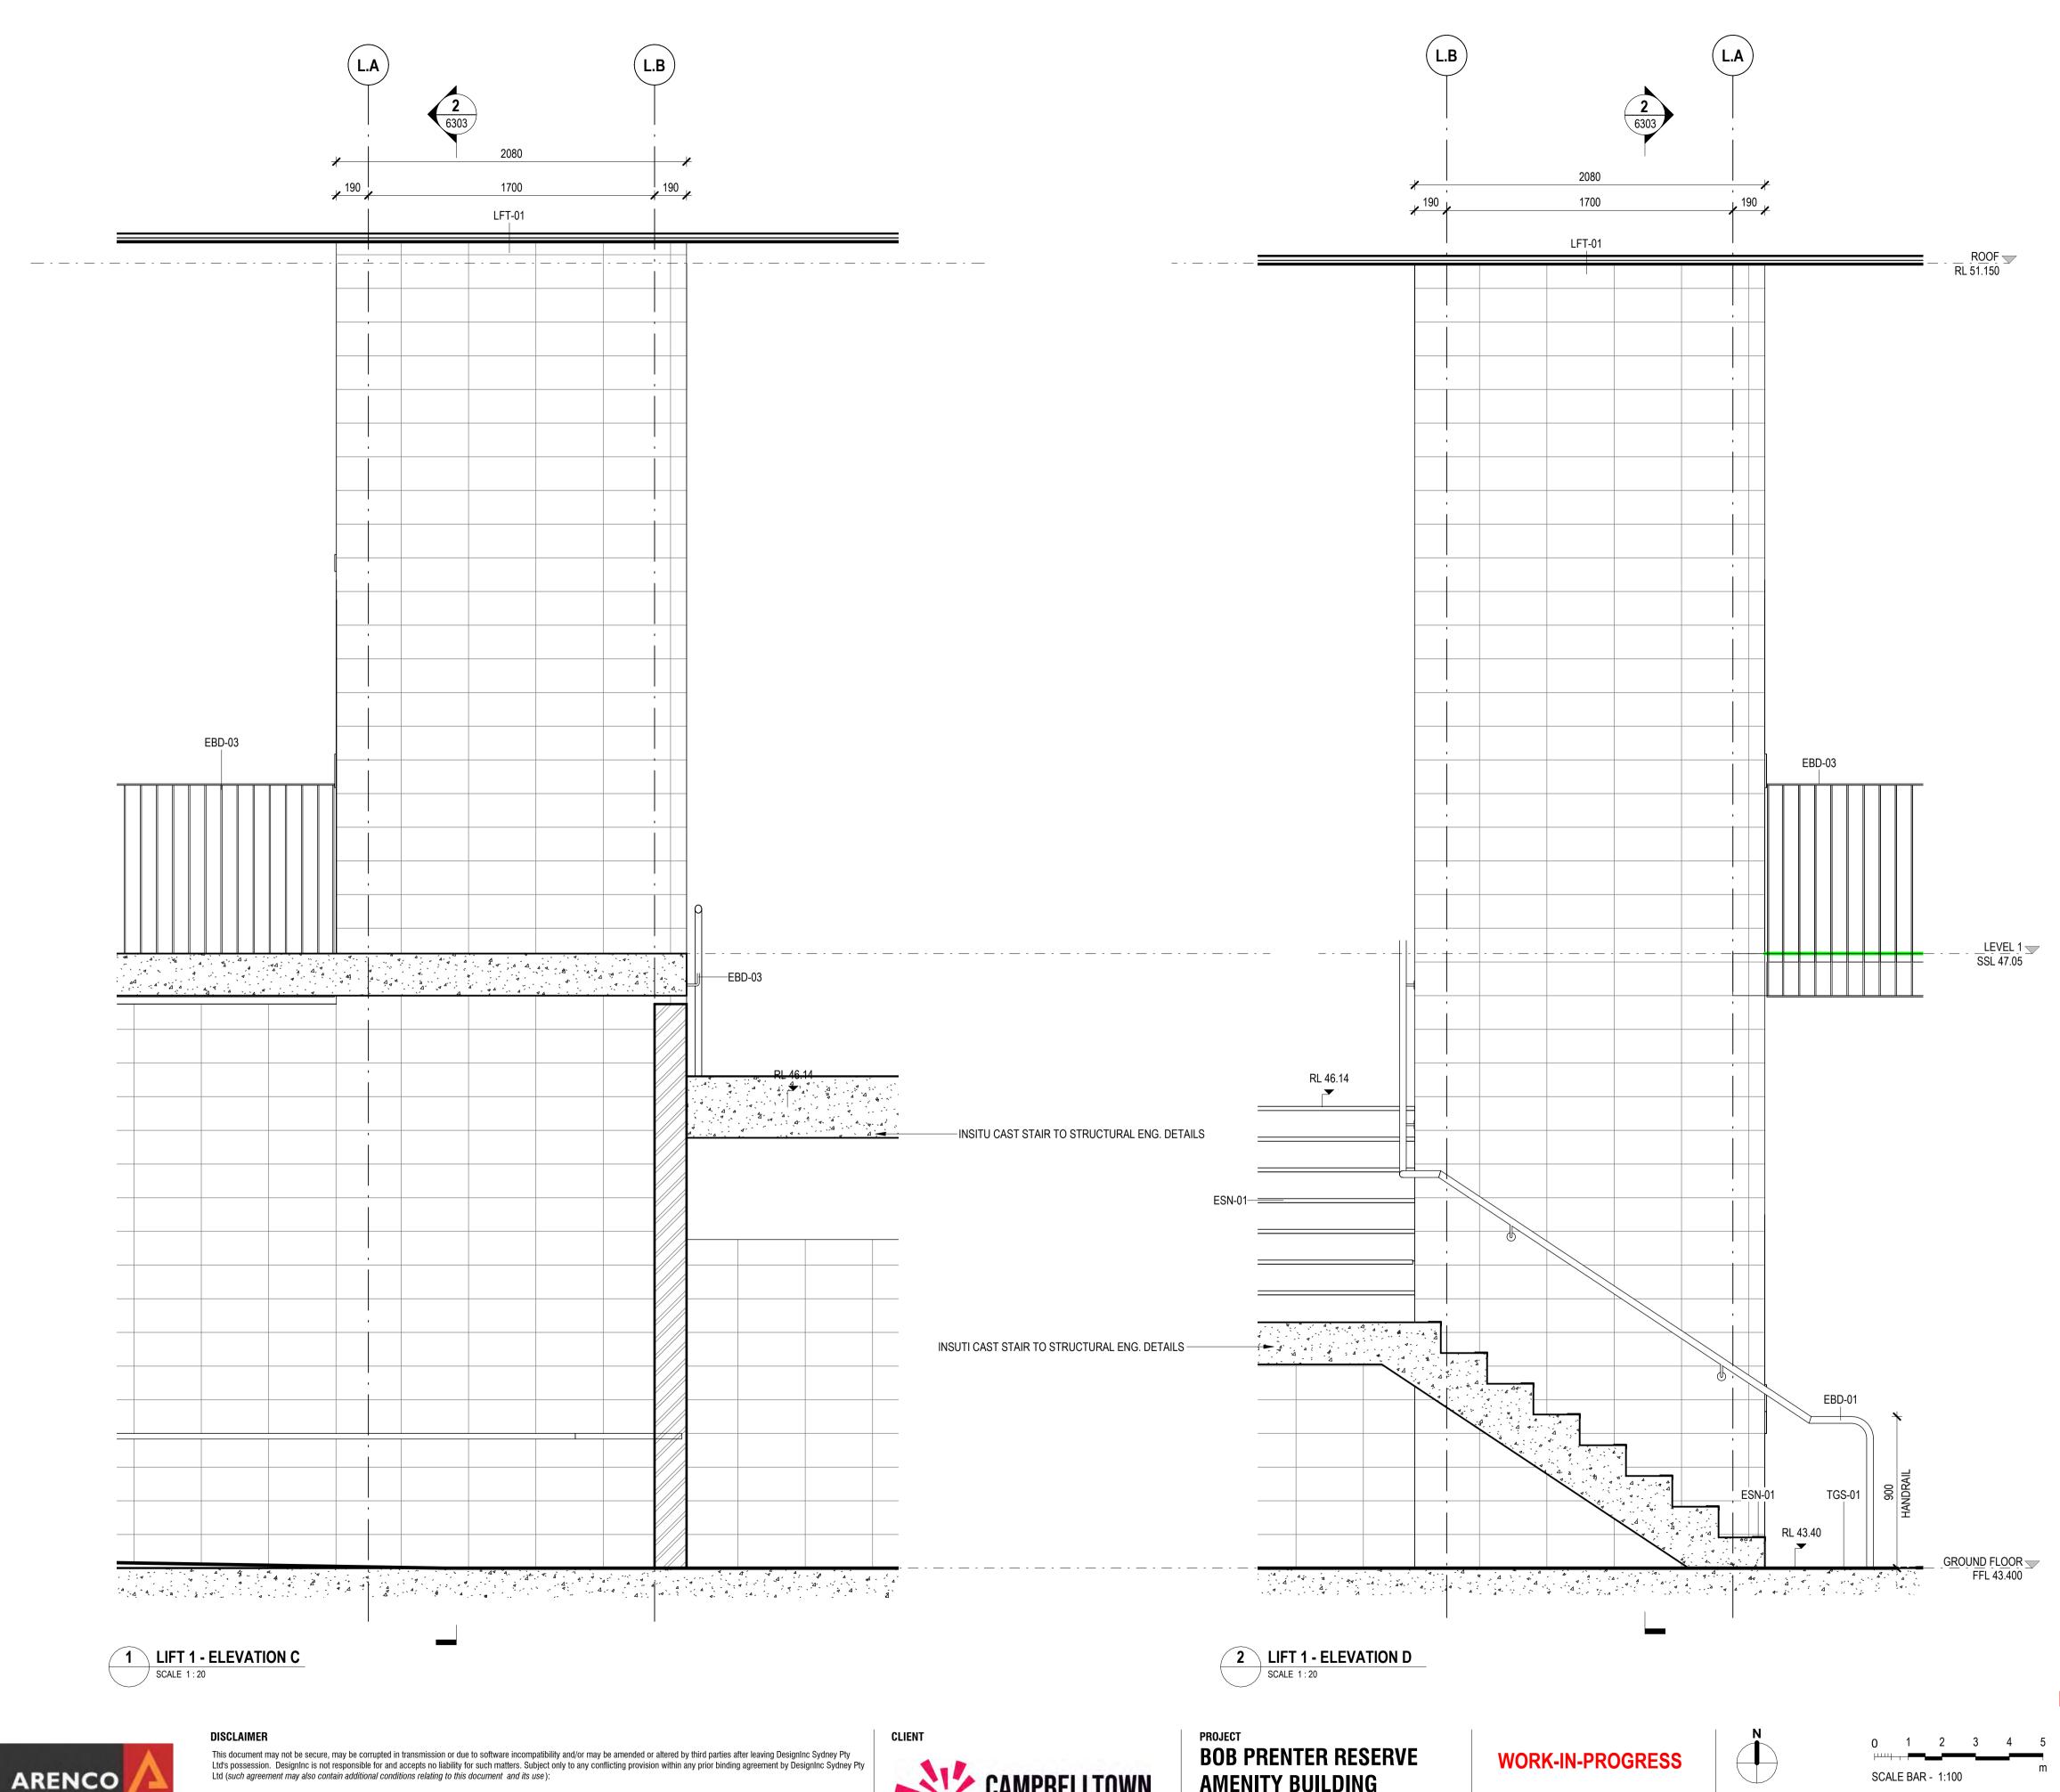
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RL 44.86 A 44 4- A A 44 

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LEVEL 1 SSL 47.05 

-LIFT EXHAUST STAGE 2 LOUVRES







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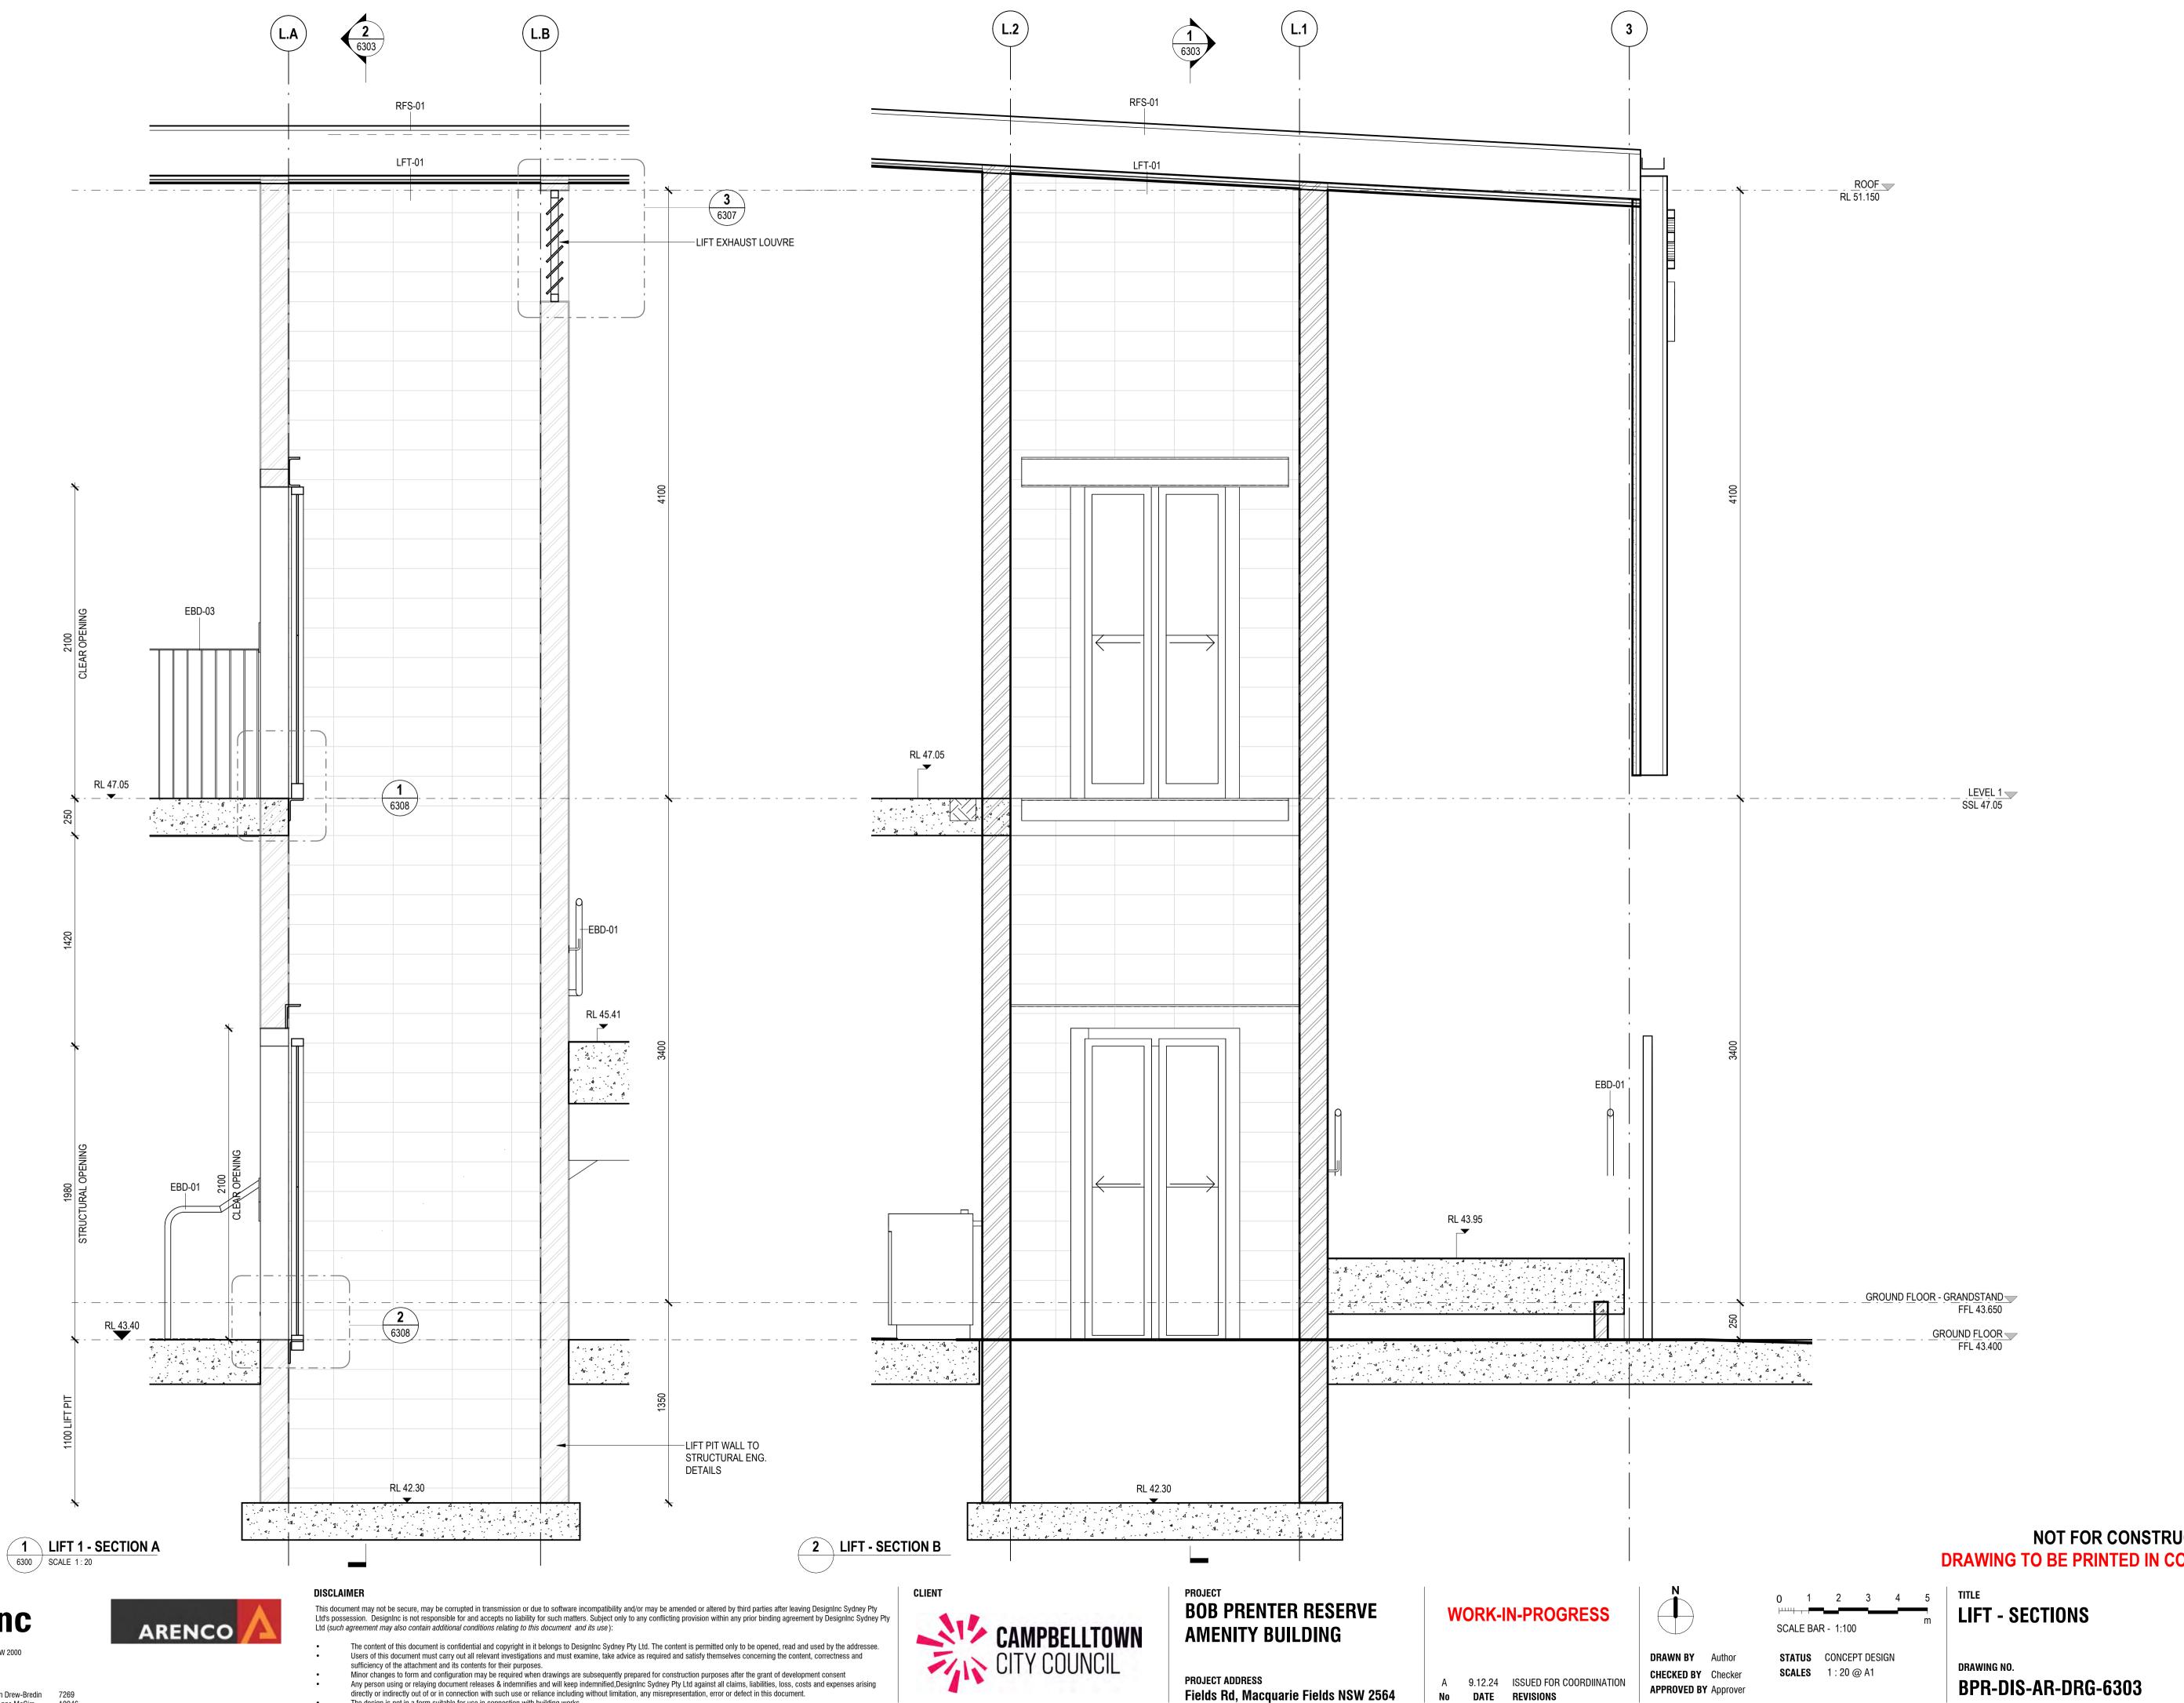
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DRAWING NO. **BPR-DIS-AR-DRG-6302**  REVISION A

TITLE LIFT - ELEVATIONS SHEET 2




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SCALES 1 : 5 @ A1

TITLE LIFT DETAILS SHEET 1

**BPR-DIS-AR-DRG-6307** 


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**3** LIFT ROOF - SECTION DETAIL

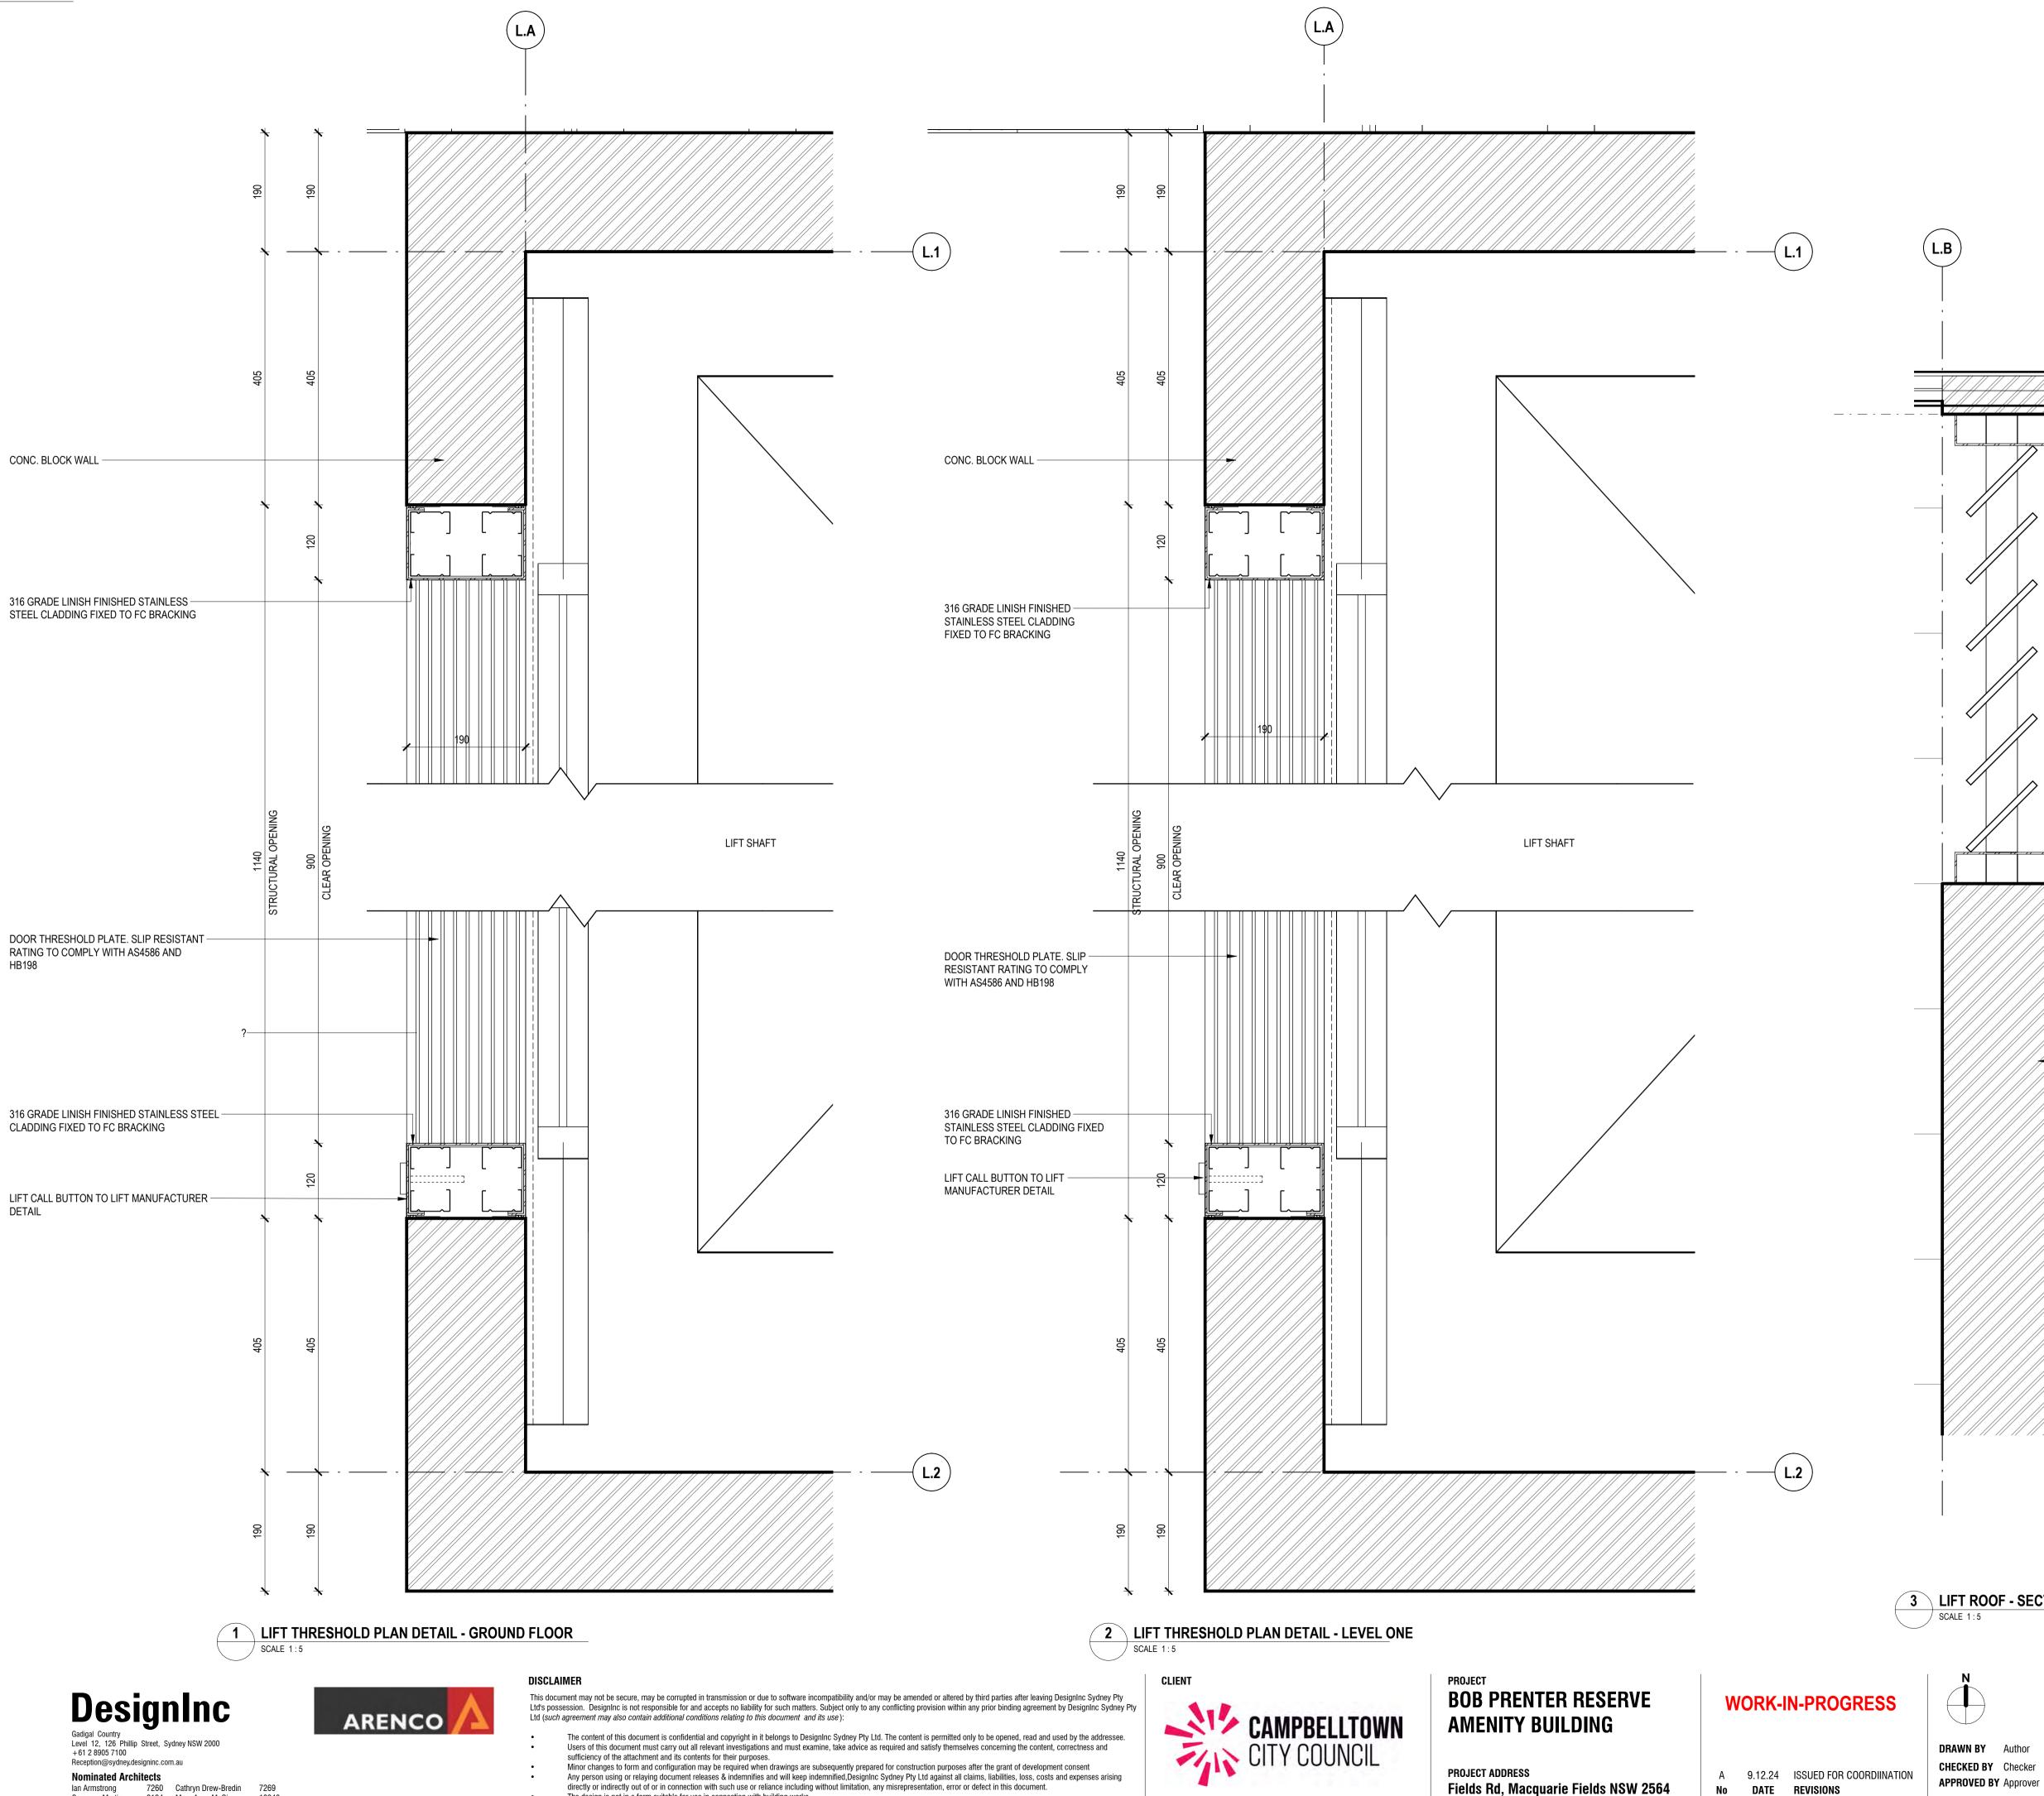RL 51.150 LIFT LOUVRE TO MANUFACTURER'S DETAIL -CONC. BLOCK WALL

> REVISION Α





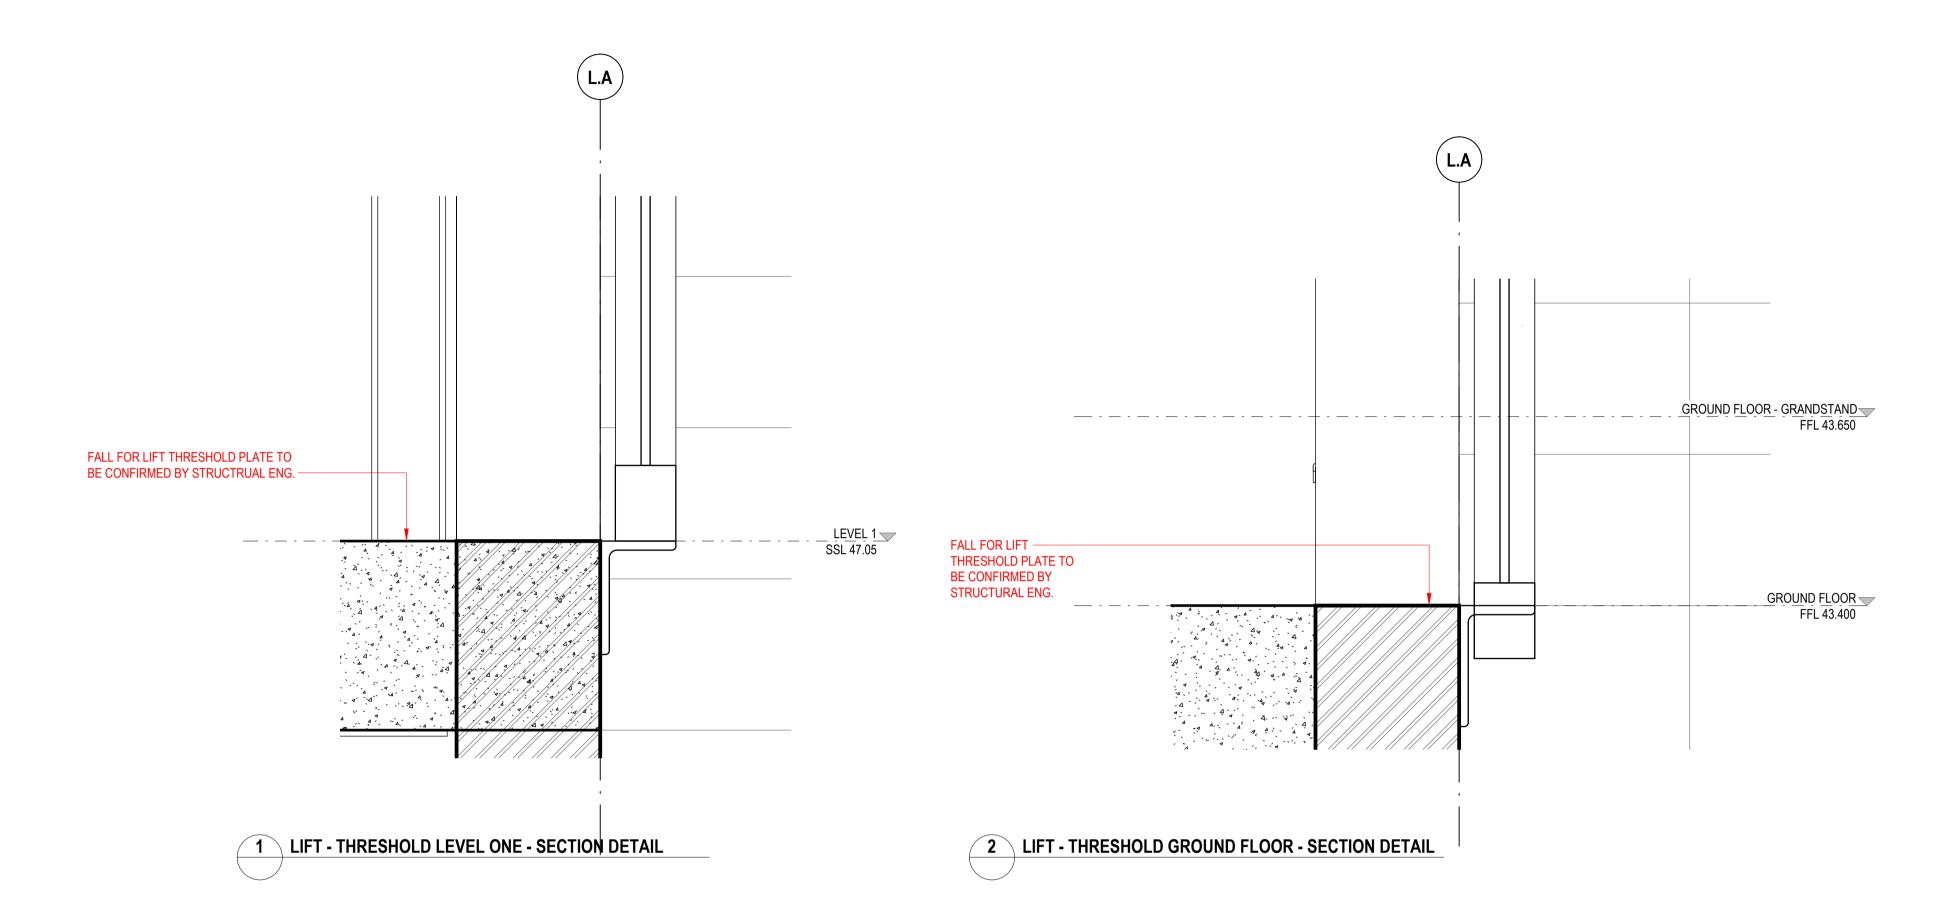

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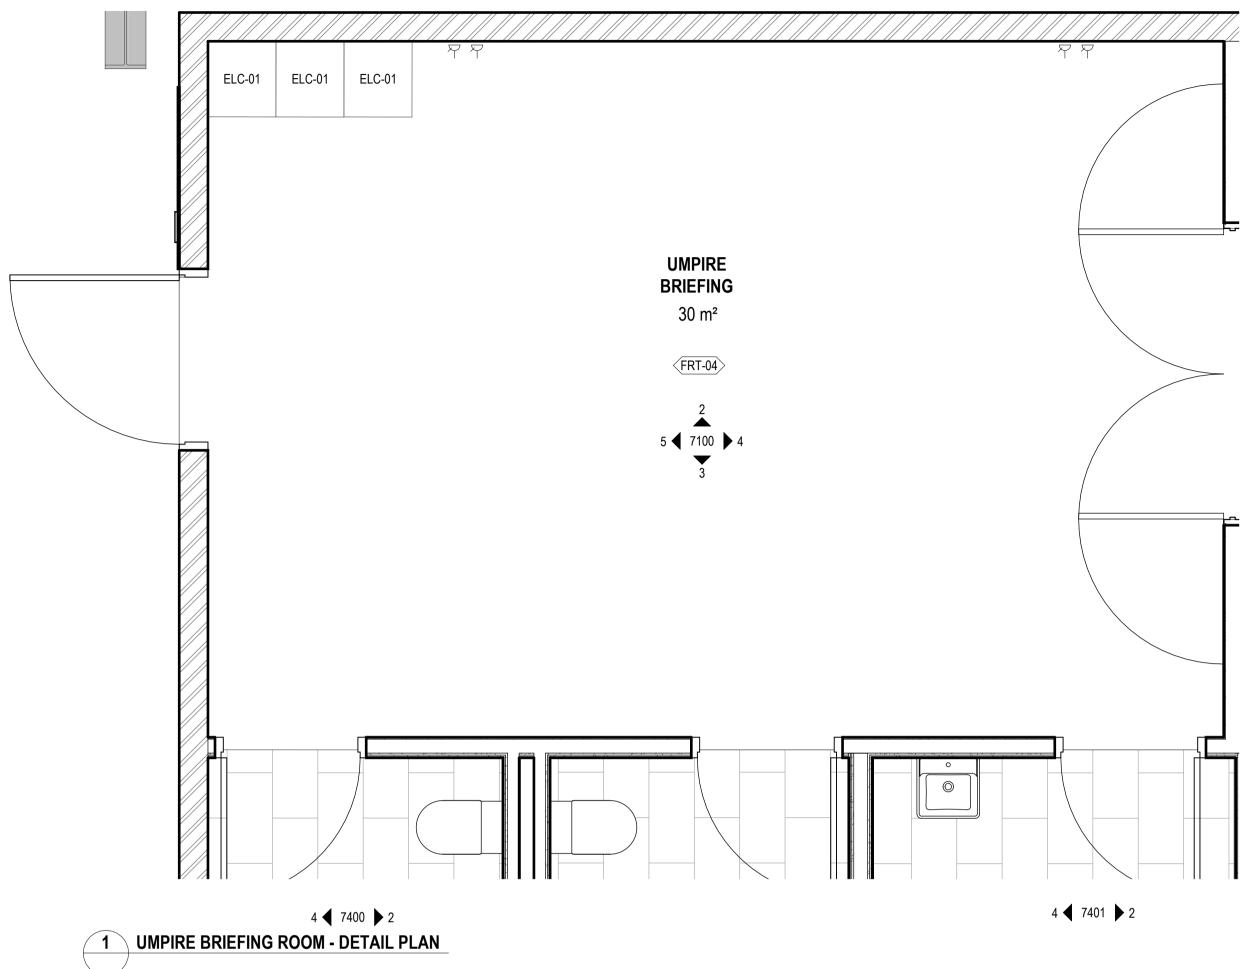
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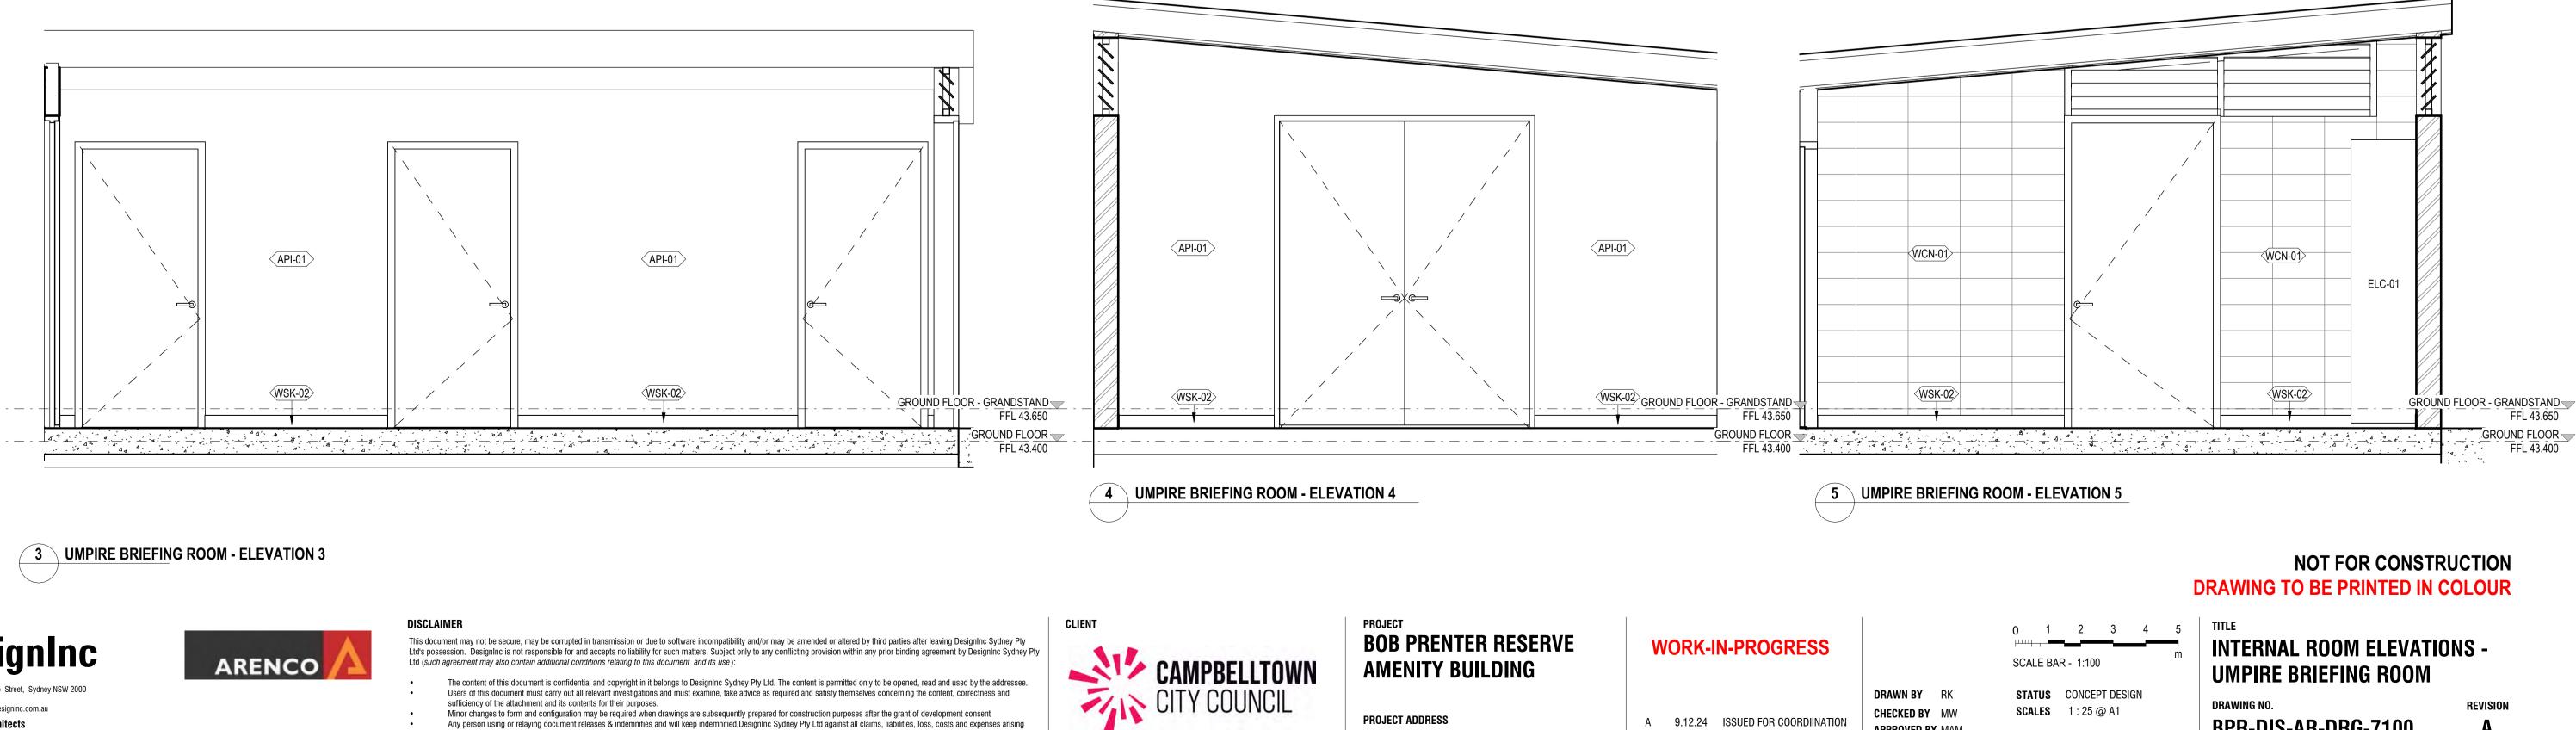
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REVISION A

TITLE LIFT DETAILS SHEET 2





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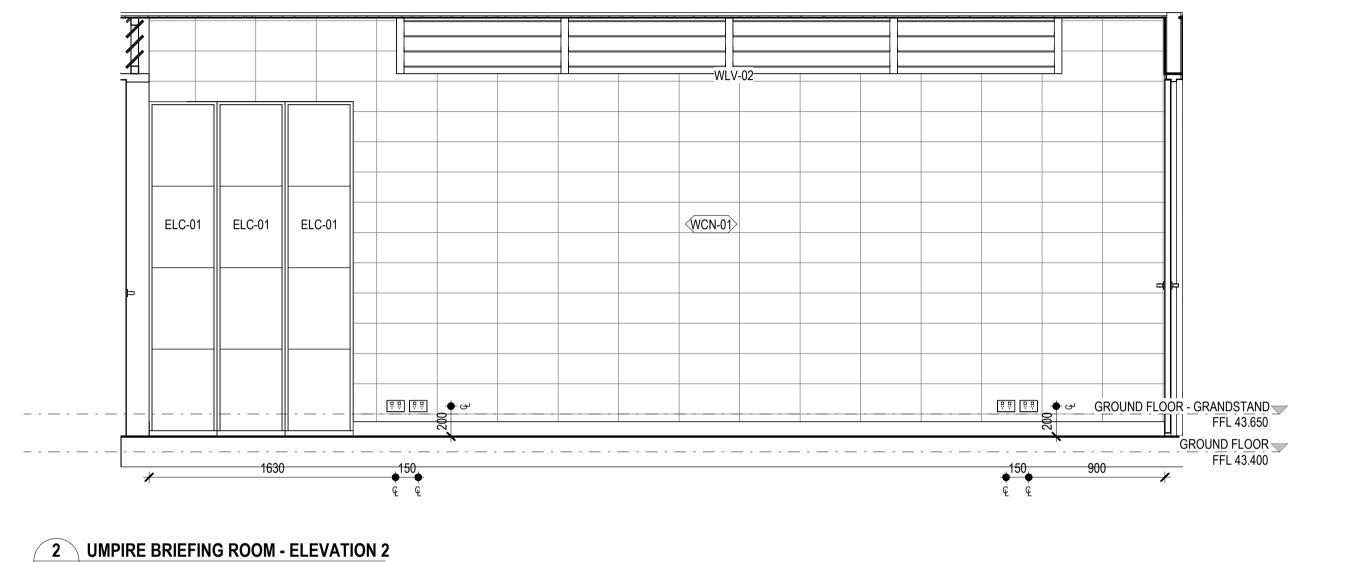


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SCALES 1 : 25 @ A1 **BPR-DIS-AR-DRG-7100** 


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#### PROJECT **BOB PRENTER RESERVE AMENITY BUILDING**

PROJECT ADDRESS Fields Rd, Macquarie Fields NSW 2564

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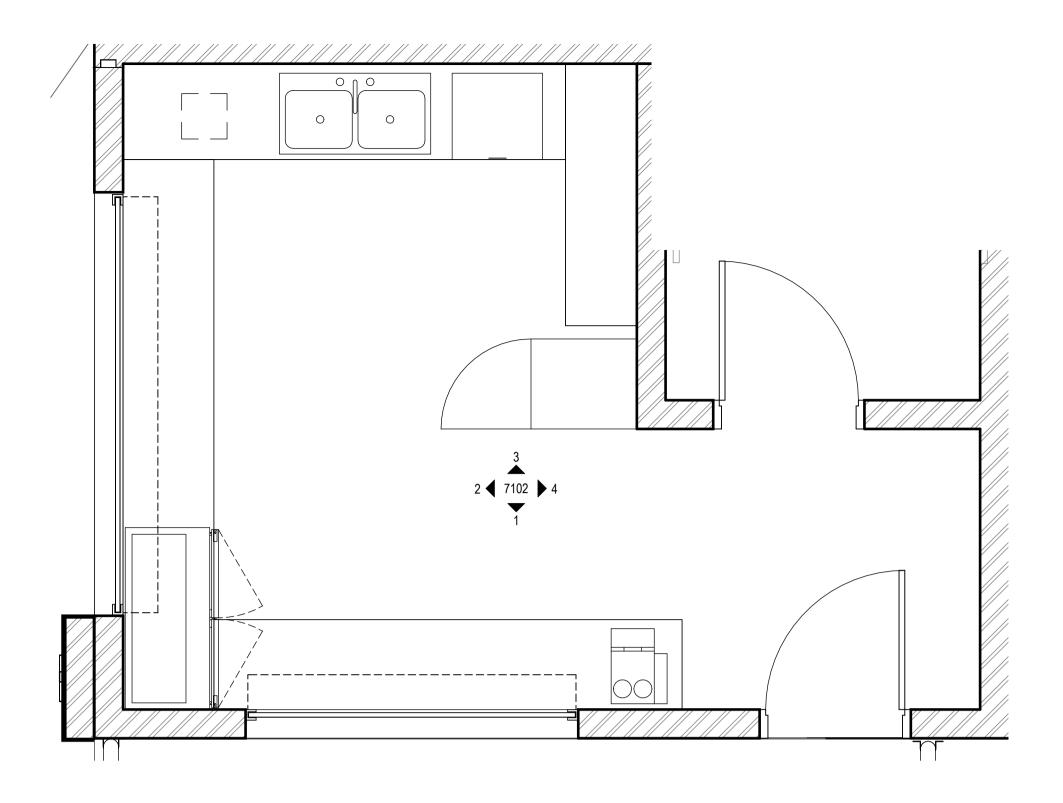
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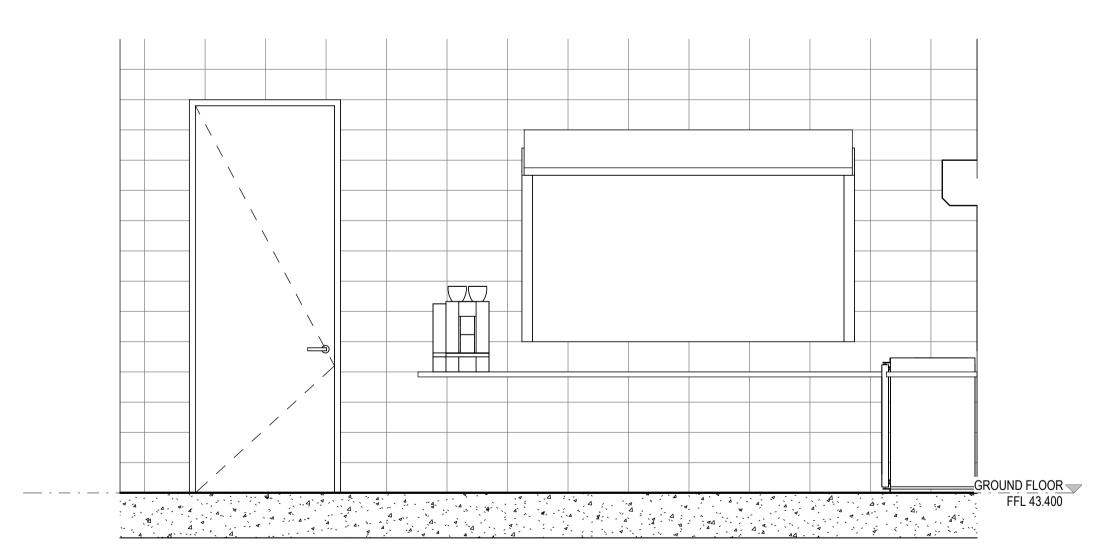
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TITLE **INTERNAL ROOM ELEVATIONS -**GYM DRAWING NO. REVISION **BPR-DIS-AR-DRG-7101** Α





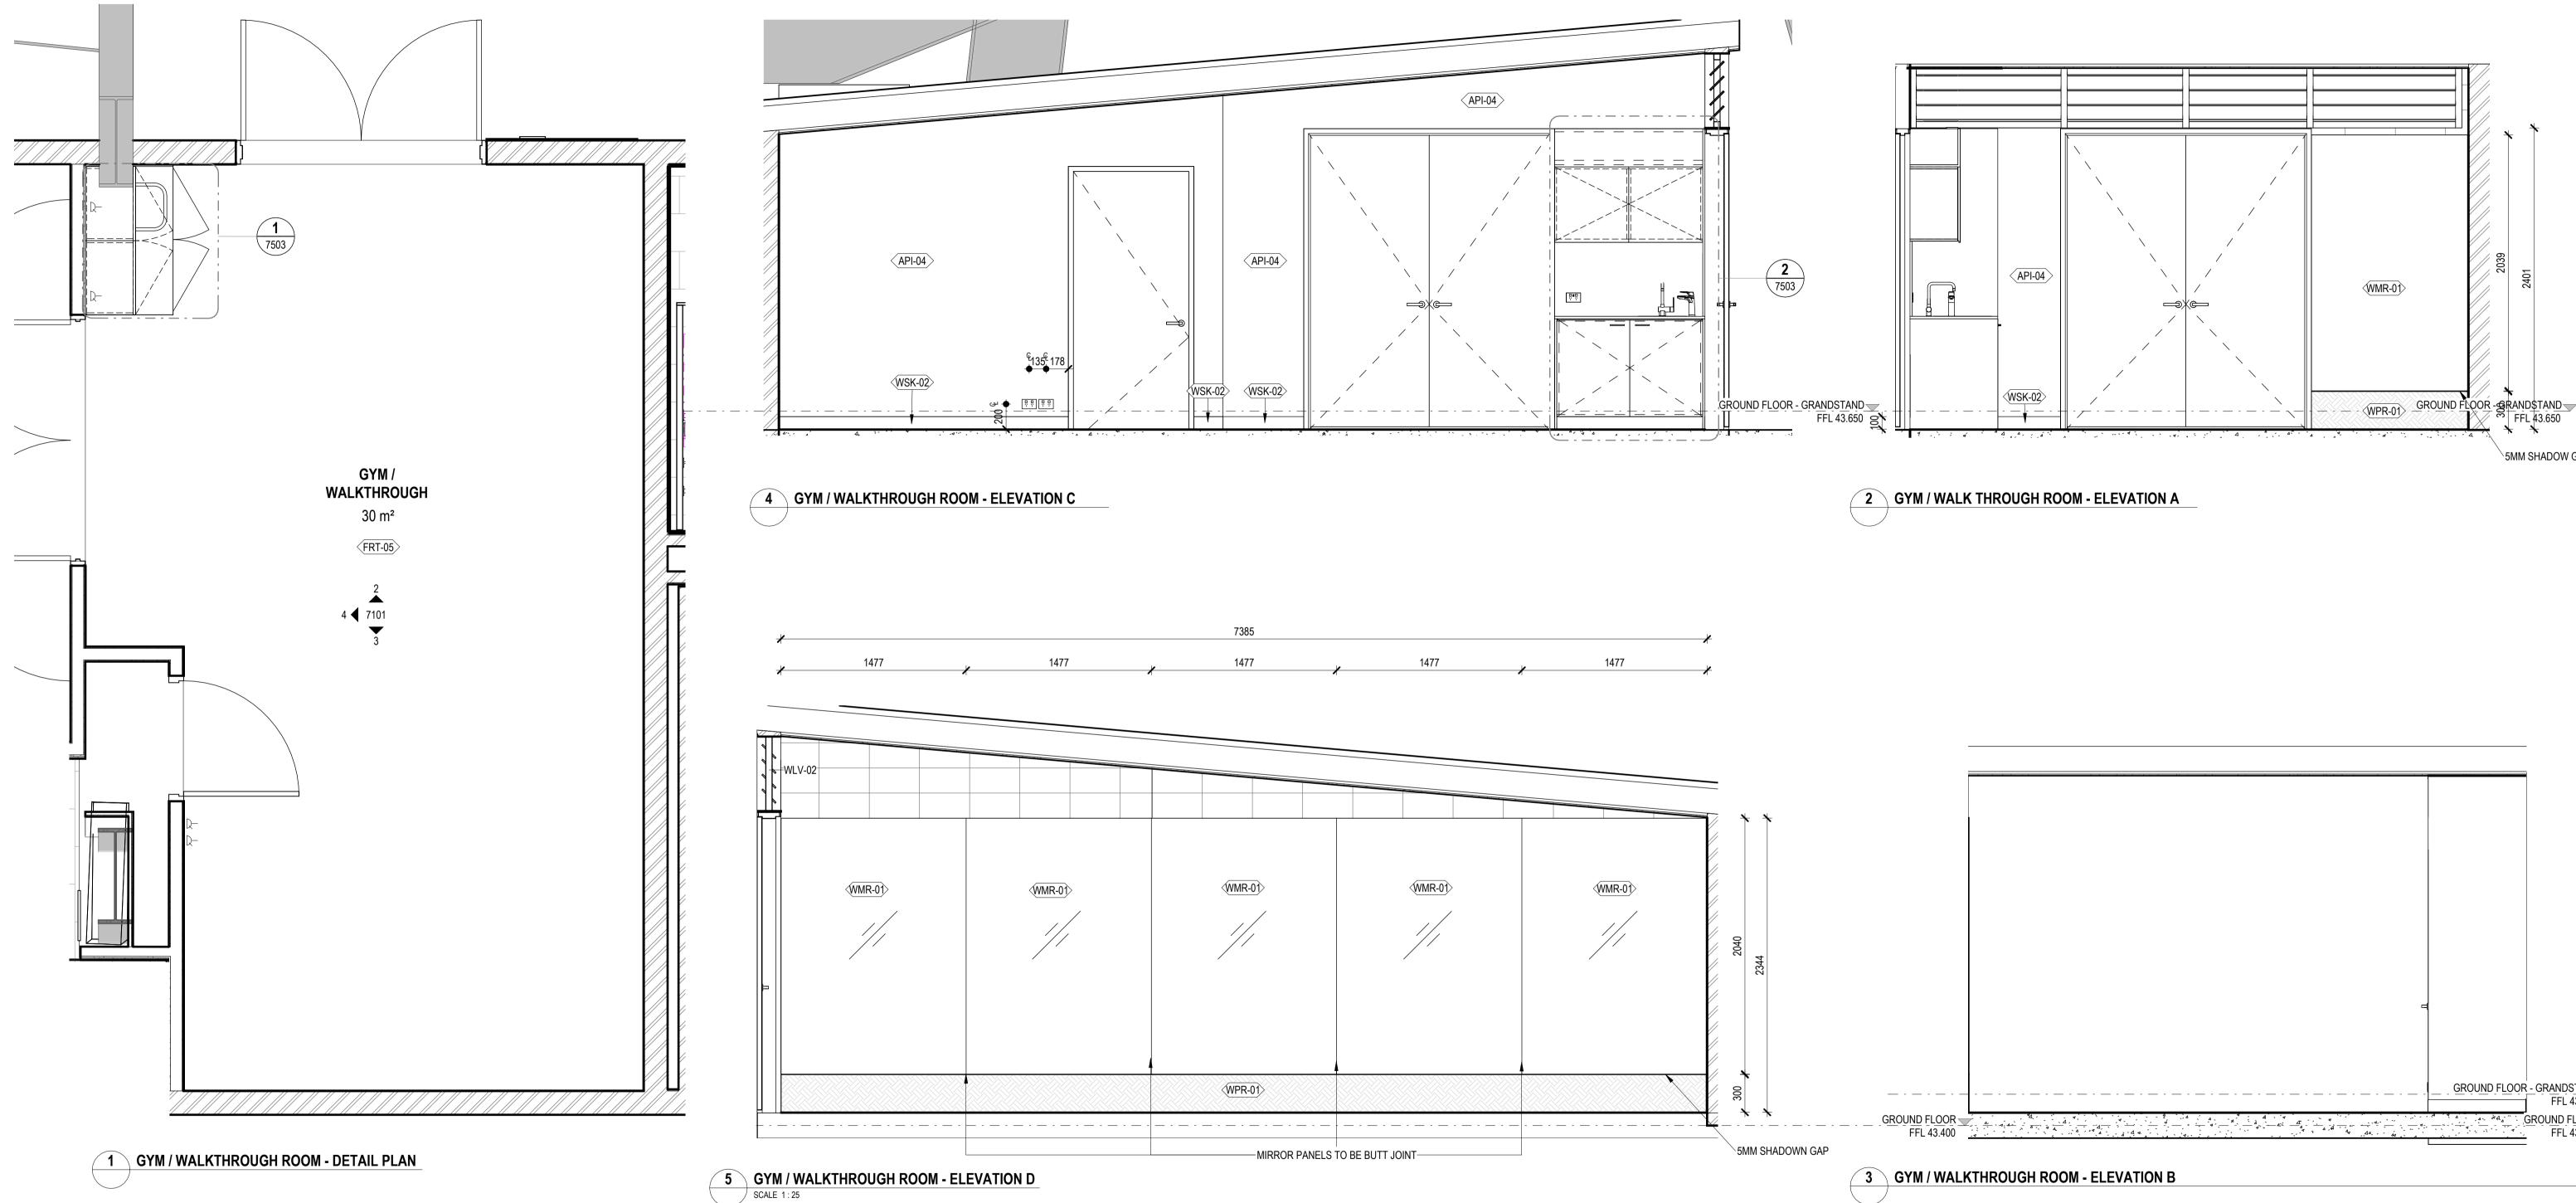



**CANTEEN - ELEVATION 2** SCALE 1:25

# **Designation** Gadigal Country Level 12, 126 Phillip Street, Sydney NSW 2000 +61 2 8905 7100 Reception@sydney.designinc.com.au

Ian Armstrong 7260 Cathryn Drew-Bredin 7269

Cameron Martin 9194 Mary Anne McGirr 10946

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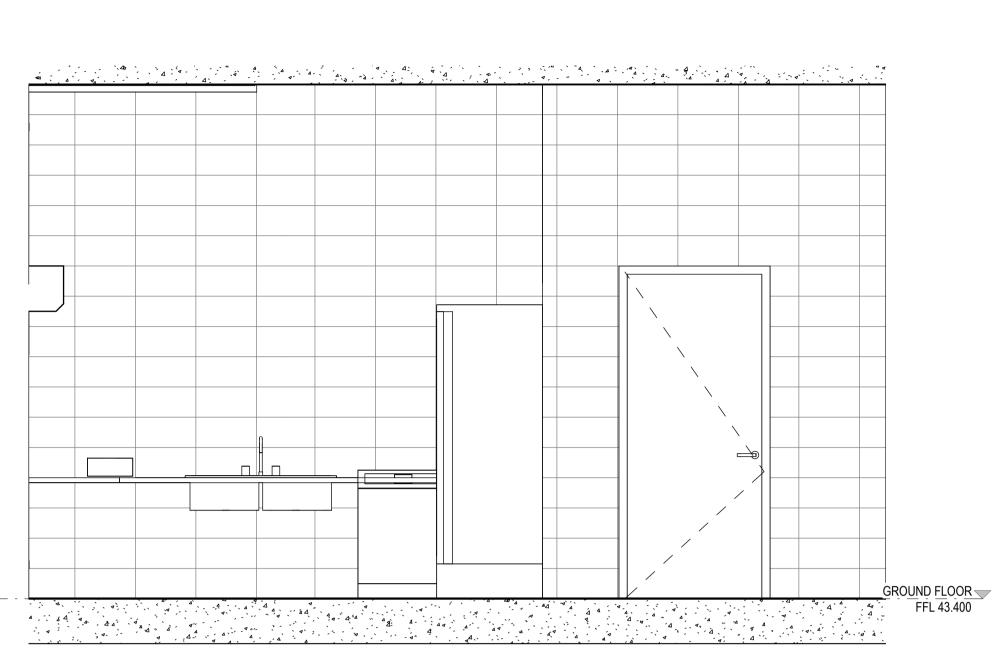
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\_ - \_ - \_ FFL 43.400 2 CANTEEN - ELEVATION 3 SCALE 1:25







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### 4 CANTEEN - ELEVATION 1 SCALE 1:25


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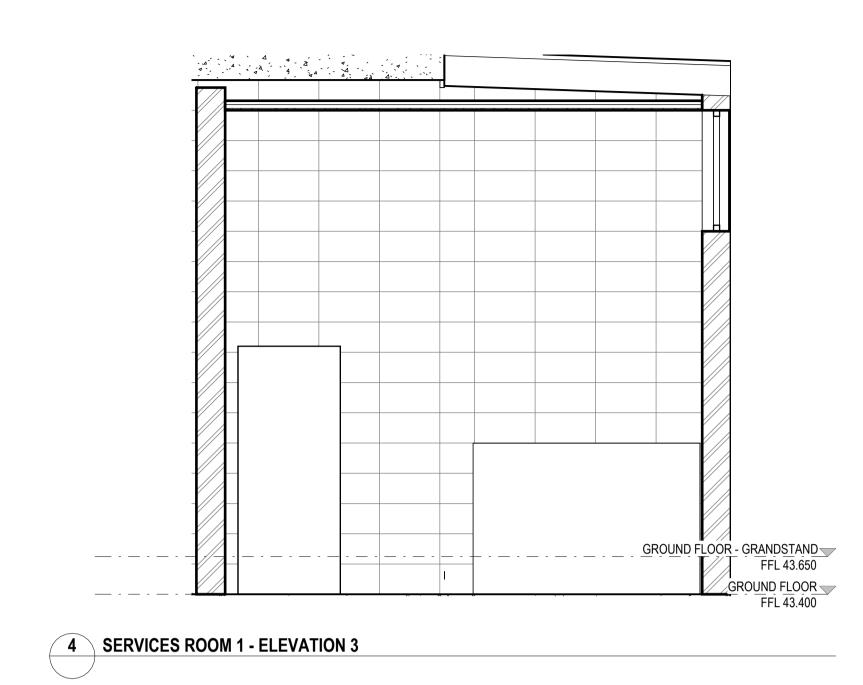
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SCALES 1 : 25 @ A1

SCALE BAR - 1:100

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GROUND FLOOR - GRANDSTAND FFL 43.650 \_\_\_\_\_ - --- -. \_ . + . \_ . + . \_ . GROUND FLOOR FFL 43.400

#### 2 SERVICES ROOM - ELEVATION 1

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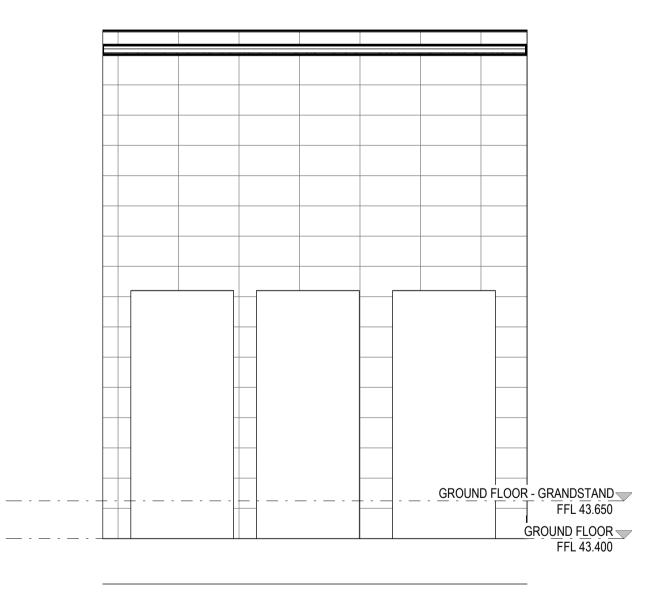


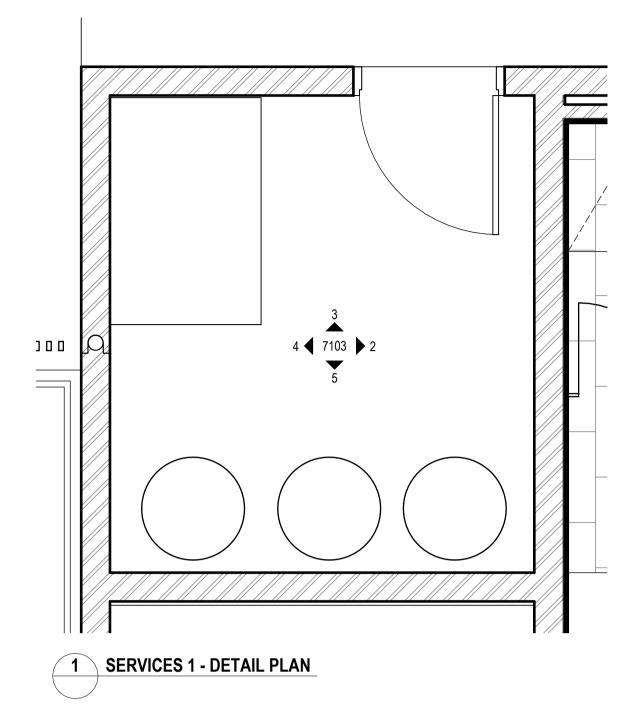

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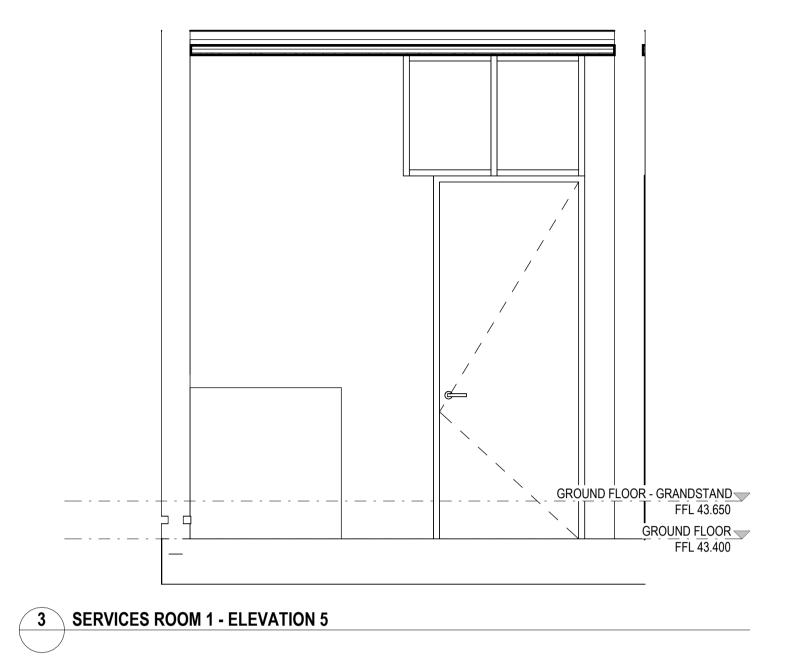


**5** SERVICES ROOM - ELEVATION 4



#### PROJECT **BOB PRENTER RESERVE AMENITY BUILDING**

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#### WORK-IN-PROGRESS




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TITLE **INTERNAL ROOM ELEVATIONS -SERVICES ROOM 1** DRAWING NO. REVISION **BPR-DIS-AR-DRG-7103** A

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STATUS CONCEPT DESIGN SCALES 1 : 25 @ A1






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**5** SERVICES ROOM 2 - ELEVATION 4

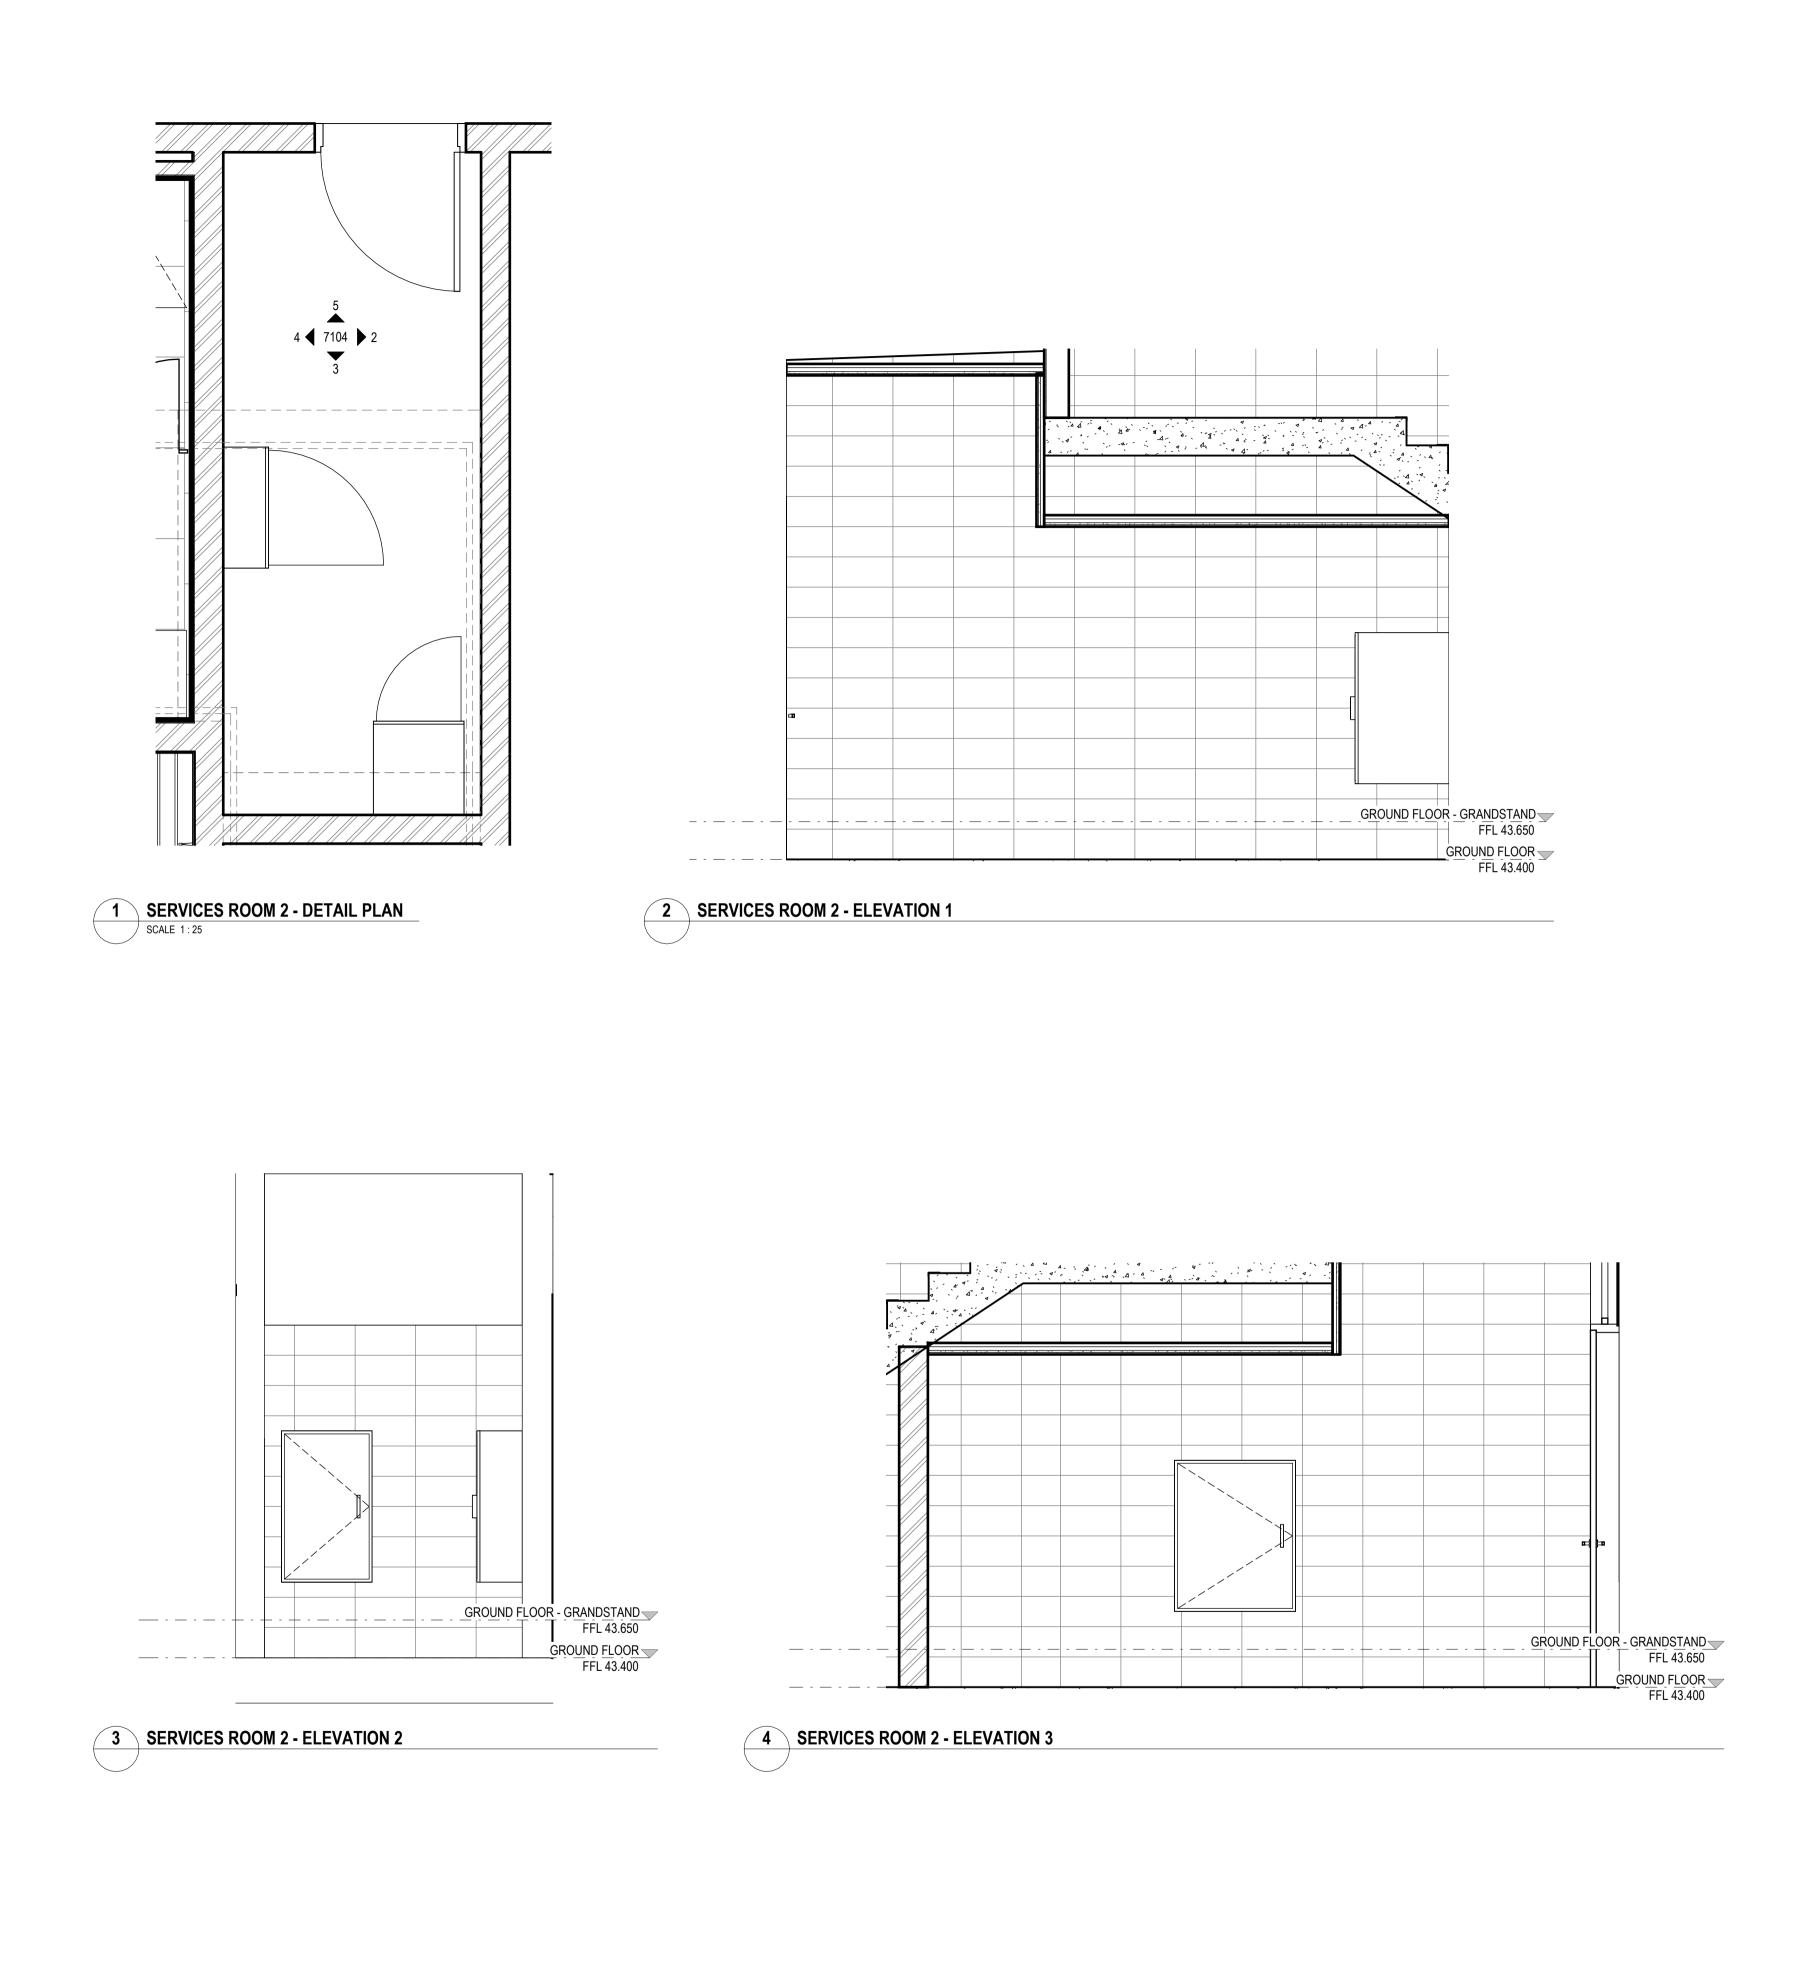

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FFL 43.650 FFL 43.400


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SCALES 1 : 25 @ A1


TITLE **INTERNAL ROOM ELEVATIONS -SERVICES ROOM 2** DRAWING NO. BPR-DIS-AR-DRG-7104
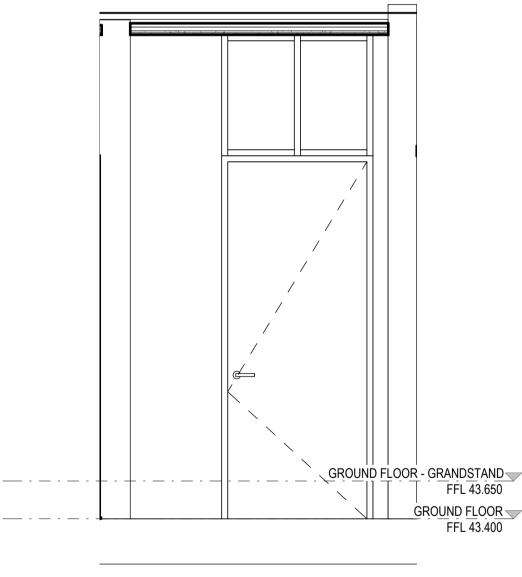
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> REVISION A



### 1 KITCHEN AND BAR - DETAIL PLAN SCALE 1:25

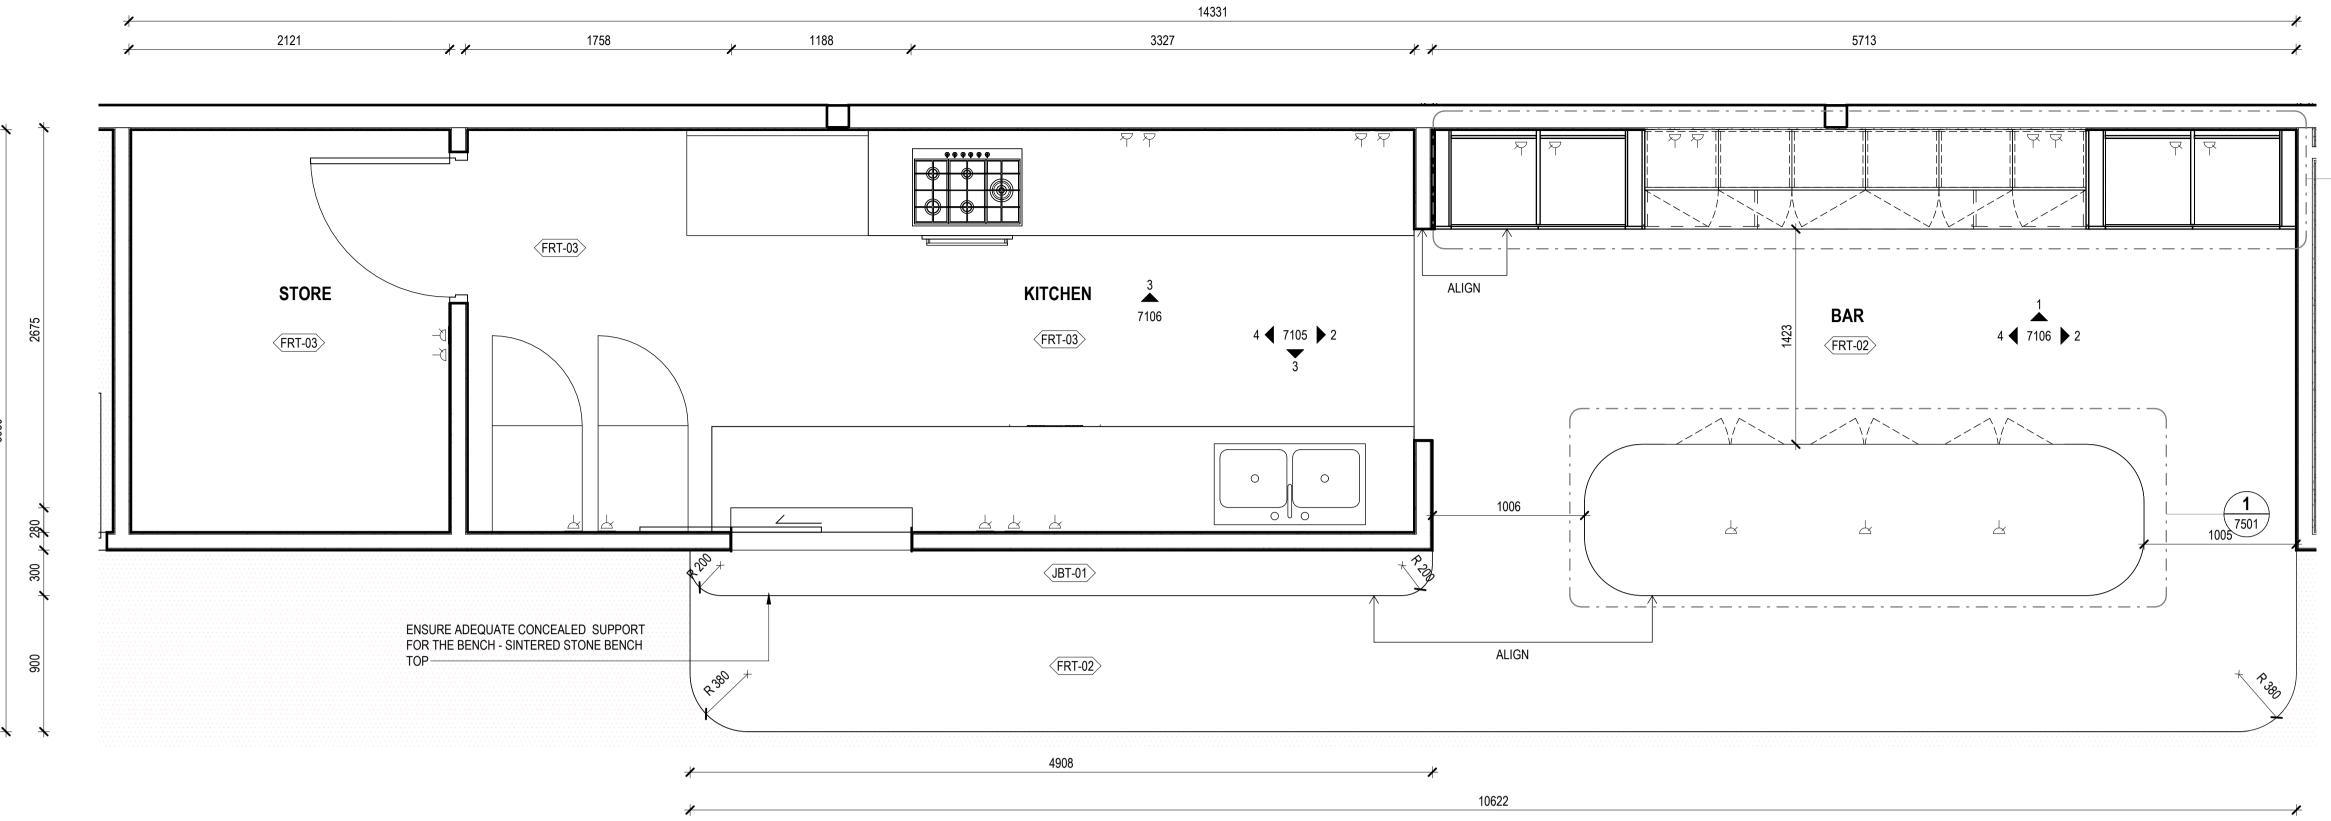
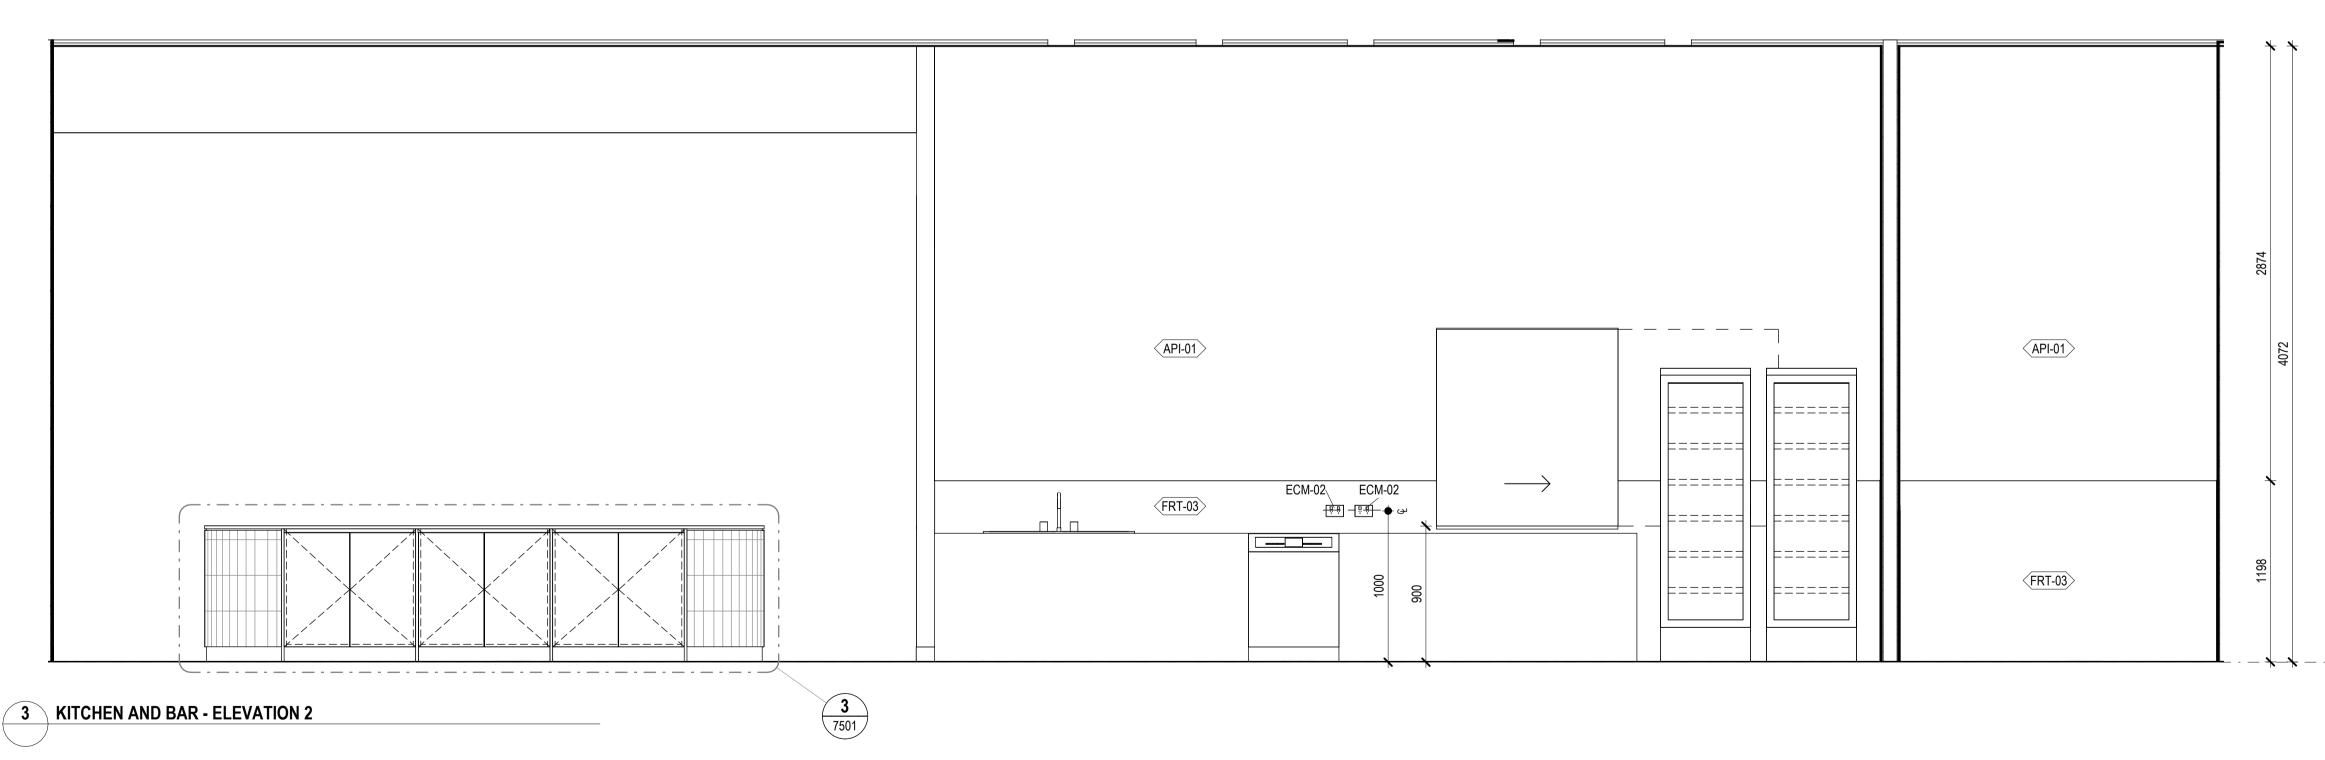
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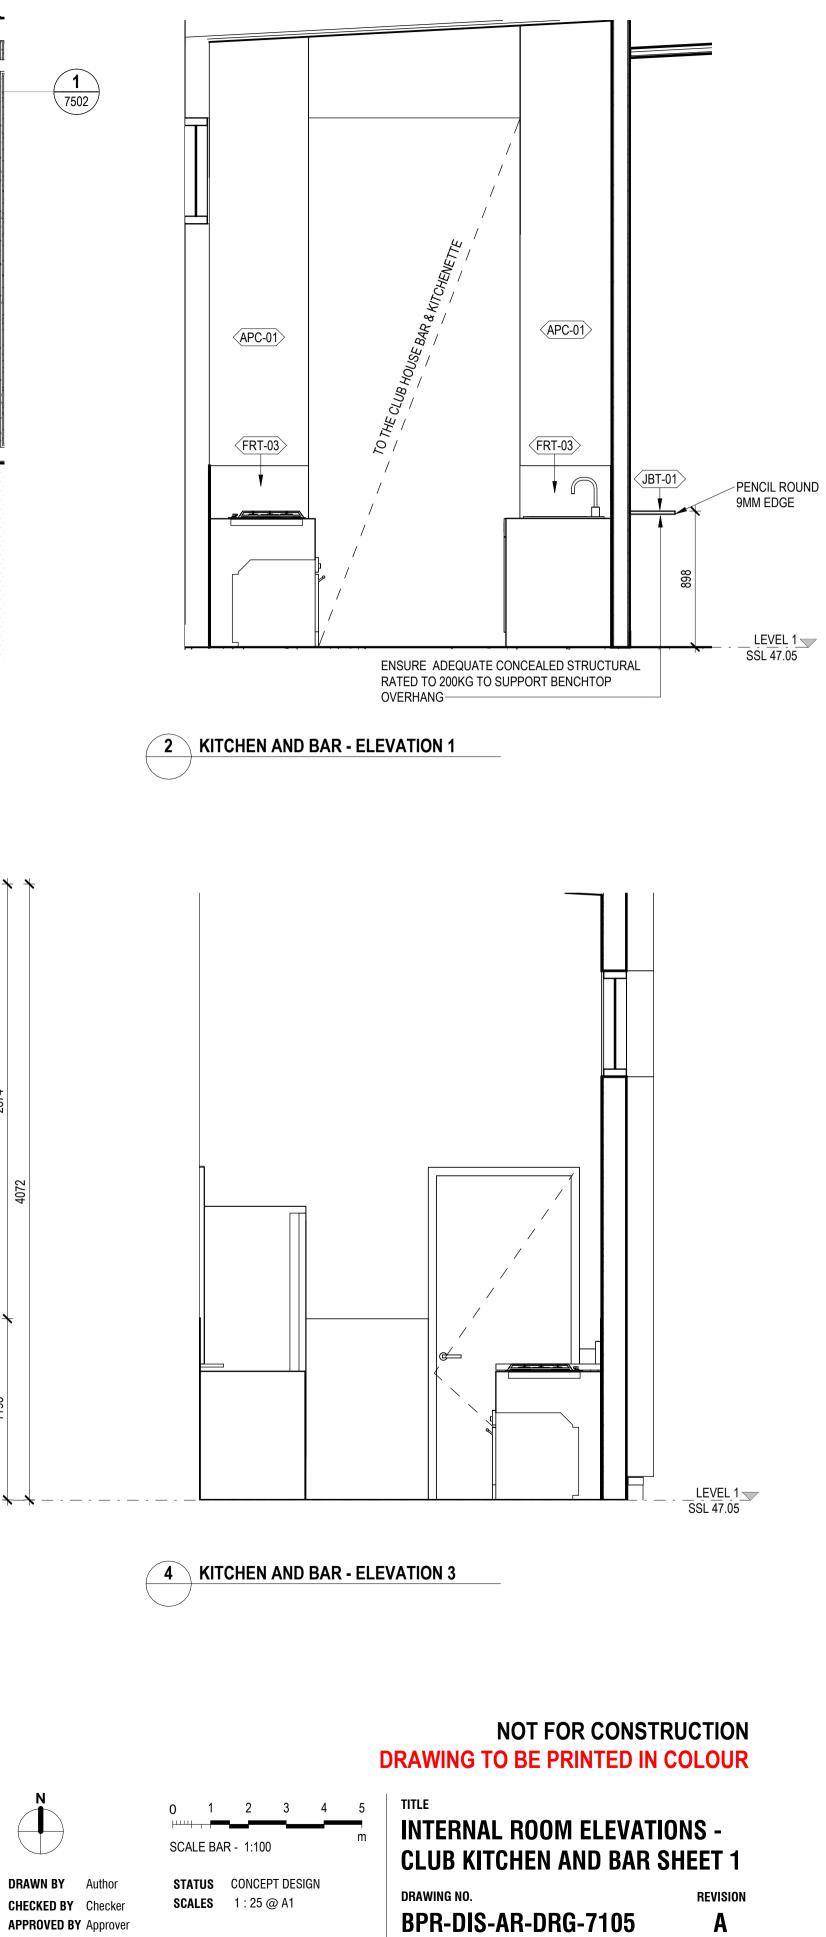



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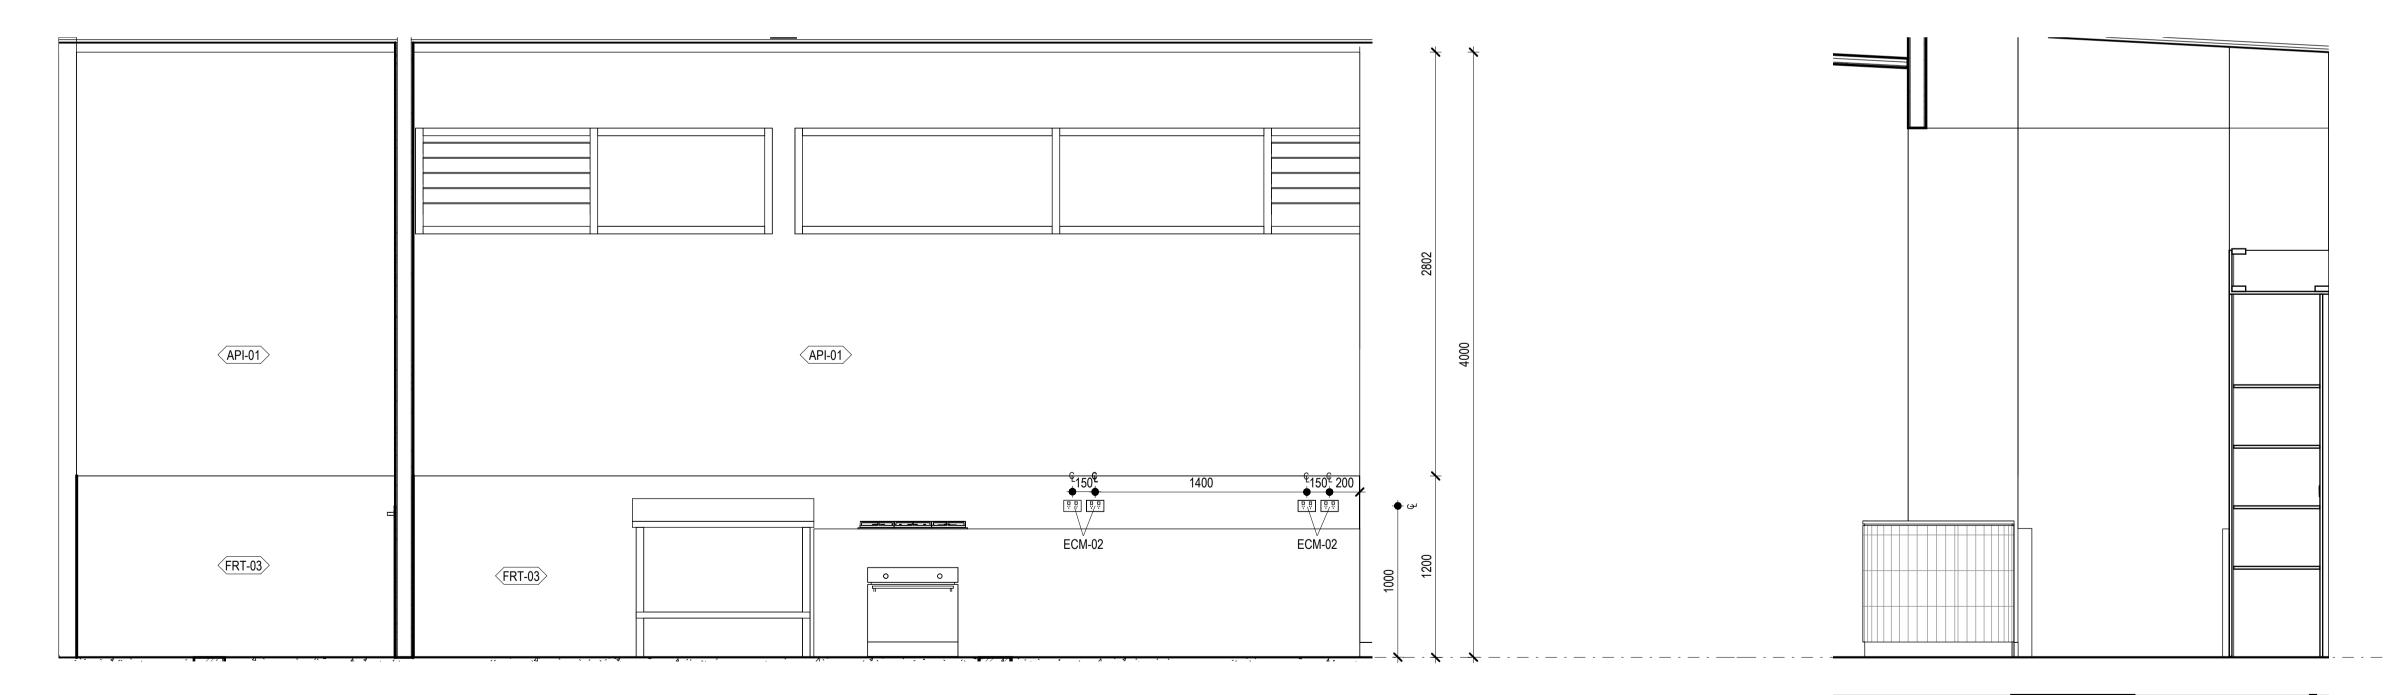
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#### **3** KITCHEN AND BAR - ELEVATION 6

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CLIENT




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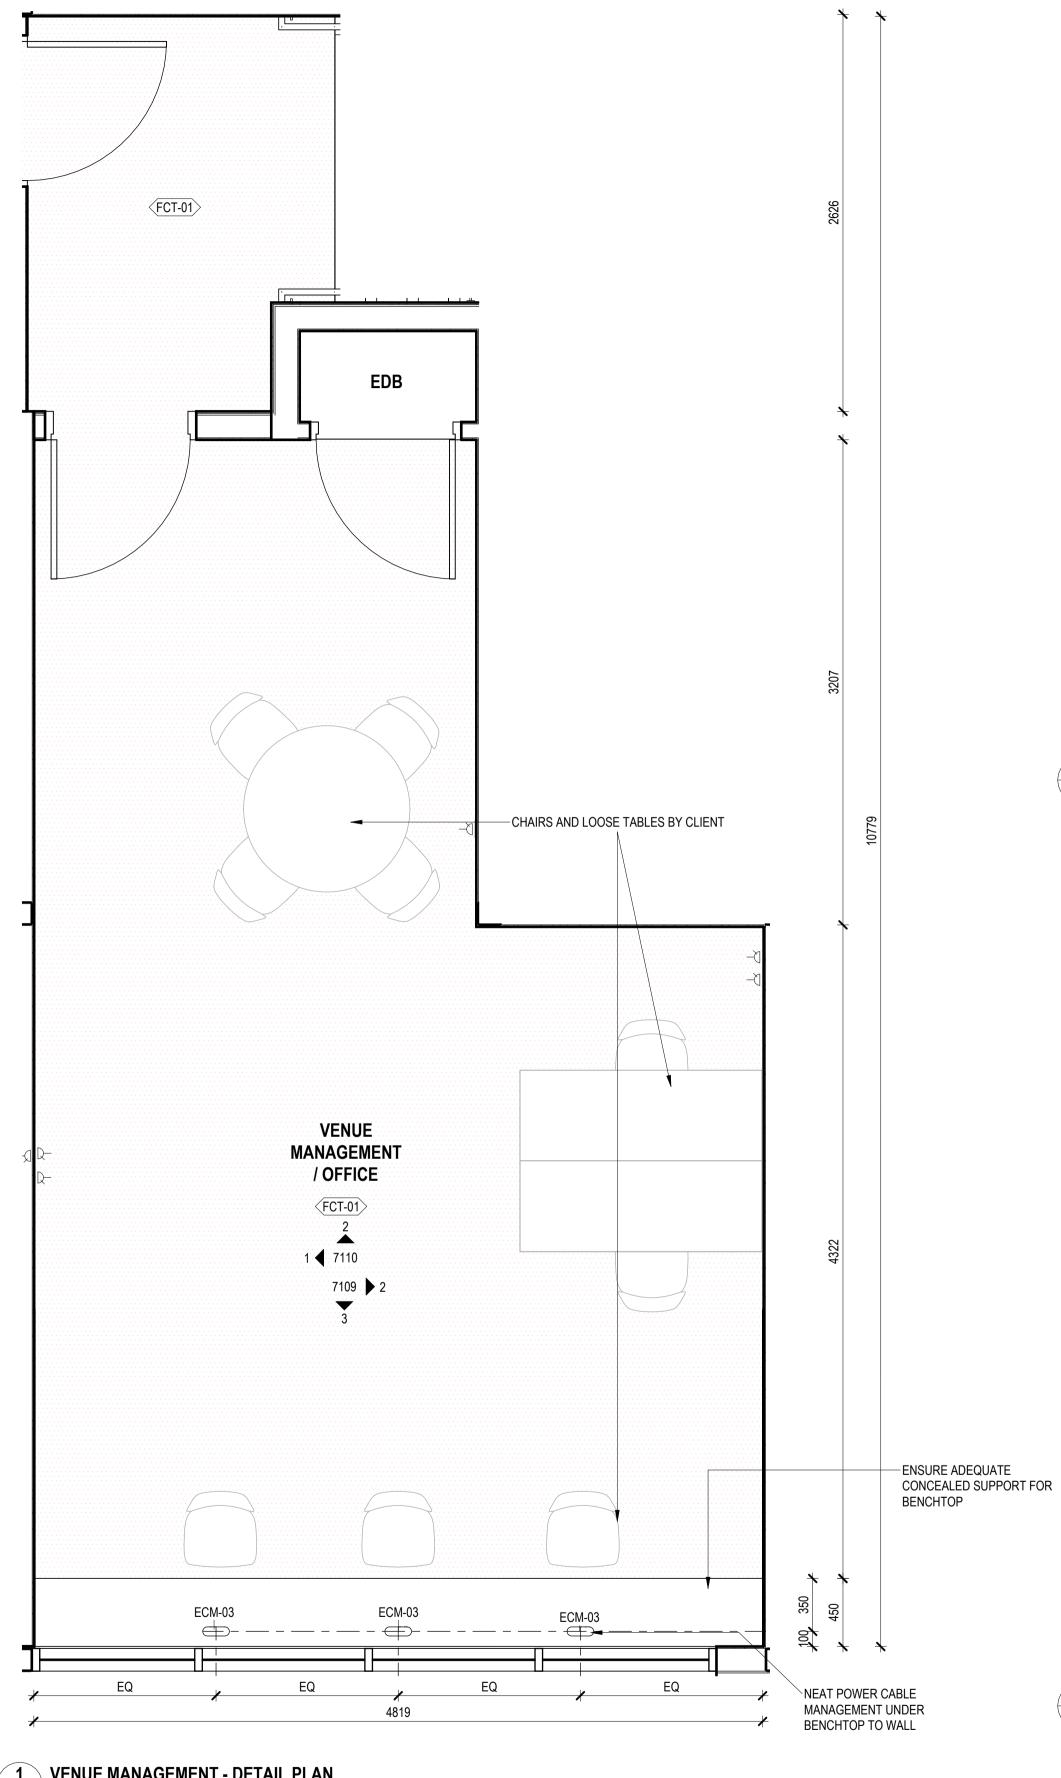


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TITLE **INTERNAL ROOM ELEVATIONS -CLUB KITCHEN AND BAR SHEET 2** DRAWING NO. REVISION **BPR-DIS-AR-DRG-7106** Α
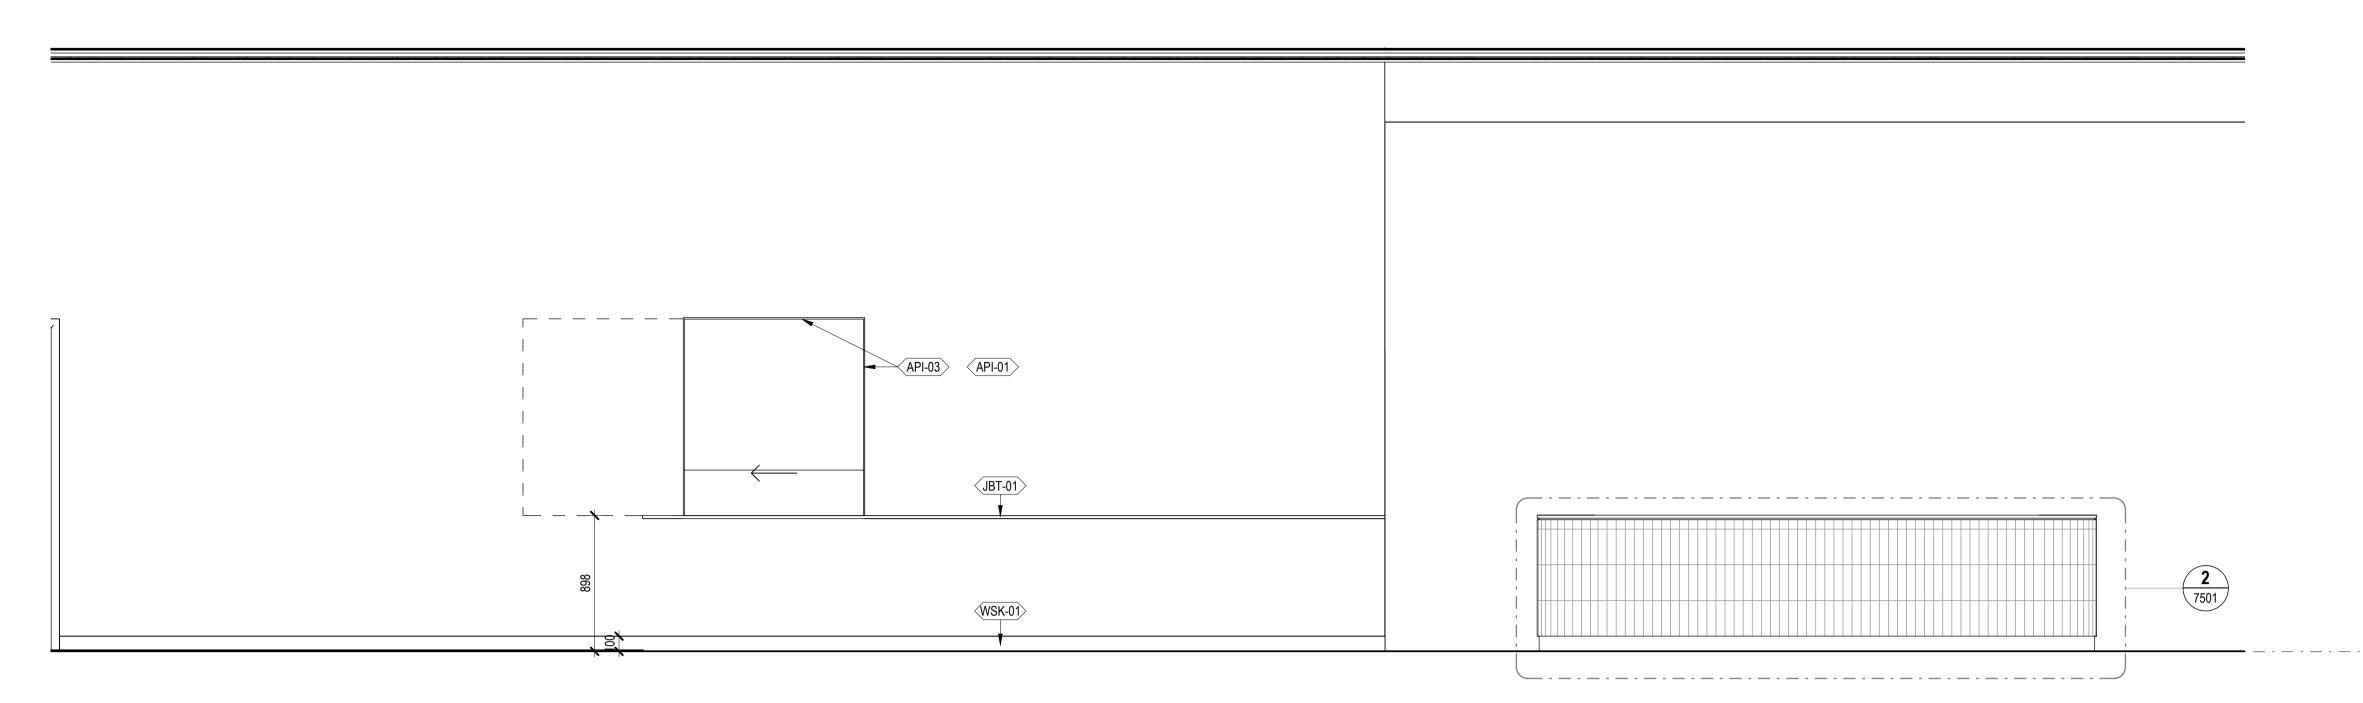
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STATUS CONCEPT DESIGN SCALES 1 : 25 @ A1



**1** VENUE MANAGEMENT - DETAIL PLAN
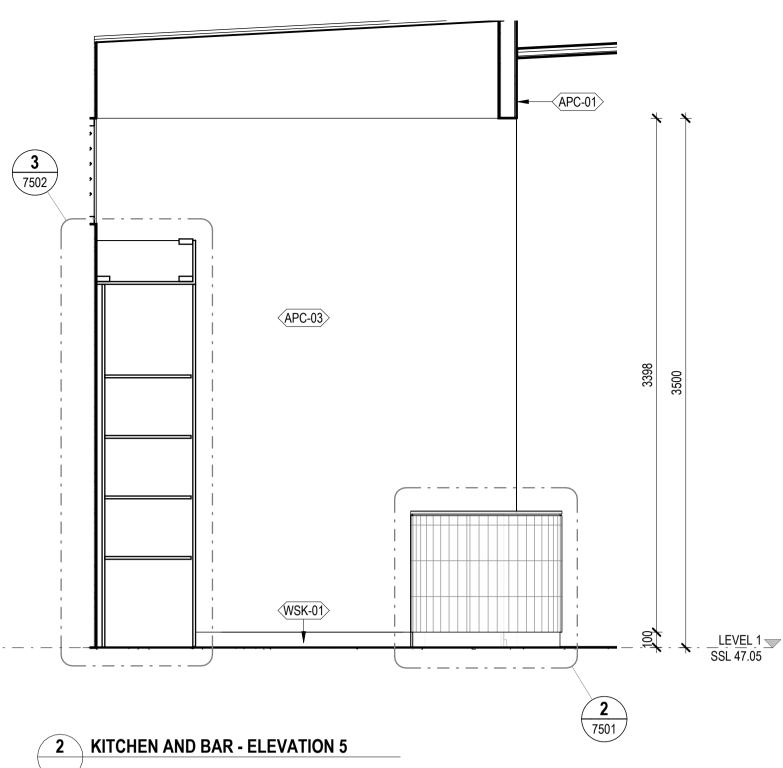
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### WORK-IN-PROGRESS






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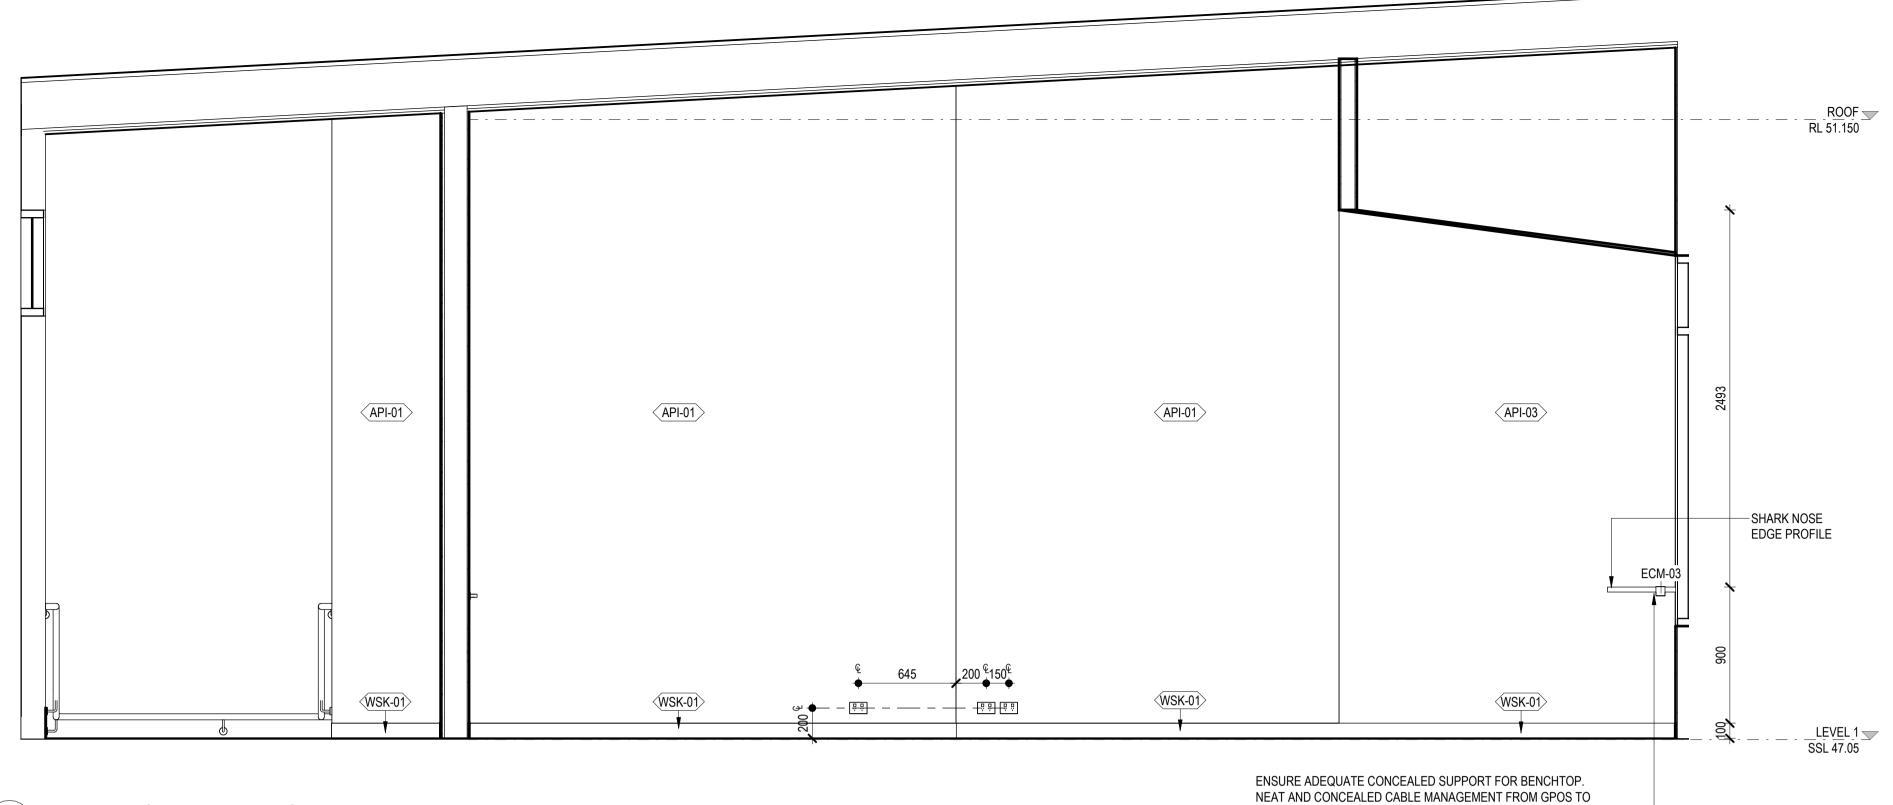
WALL -

3 VENUE MANAGEMENT - ELEVATION 2

CLIENT



**2** VENUE MANAGEMENT - ELEVATION 1

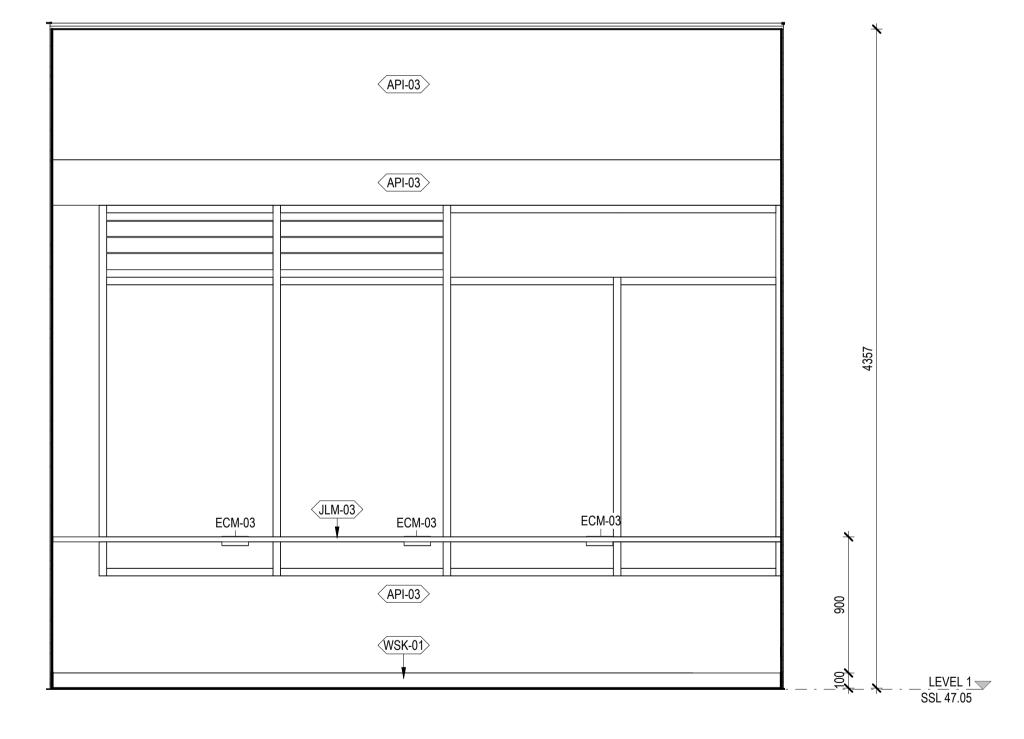


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0 1 2 3 4 5 SCALE BAR - 1:100

> REVISION Α



1 VENUE MANAGEMENT - ELEVATION 3

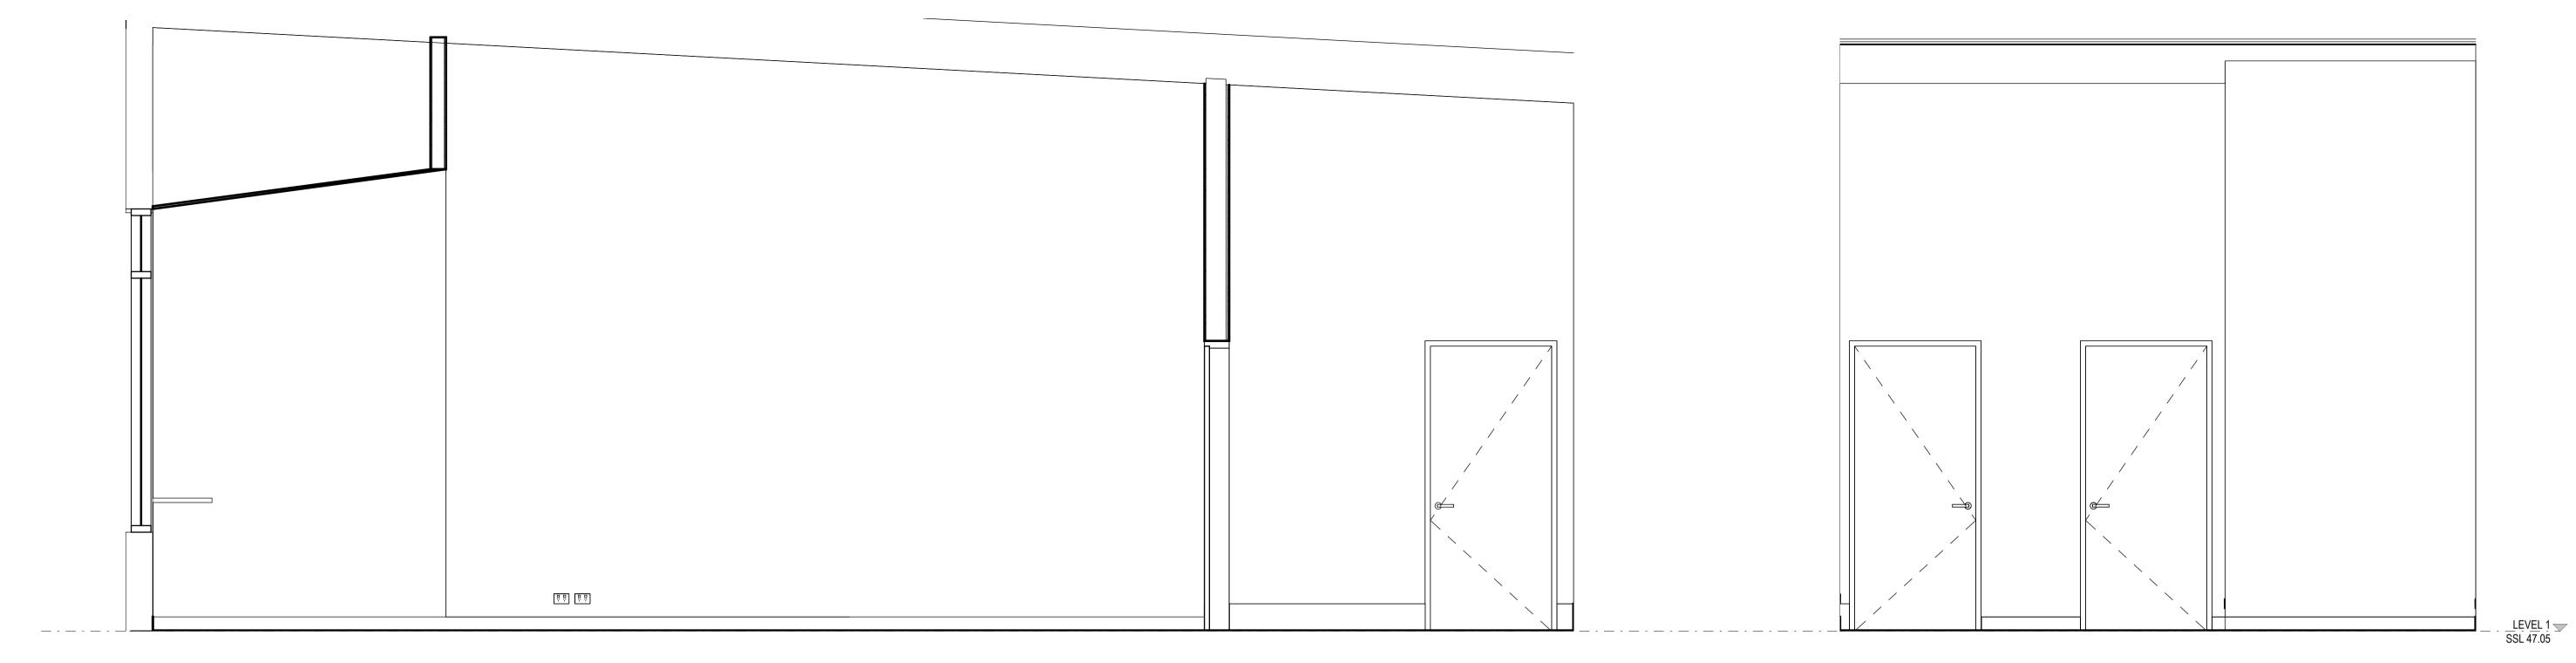



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**2** ACCESSIBLE CLUB ROOM WC - ELEVATION 1

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1 ACCESSIBLE WC - LEVEL ONE - DETAIL PLAN SCALE 1:25

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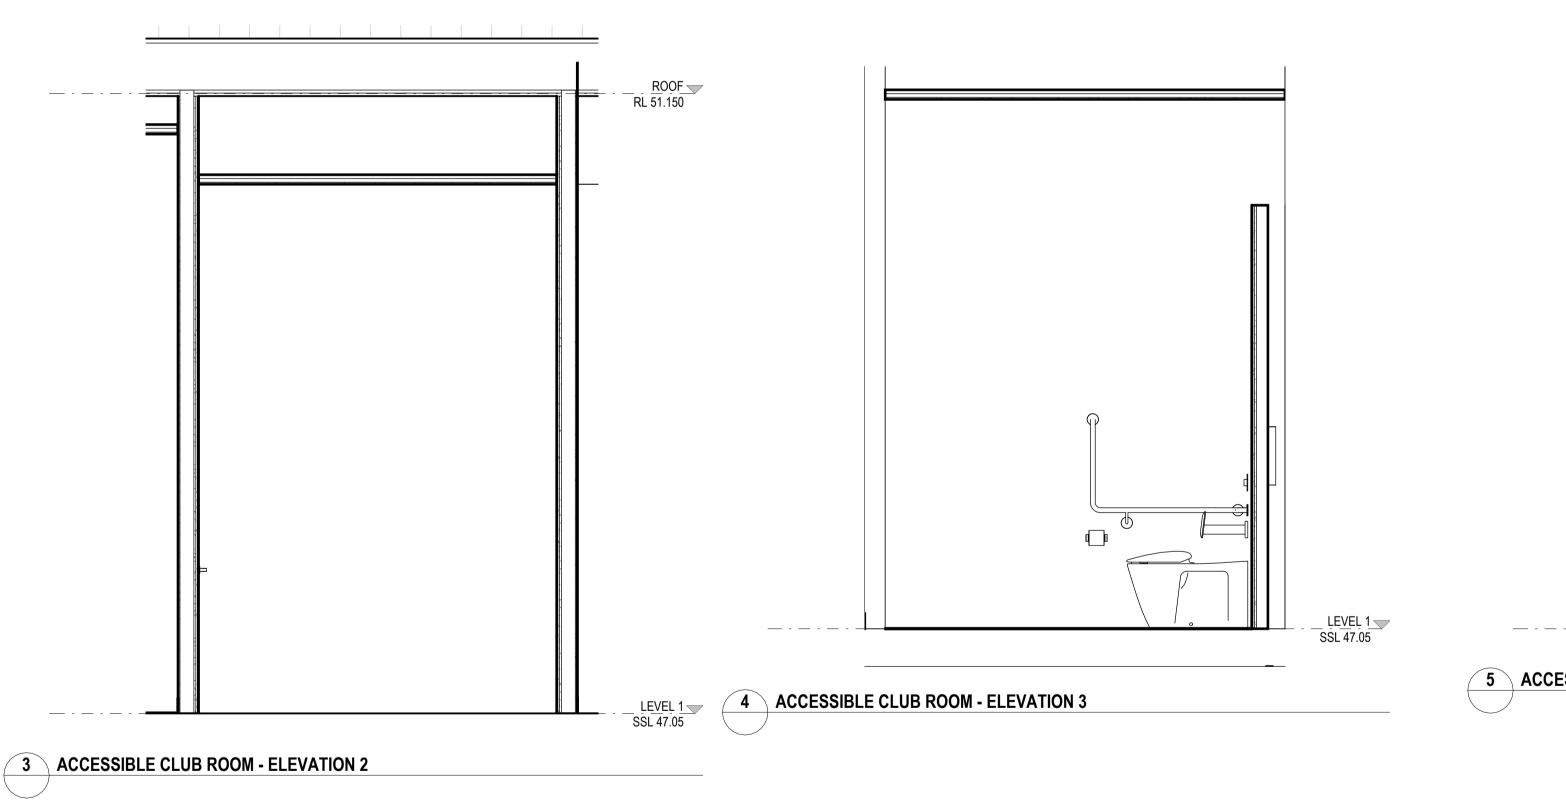
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### WORK-IN-PROGRESS


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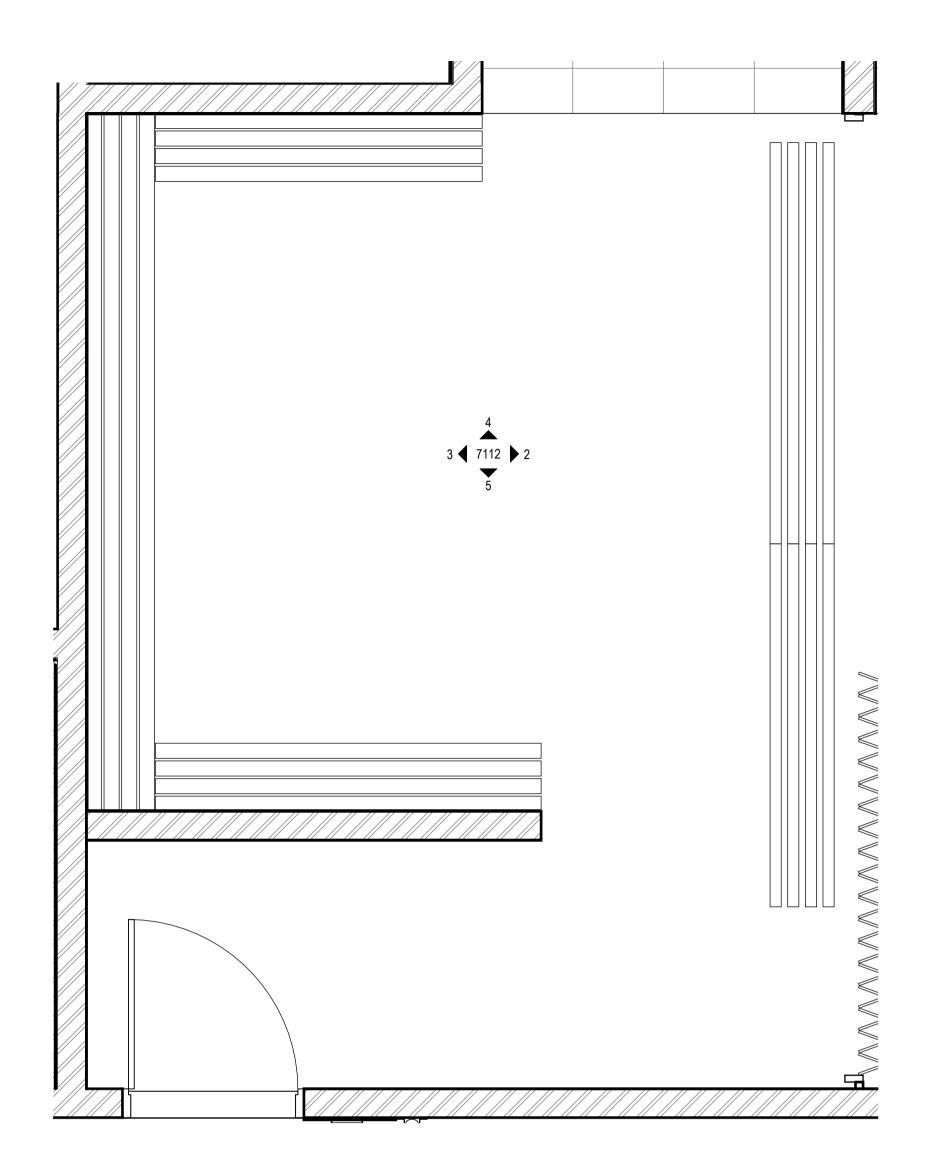
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**5** ACCESSIBLE CLUB ROOM WC - ELEVATION 4




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SCALES 1 : 25 @ A1



1 PLAYERS CHANGE ROOM - DETAIL PLAN

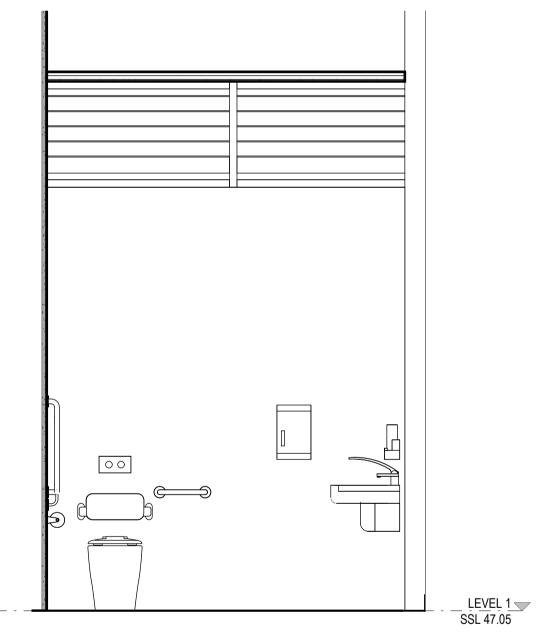

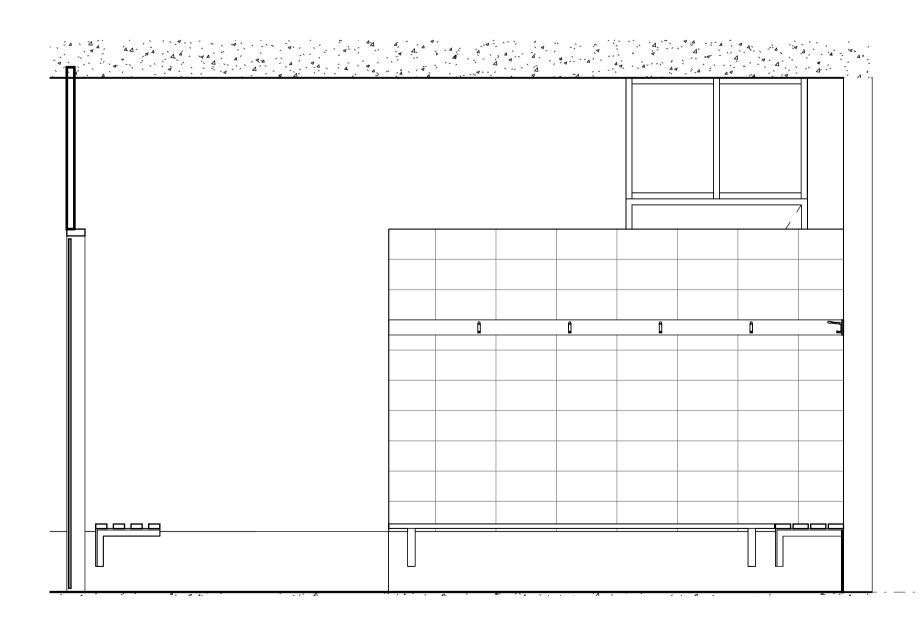**5** PLAYERS CHANGE ROOM - ELEVATION 2

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Nominated Architects


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4 PLAYERS CHANGE ROOM - ELEVATION 4



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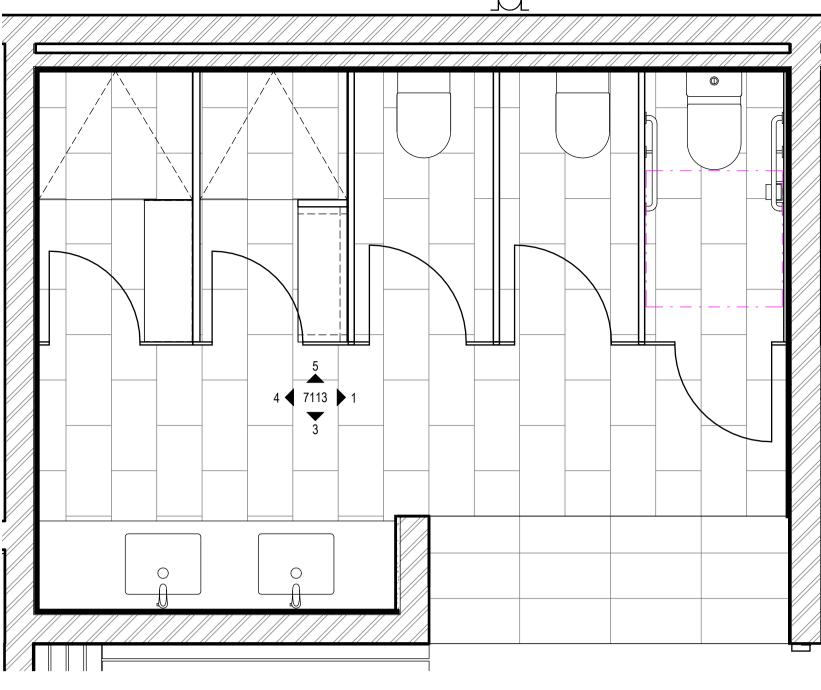
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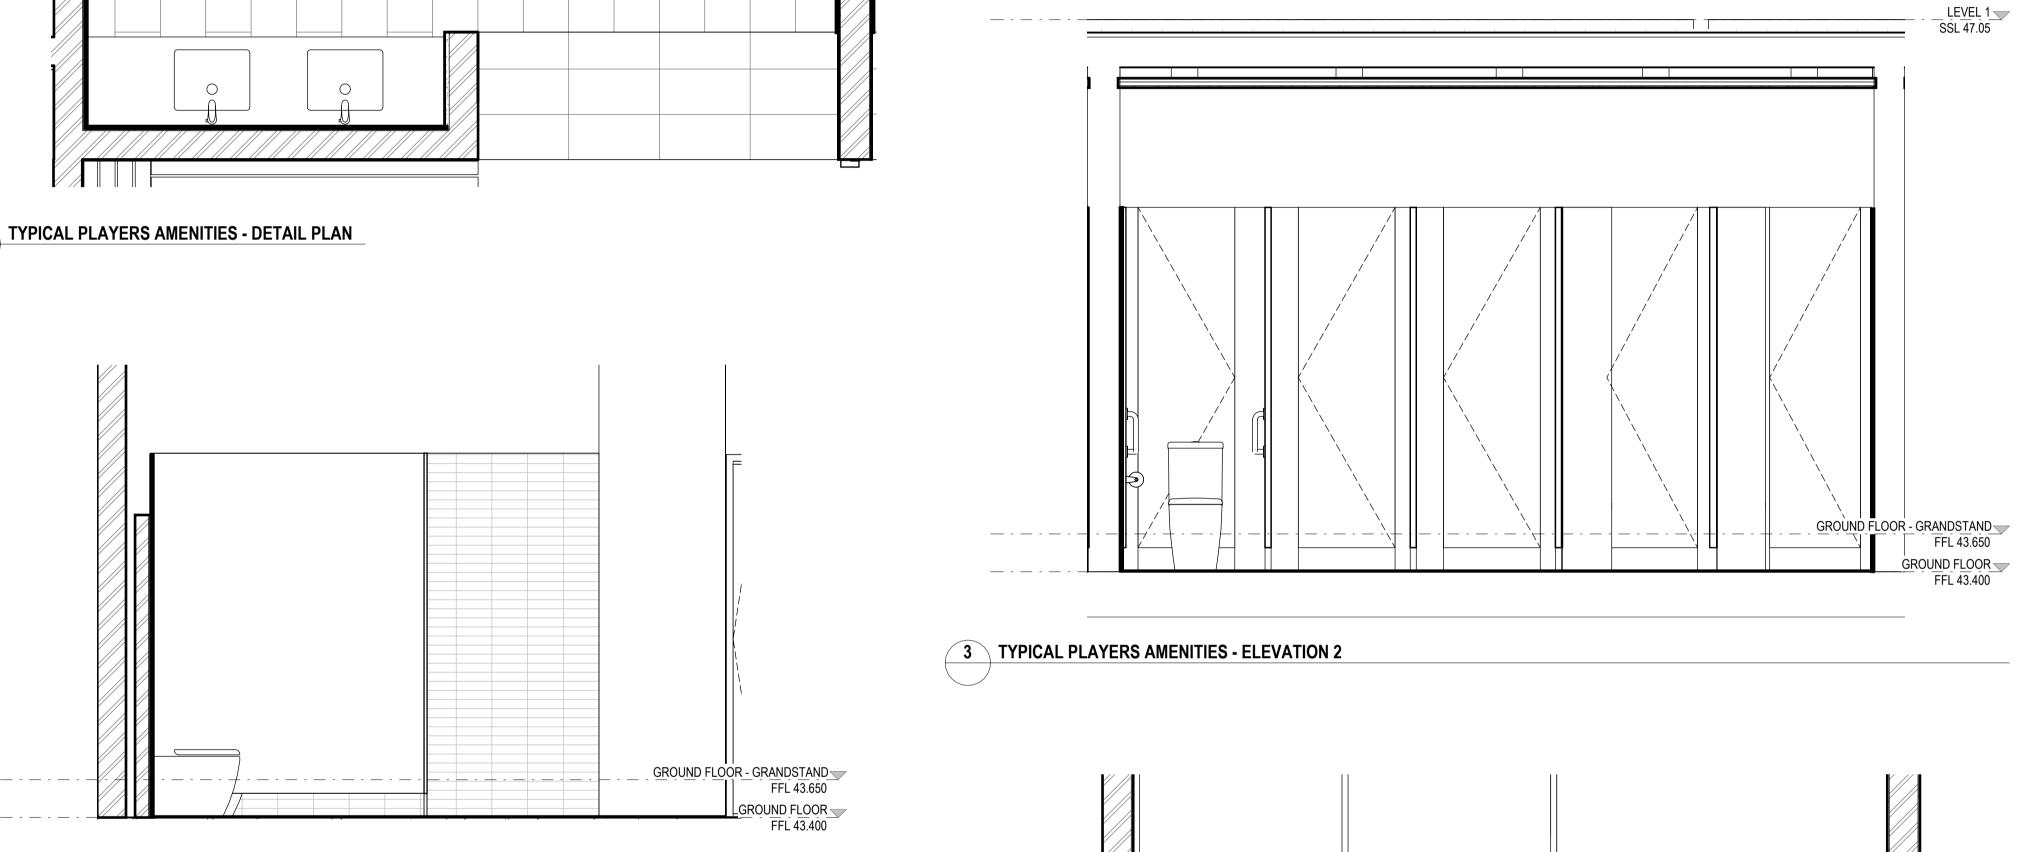
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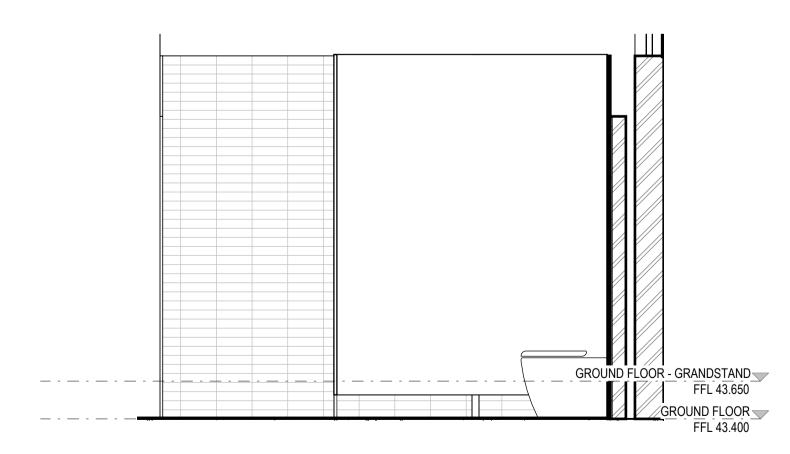
TITLE **INTERNAL ROOM ELEVATIONS -TYPICAL PLAYER'S CHANGE ROOM** SHEET. 1 REVISION **BPR-DIS-AR-DRG-7112** Α





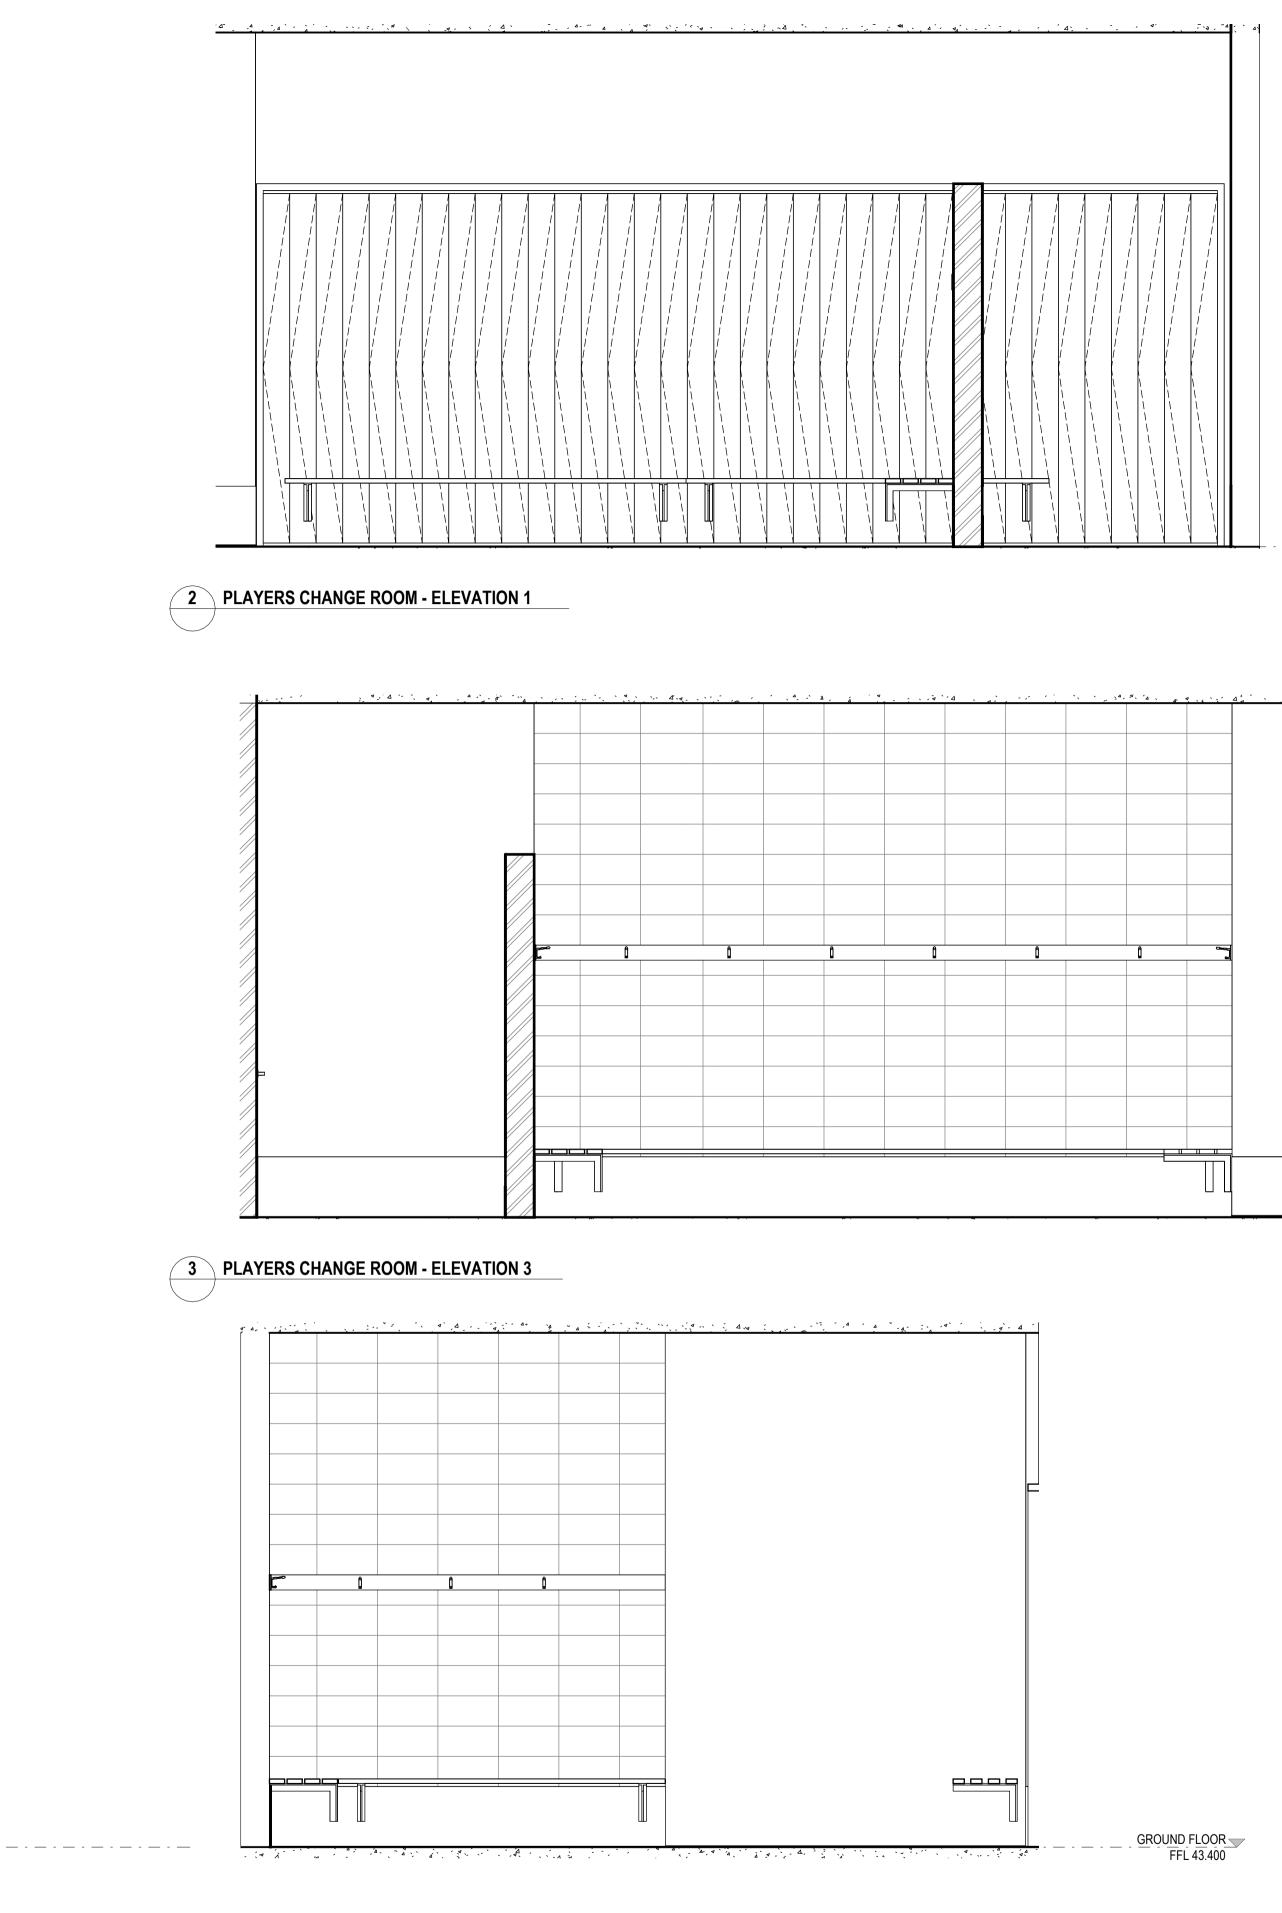

**1** TYPICAL PLAYERS AMENITIES - ELEVATION 1



**4** TYPICAL PLAYERS AMENITIES - ELEVATION 3

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Nominated Architects

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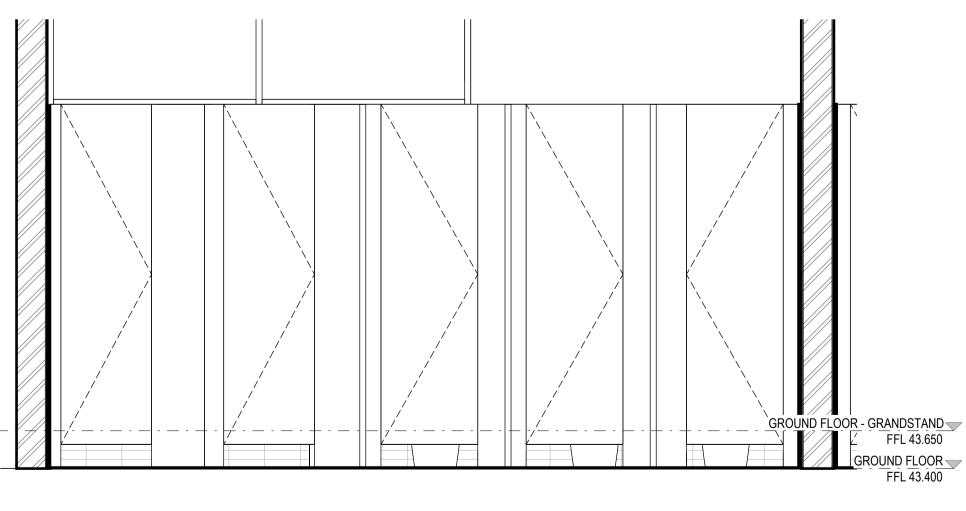
lan Armstrong



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**5** TYPICAL PLAYERS AMENITIES - ELEVATION 4

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#### PROJECT **BOB PRENTER RESERVE AMENITY BUILDING**

PROJECT ADDRESS Fields Rd, Macquarie Fields NSW 2564

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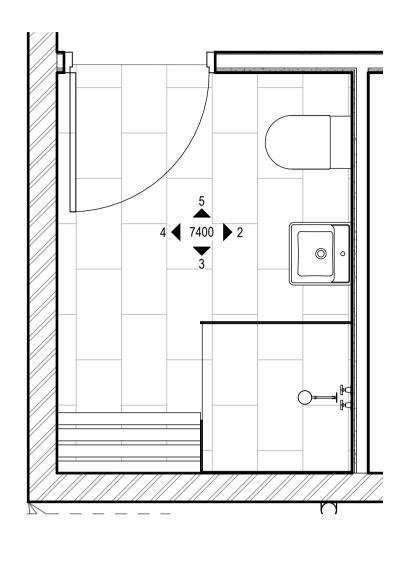
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TITLE **INTERNAL ELEVATIONS - TYPICAL PLAYERS AMENITIES** DRAWING NO. REVISION **BPR-DIS-AR-DRG-7113** 


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STATUS CONCEPT DESIGN SCALES 1 : 25 @ A1



1 UMPIRE ENSUITE - TYPICAL DETAIL PLAN SCALE 1:25



**2** UMPIRE ENSUITE - ELEVATION 1

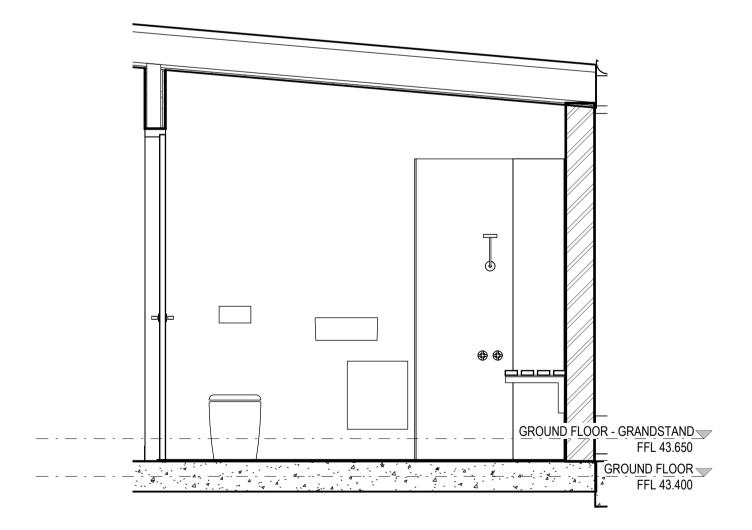



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**3** UMPIRE ENSUITE - ELEVATION 2



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#### PROJECT **BOB PRENTER RESERVE** AMENITY BUILDING


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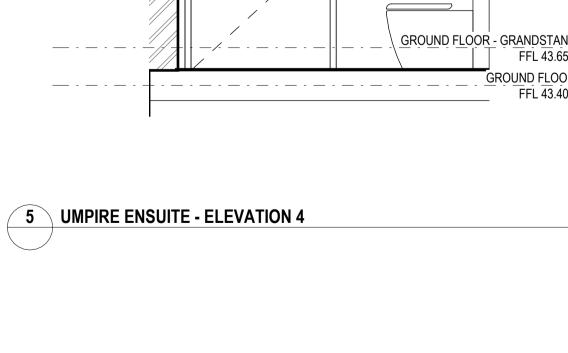
**4** UMPIRE ENSUITE - ELEVATION 3




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						FFL 43.400

TITLE 0 1 2 3 4 5 **INTERNAL WET AREA ELEVATIONS** SCALE BAR - 1:100 - UMPIRE ENSUITE DRAWING NO. REVISION **BPR-DIS-AR-DRG-7400** Α


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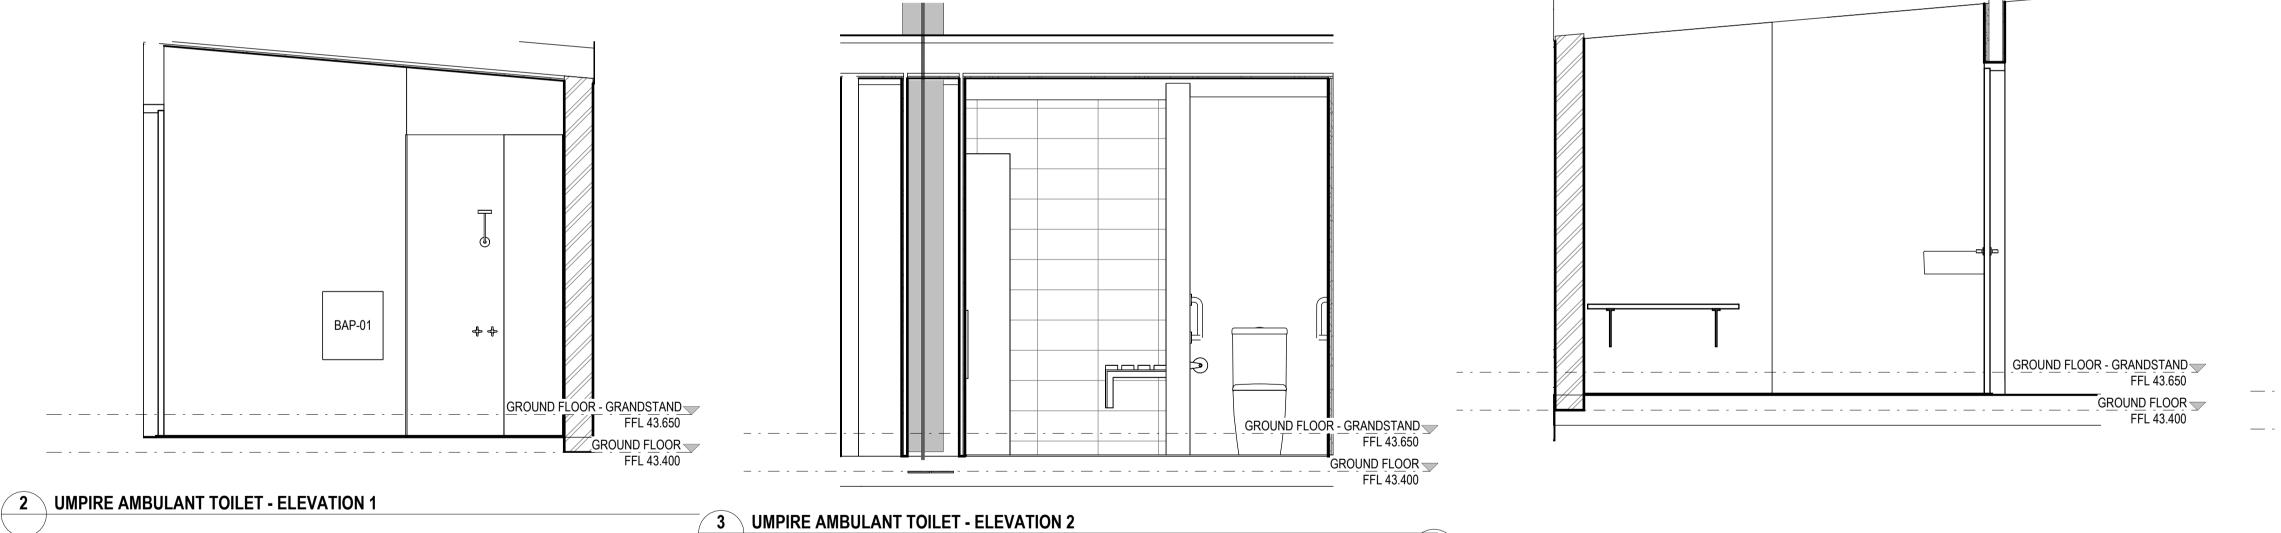


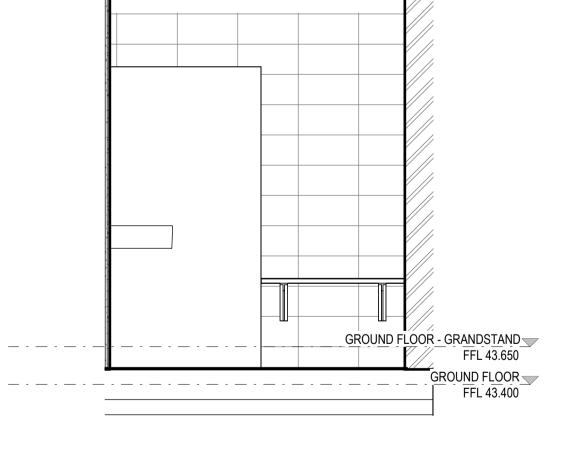SCALES 1 : 25 @ A1

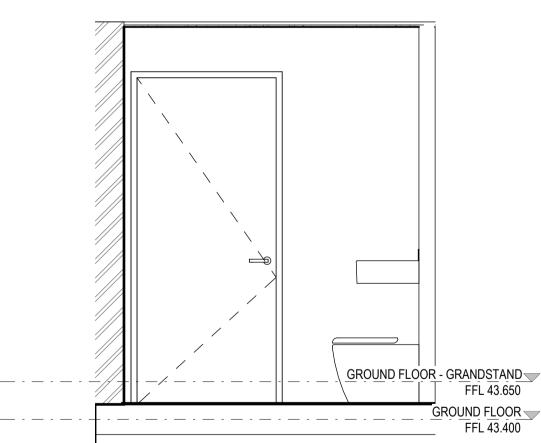STATUS CONCEPT DESIGN



1 UMPIRE AMBULANT TOILET - DETAIL PLAN SCALE 1:25

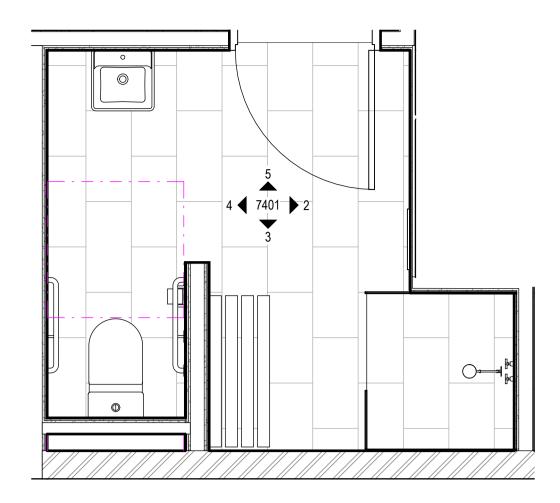

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**4** UMPIRE AMBULANT TOILET - ELEVATION 3




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## DRAWING TO BE PRINTED IN COLOUR

**INTERNAL ELEVATIONS - UMPIRE** 

NOT FOR CONSTRUCTION

GROUND FLOOR - GRANDSTAND

FFL 43.650

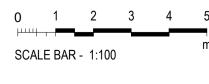0 1 2 3 4 5

STATUS CONCEPT DESIGN SCALES 1 : 25 @ A1

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**5** UMPIRE AMBULANT TOILET - ELEVATION 4


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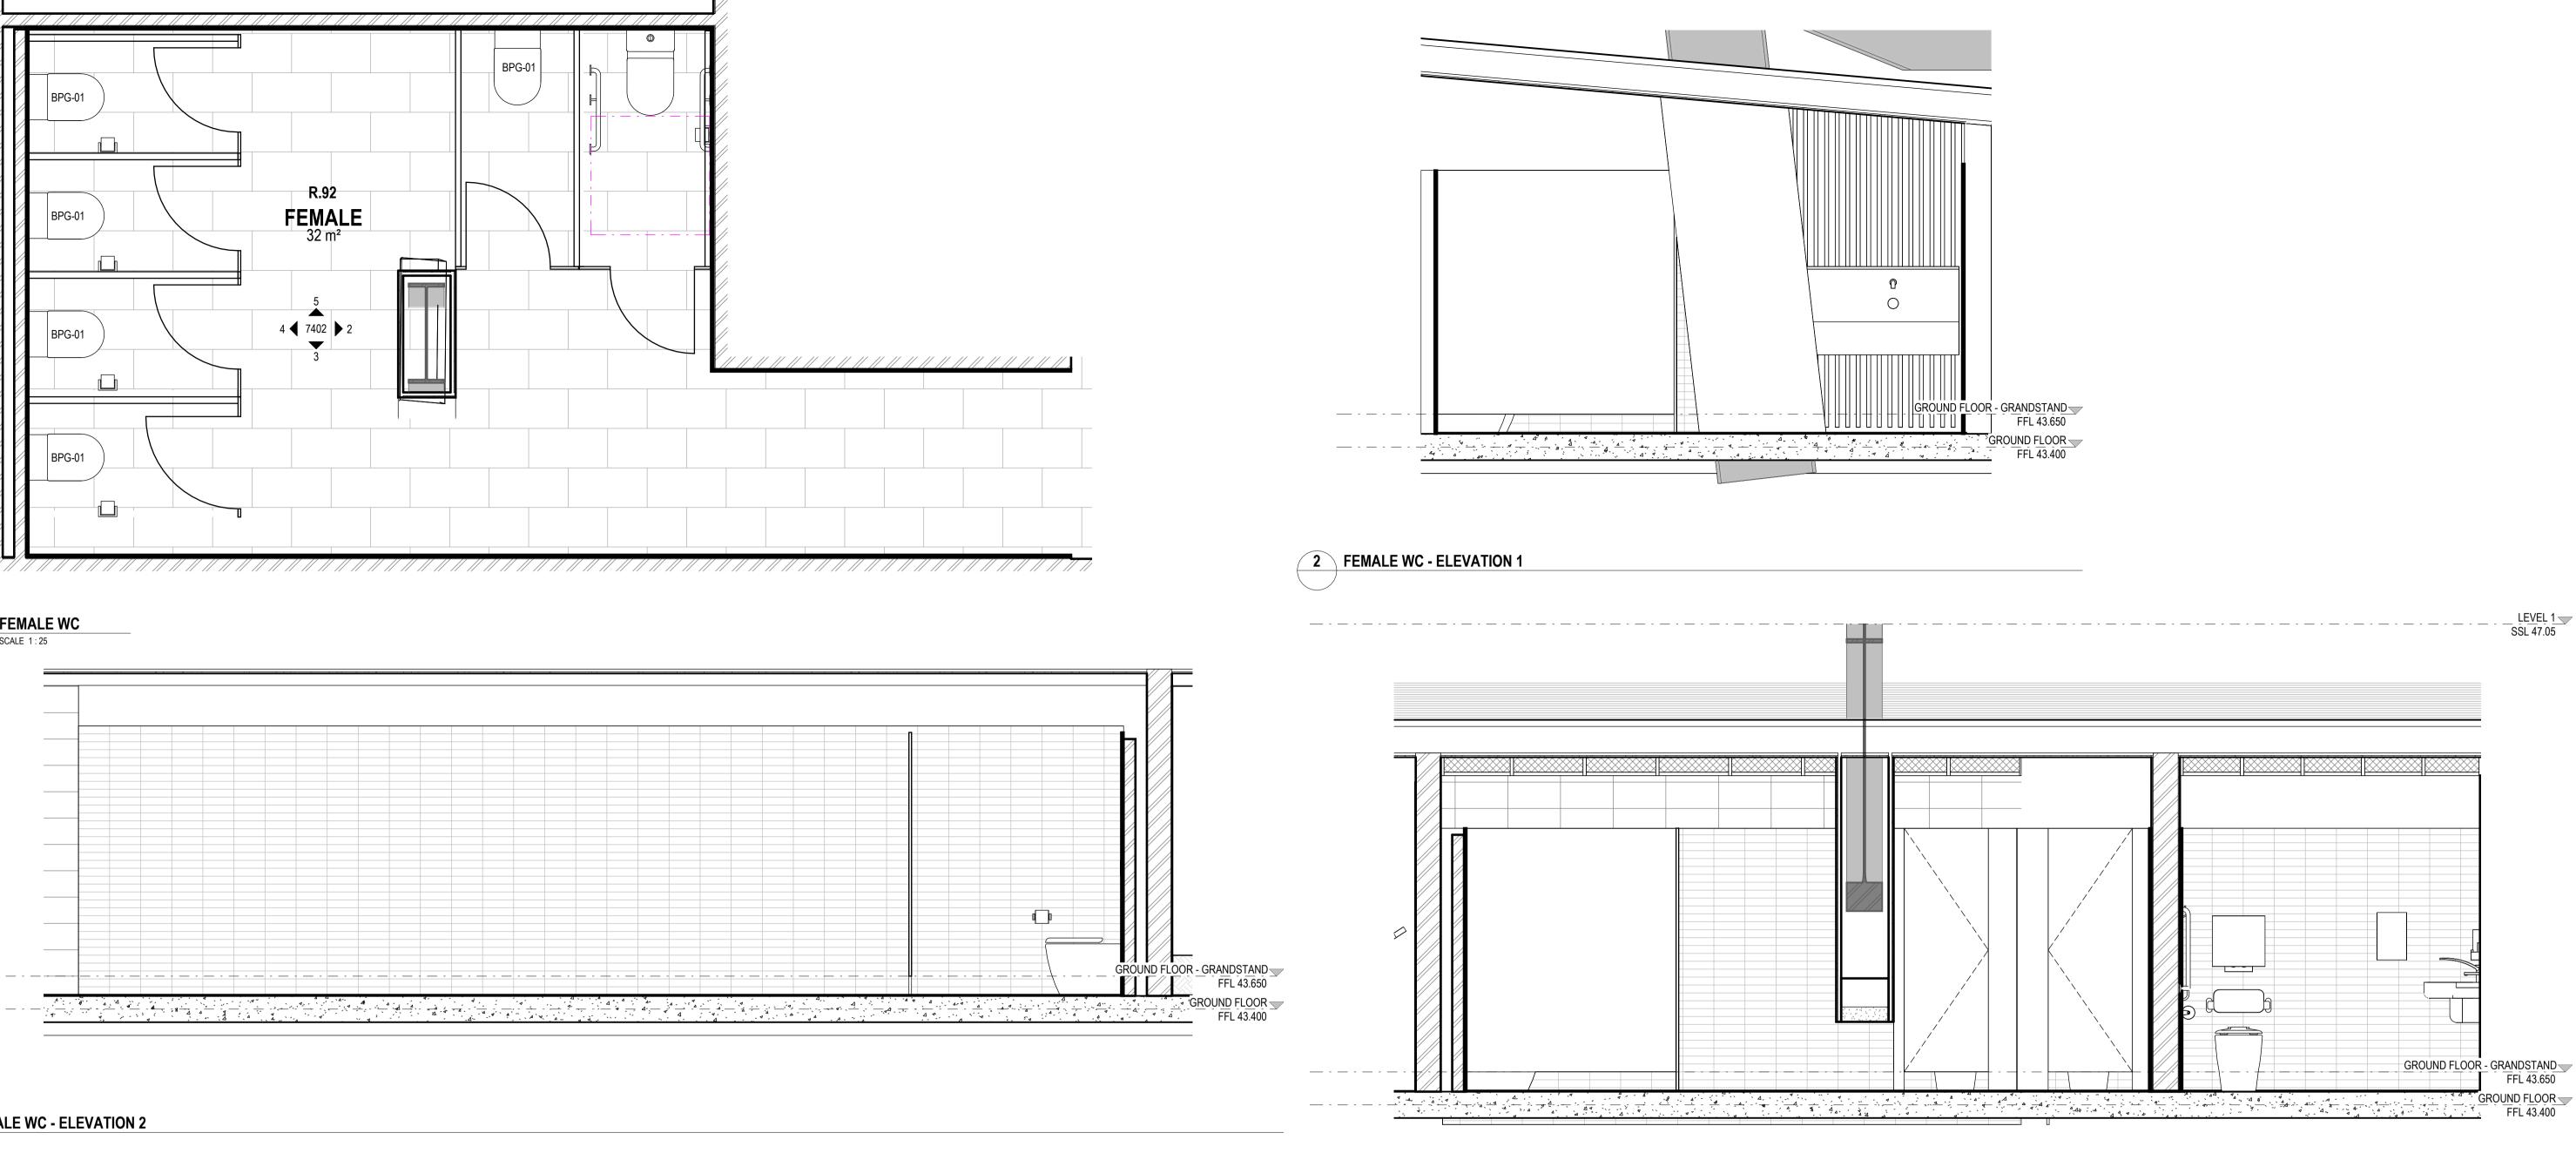
GROUND FLOOR FFL 43.400

AMBULANT WC DRAWING NO. BPR-DIS-AR-DRG-7401


TITLE





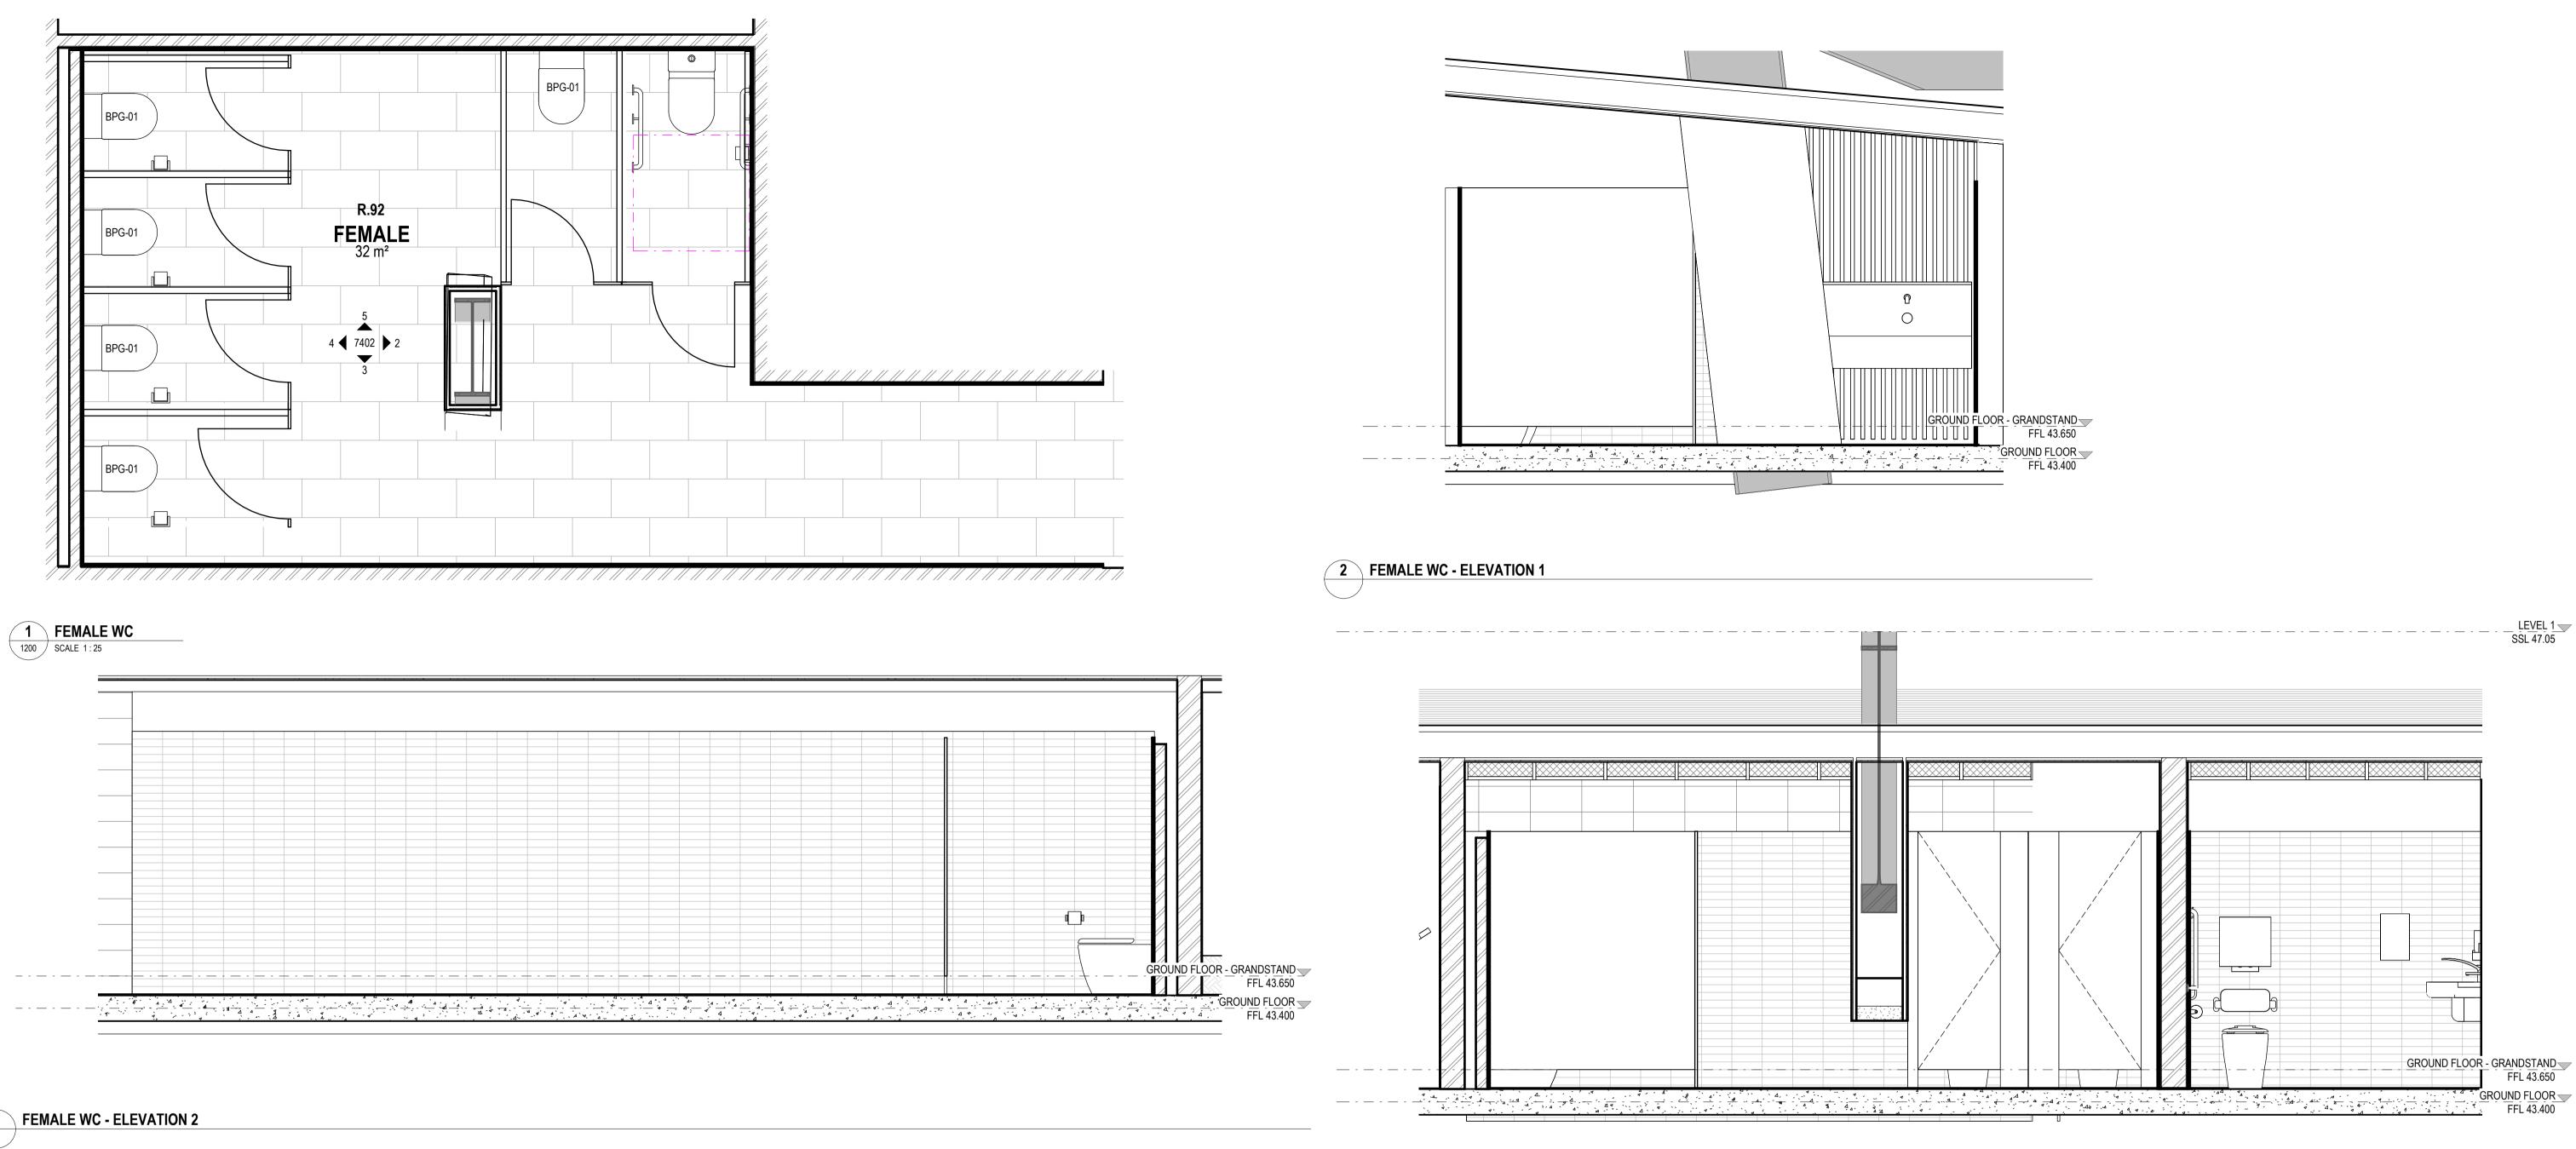

#### FEMALE WC - ELEVATION 2

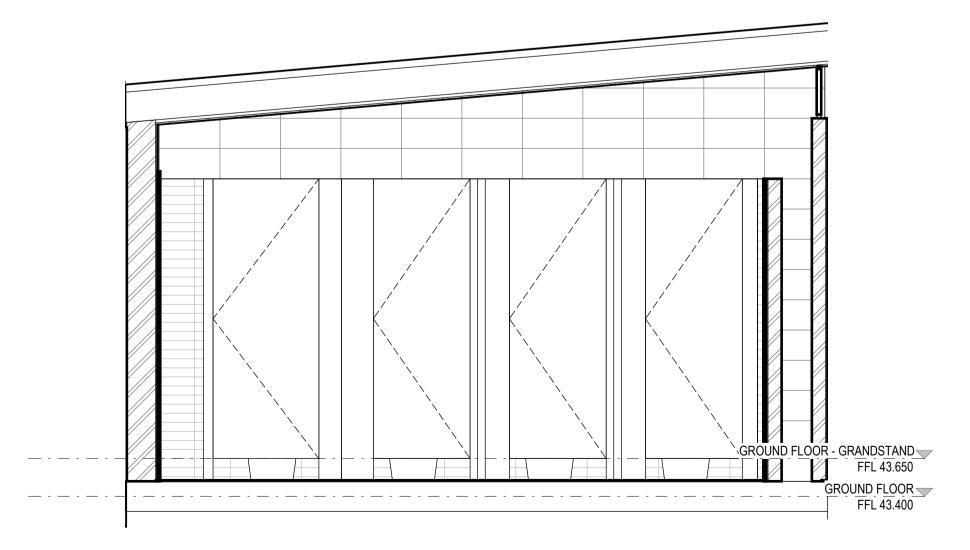

**4** FEMALE WC - ELEVATION 3

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7260 Cathryn Drew-Bredin 7269

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Cameron Martin 9194 Mary Anne McGirr 10946

Nominated Architects

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lan Armstrong

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**5** FEMALE WC - ELEVATION 4



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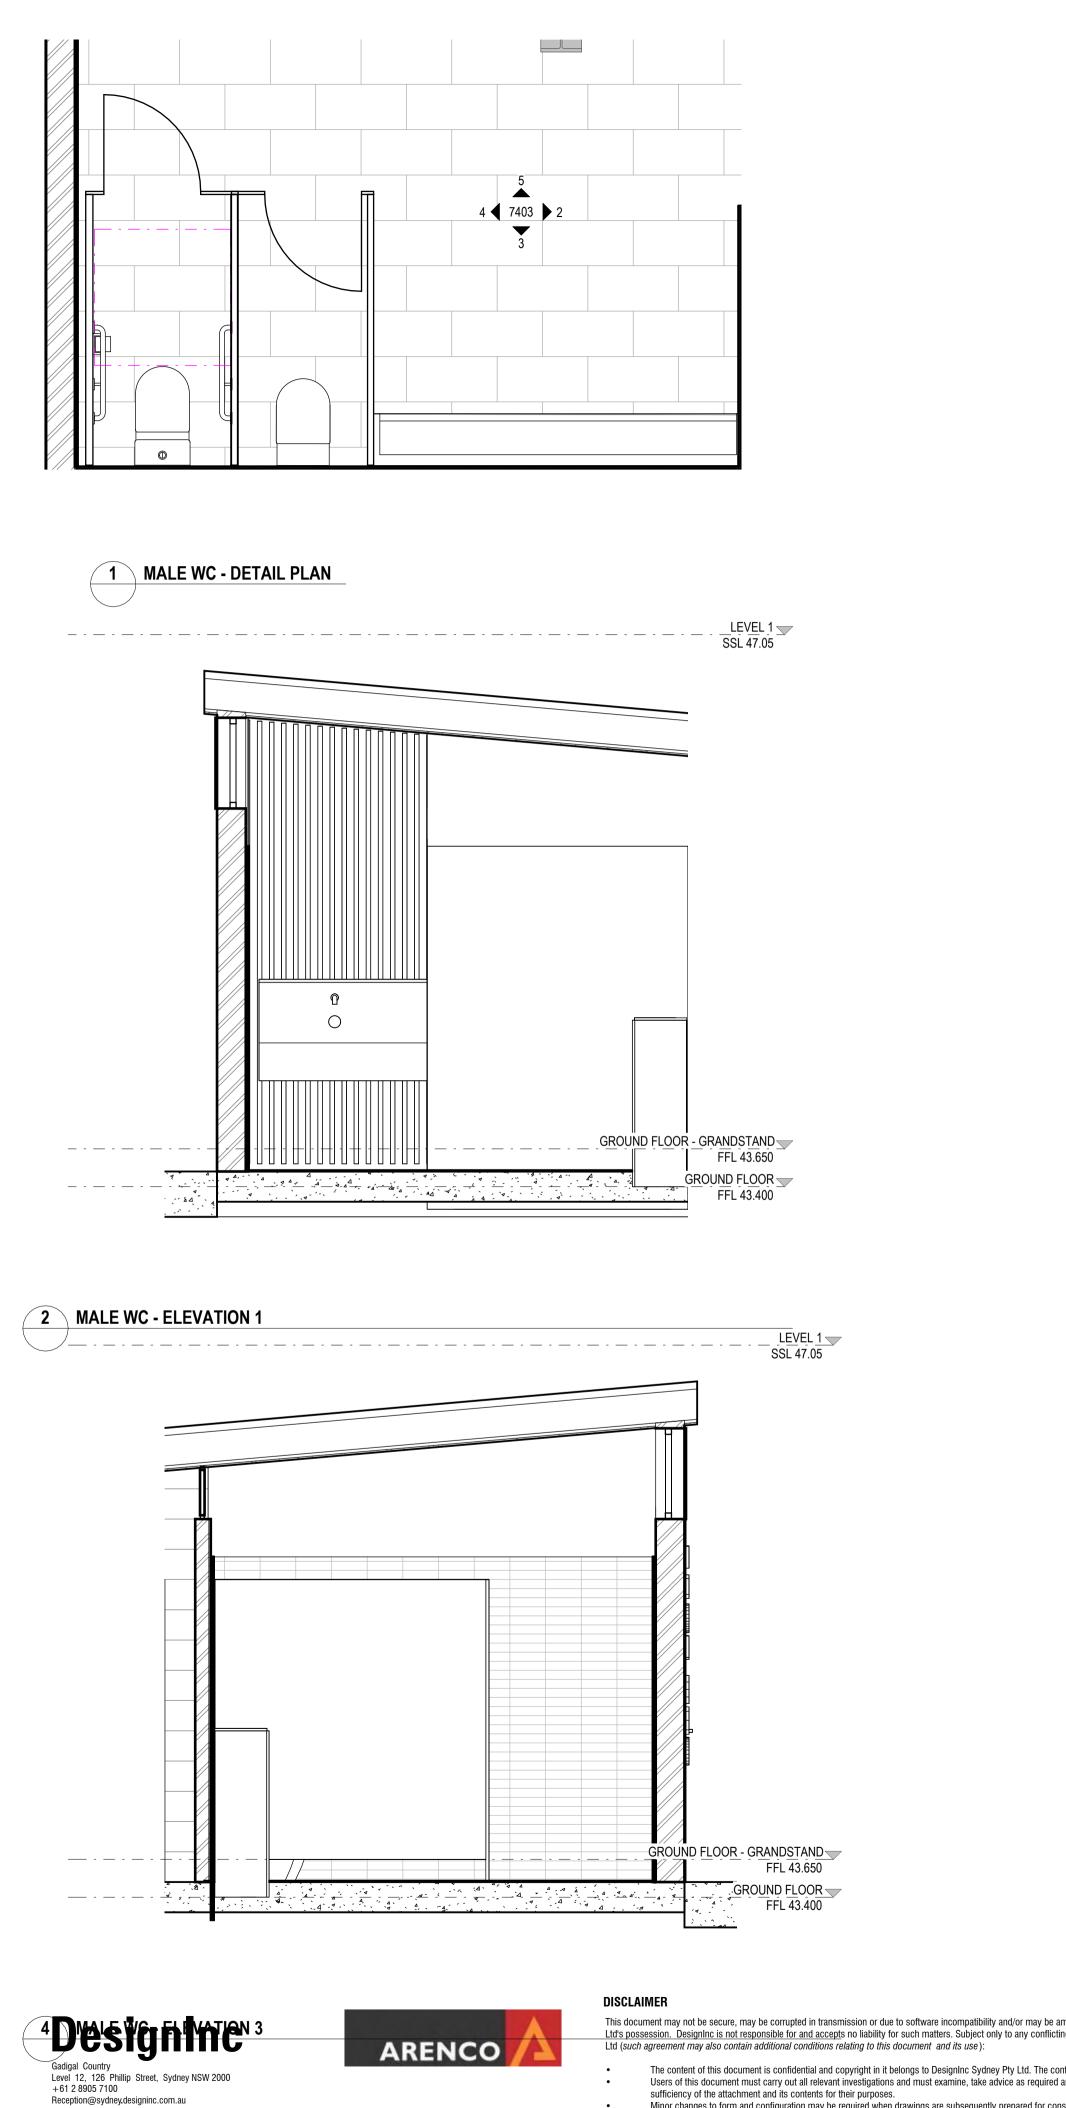


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STATUS CONCEPT DESIGN

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TITLE **INTERNAL WET AREA ELEVATIONS** - FEMALE WC DRAWING NO. REVISION **BPR-DIS-AR-DRG-7402** Α



Nominated Architects 7260 Cathryn Drew-Bredin 7269 lan Armstrong Cameron Martin 9194 Mary Anne McGirr 10946 PLOTTED : 9/12/2024 11:05:58 AM

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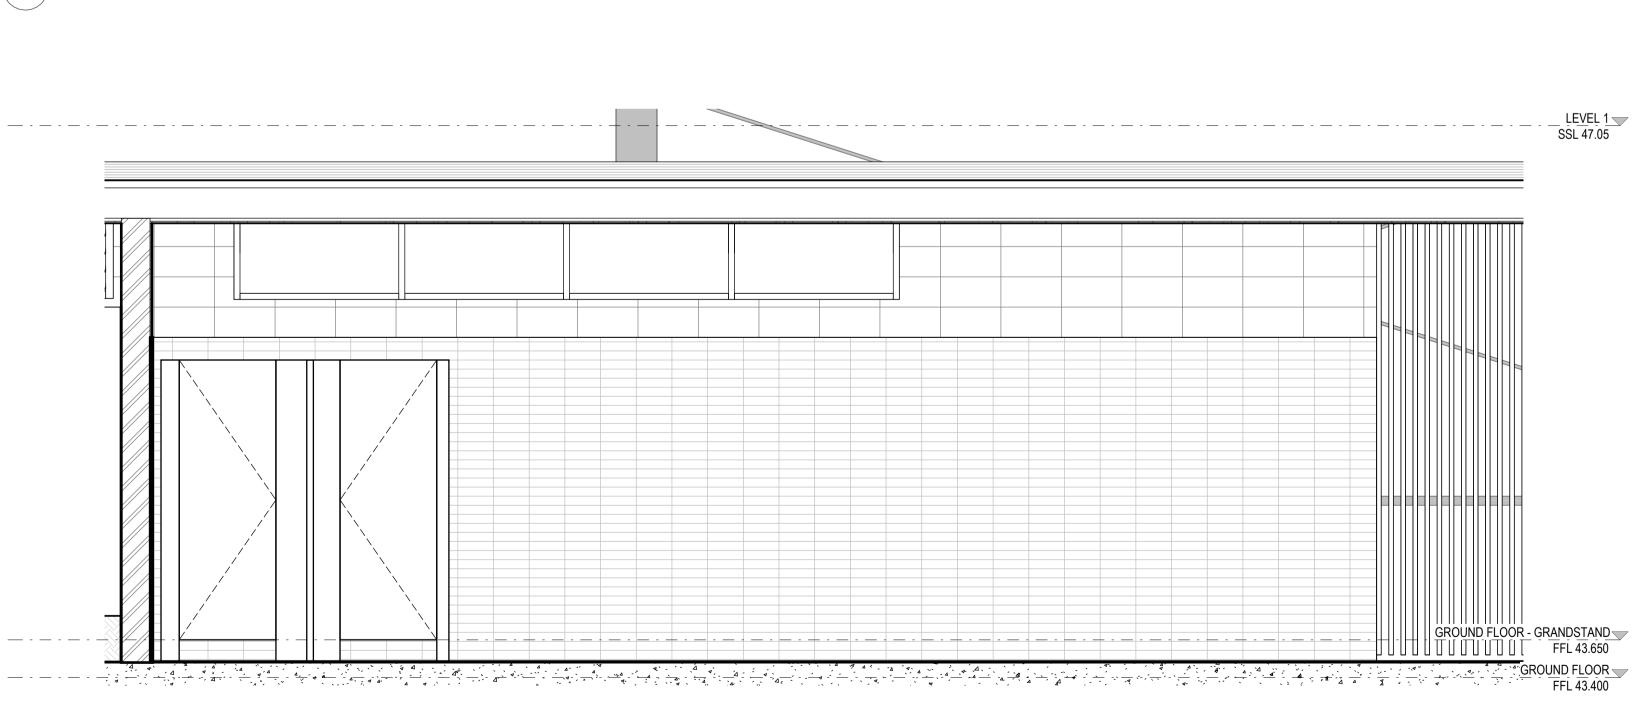
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SCALES 1 : 25 @ A1


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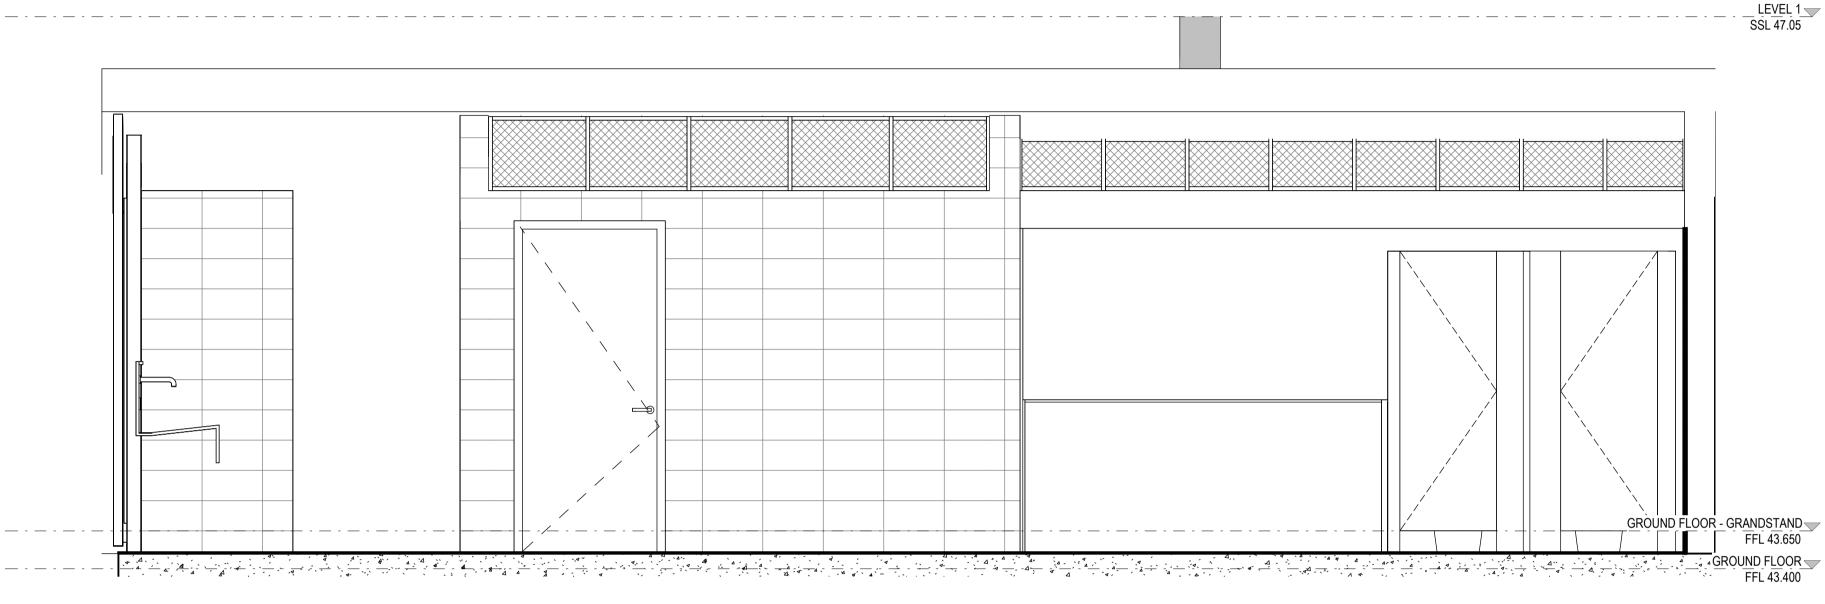
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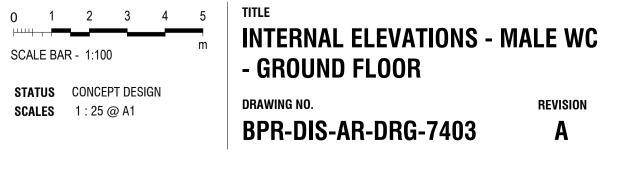



**5** MALE WC - ELEVATION 4




### **3** MALE WC - ELEVATION 2



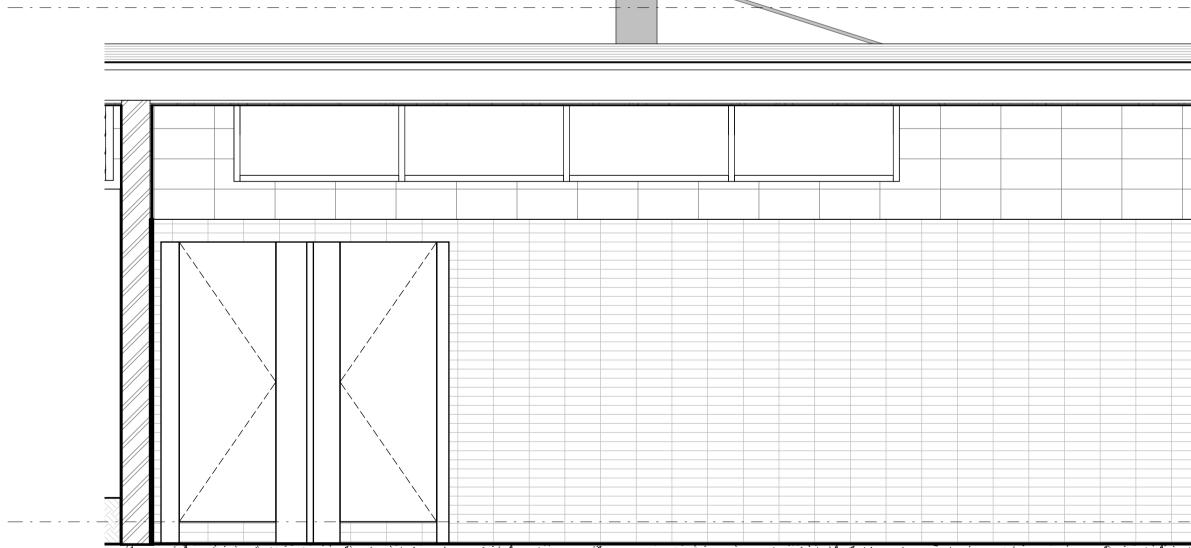

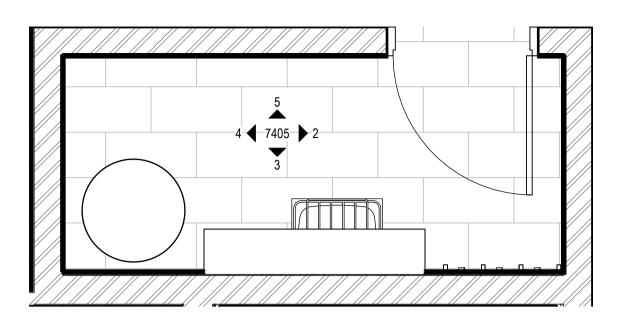

1 CLEANER'S ROOM - DETAIL PLAN SCALE 1:25

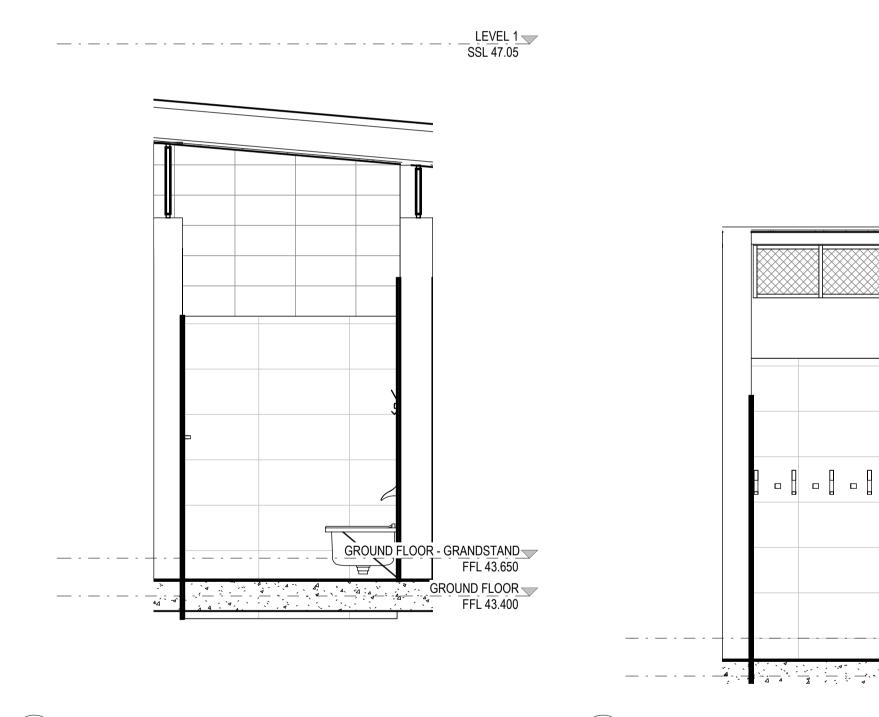

**2** CLEANERS ROOM - ELEVATION 1

CLEANERS ROOM ELEVATION 2 3



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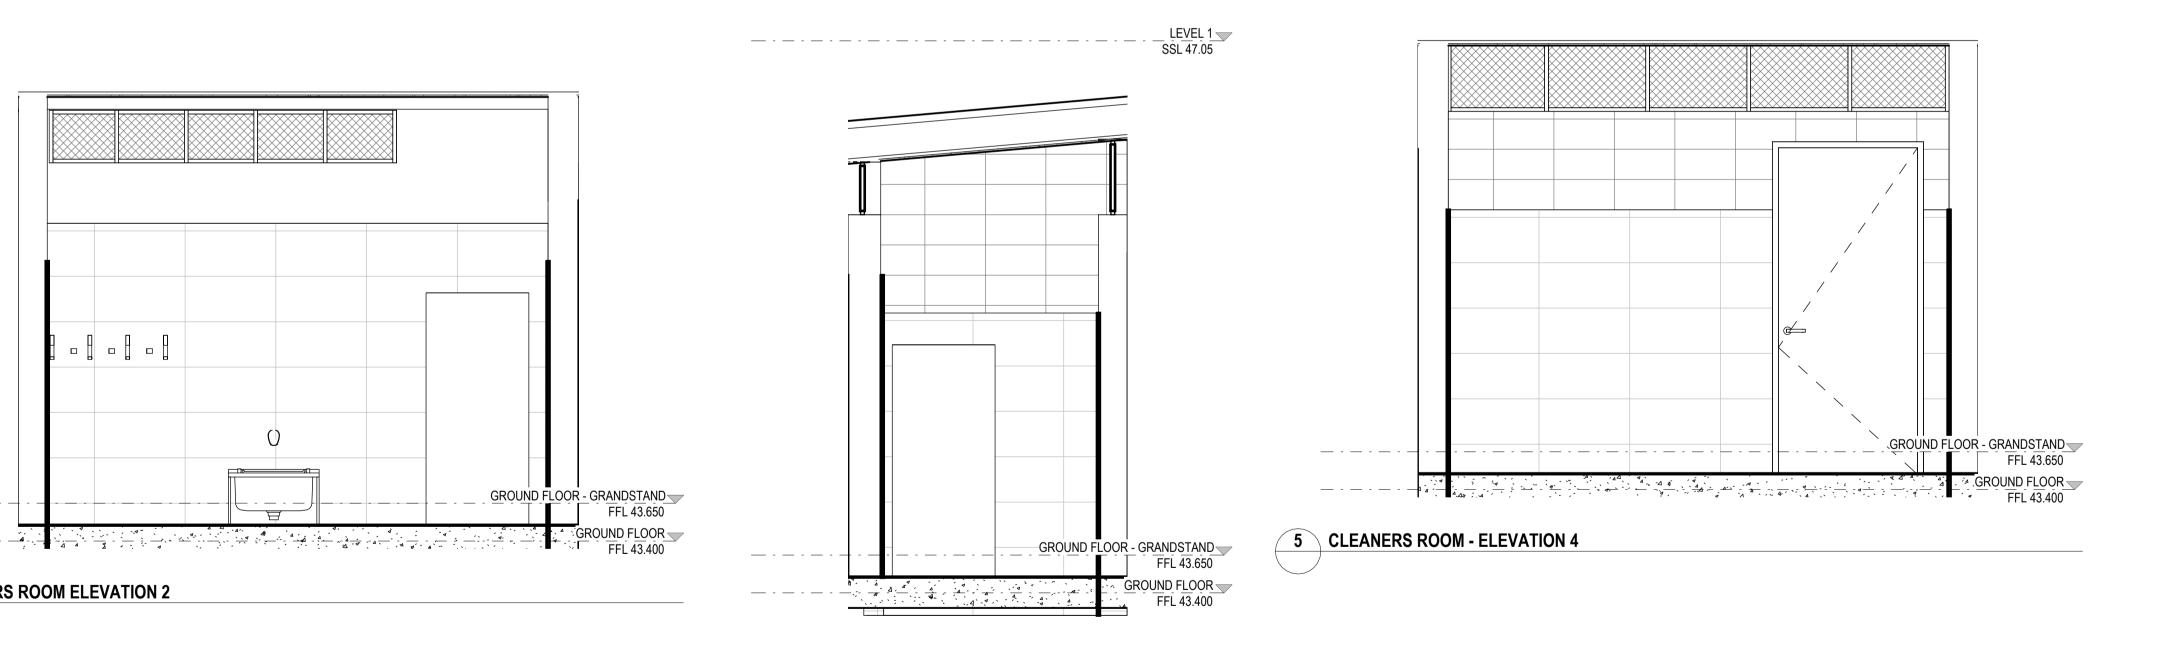
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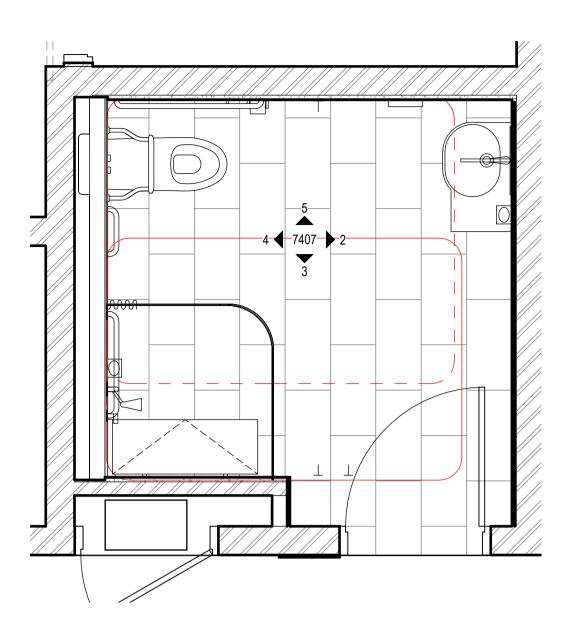
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TITLE **INTERNAL ELEVATIONS -CLEANERS ROOM** DRAWING NO. **BPR-DIS-AR-DRG-7405** 

REVISION Α

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SCALES 1 : 25 @ A1



1 ACCESSIBLE WC AND SHOWER - DETAIL PLAN SCALE 1:25



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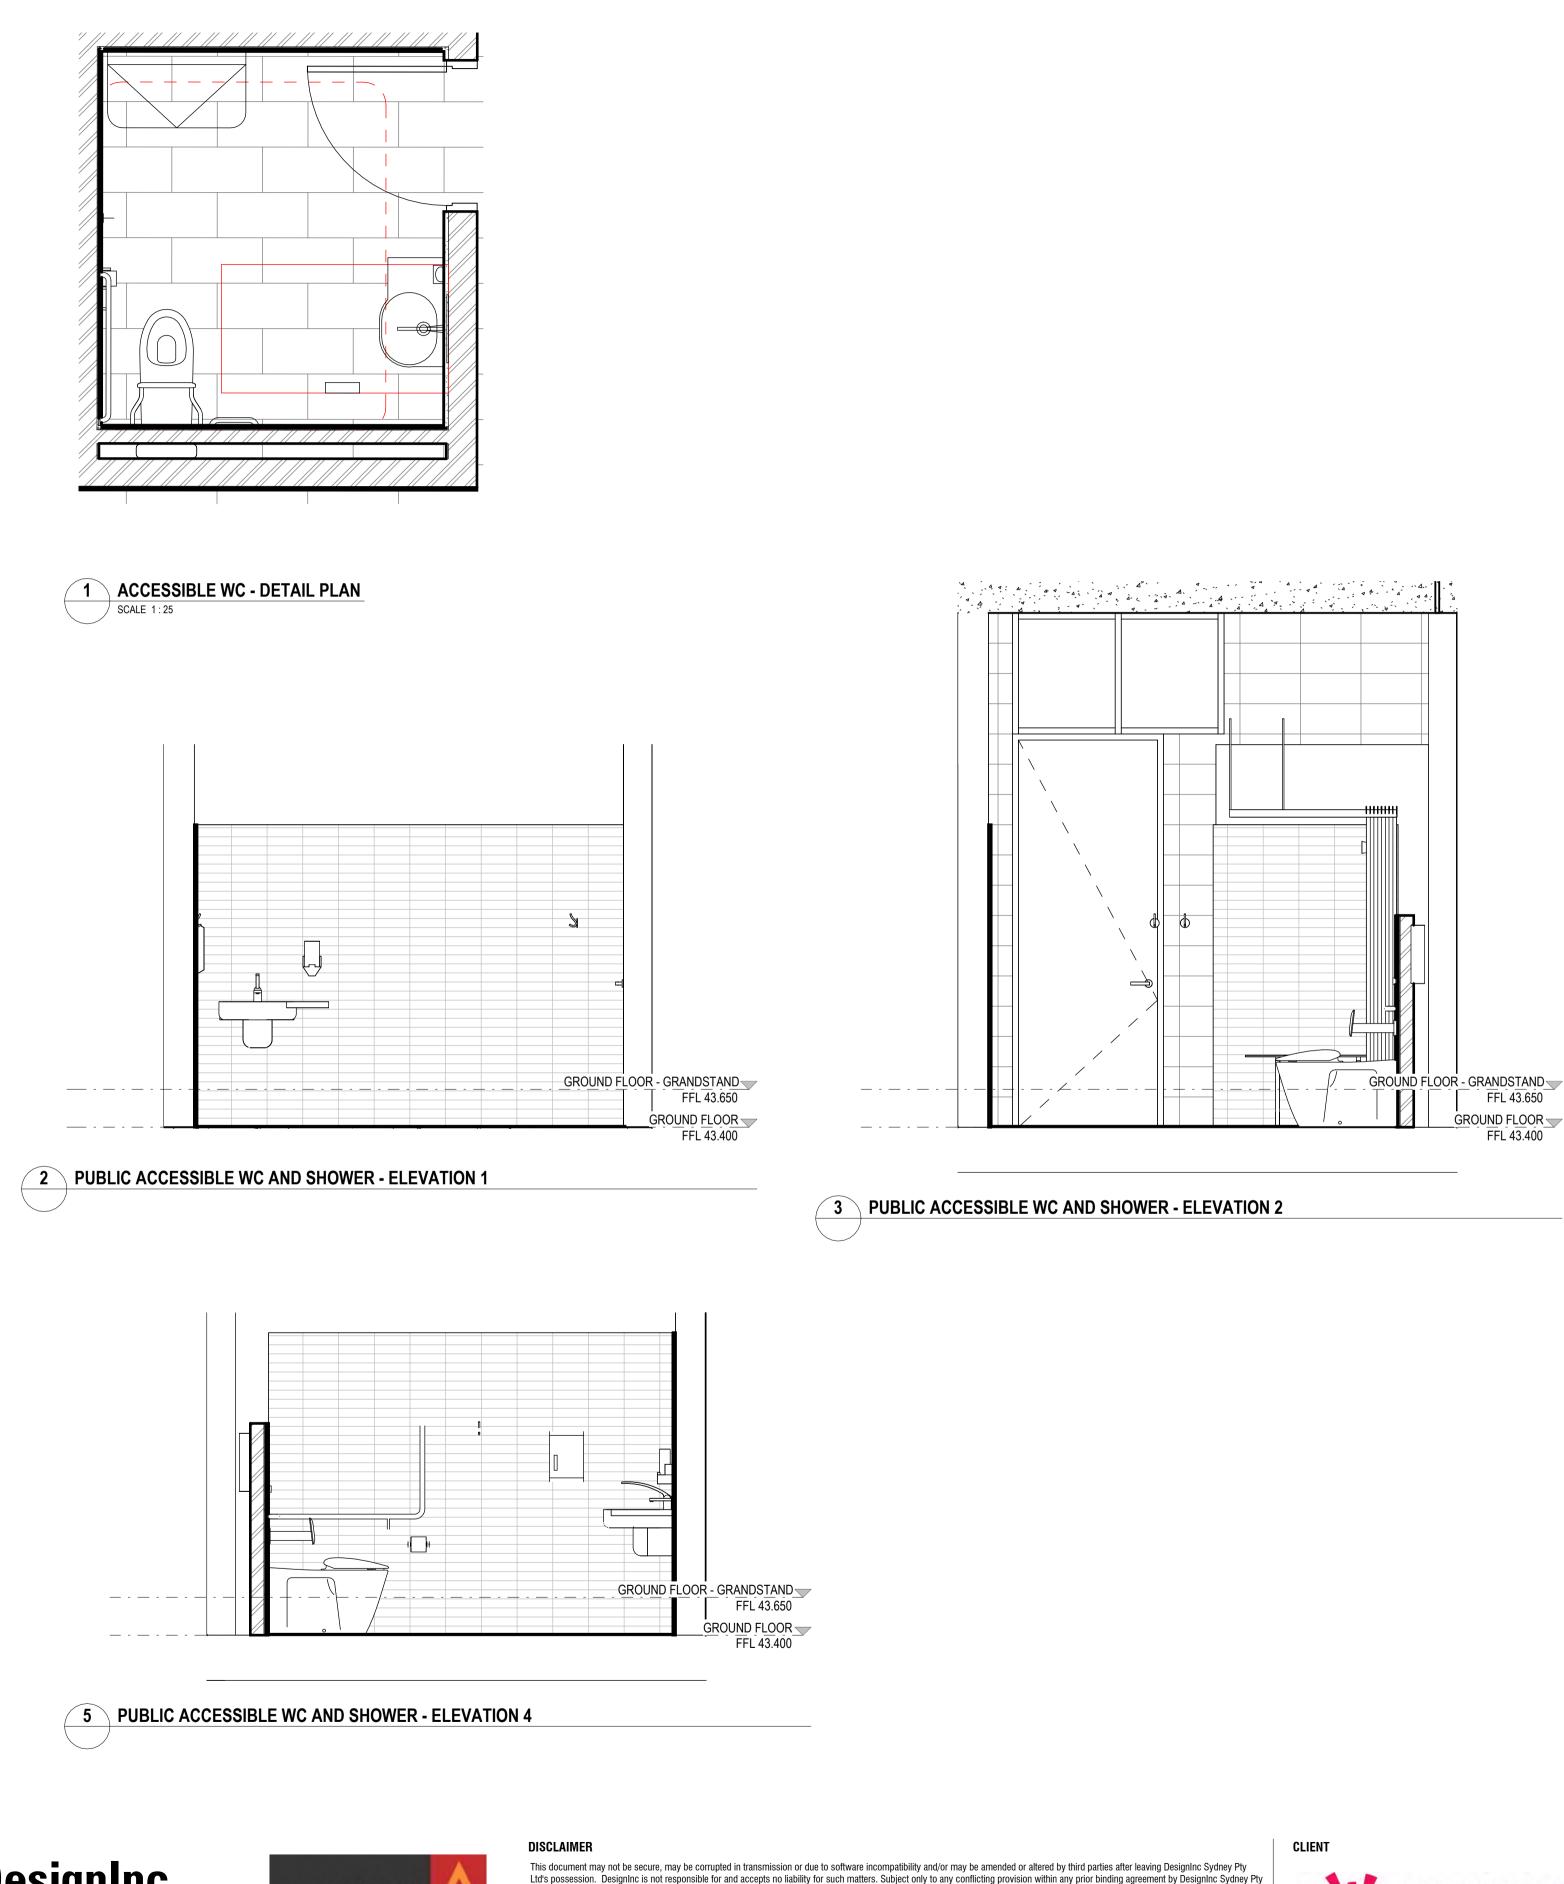
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**INTERNAL ELEVATIONS - PUBLIC** ACCESSIBLE WC AND SHOWER DRAWING NO. REVISION

**BPR-DIS-AR-DRG-7406** 

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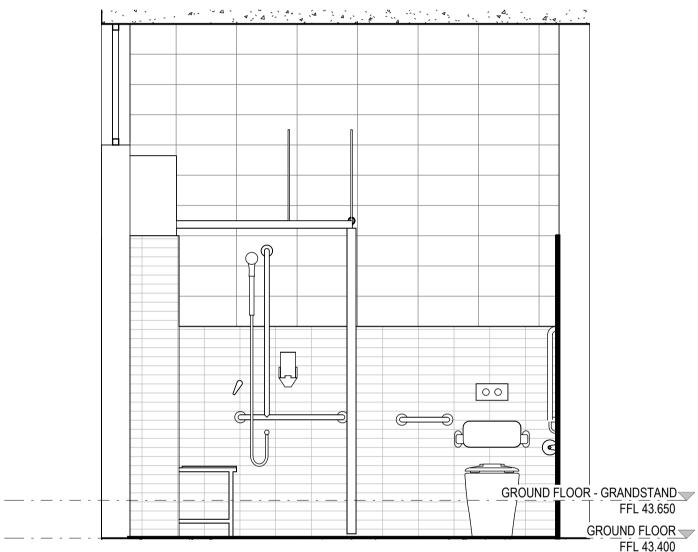
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**4** PUBLIC ACCESSIBLE WC AND SHOWER - ELEVATION 3



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### WORK-IN-PROGRESS



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FFL 43.650 \_\_GROUND FLOOR FFL 43.400

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TITLE **INTERNAL WET AREA ELEVATIONS** - ACCESSIBLE WC - GROUND Filoor. REVISION **BPR-DIS-AR-DRG-7407** 

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Nominated Architects

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CLUB HOUSE BAR ISLAND PLAN

2 CLUB HOUSE BAR ISLAND ELEVATION 1

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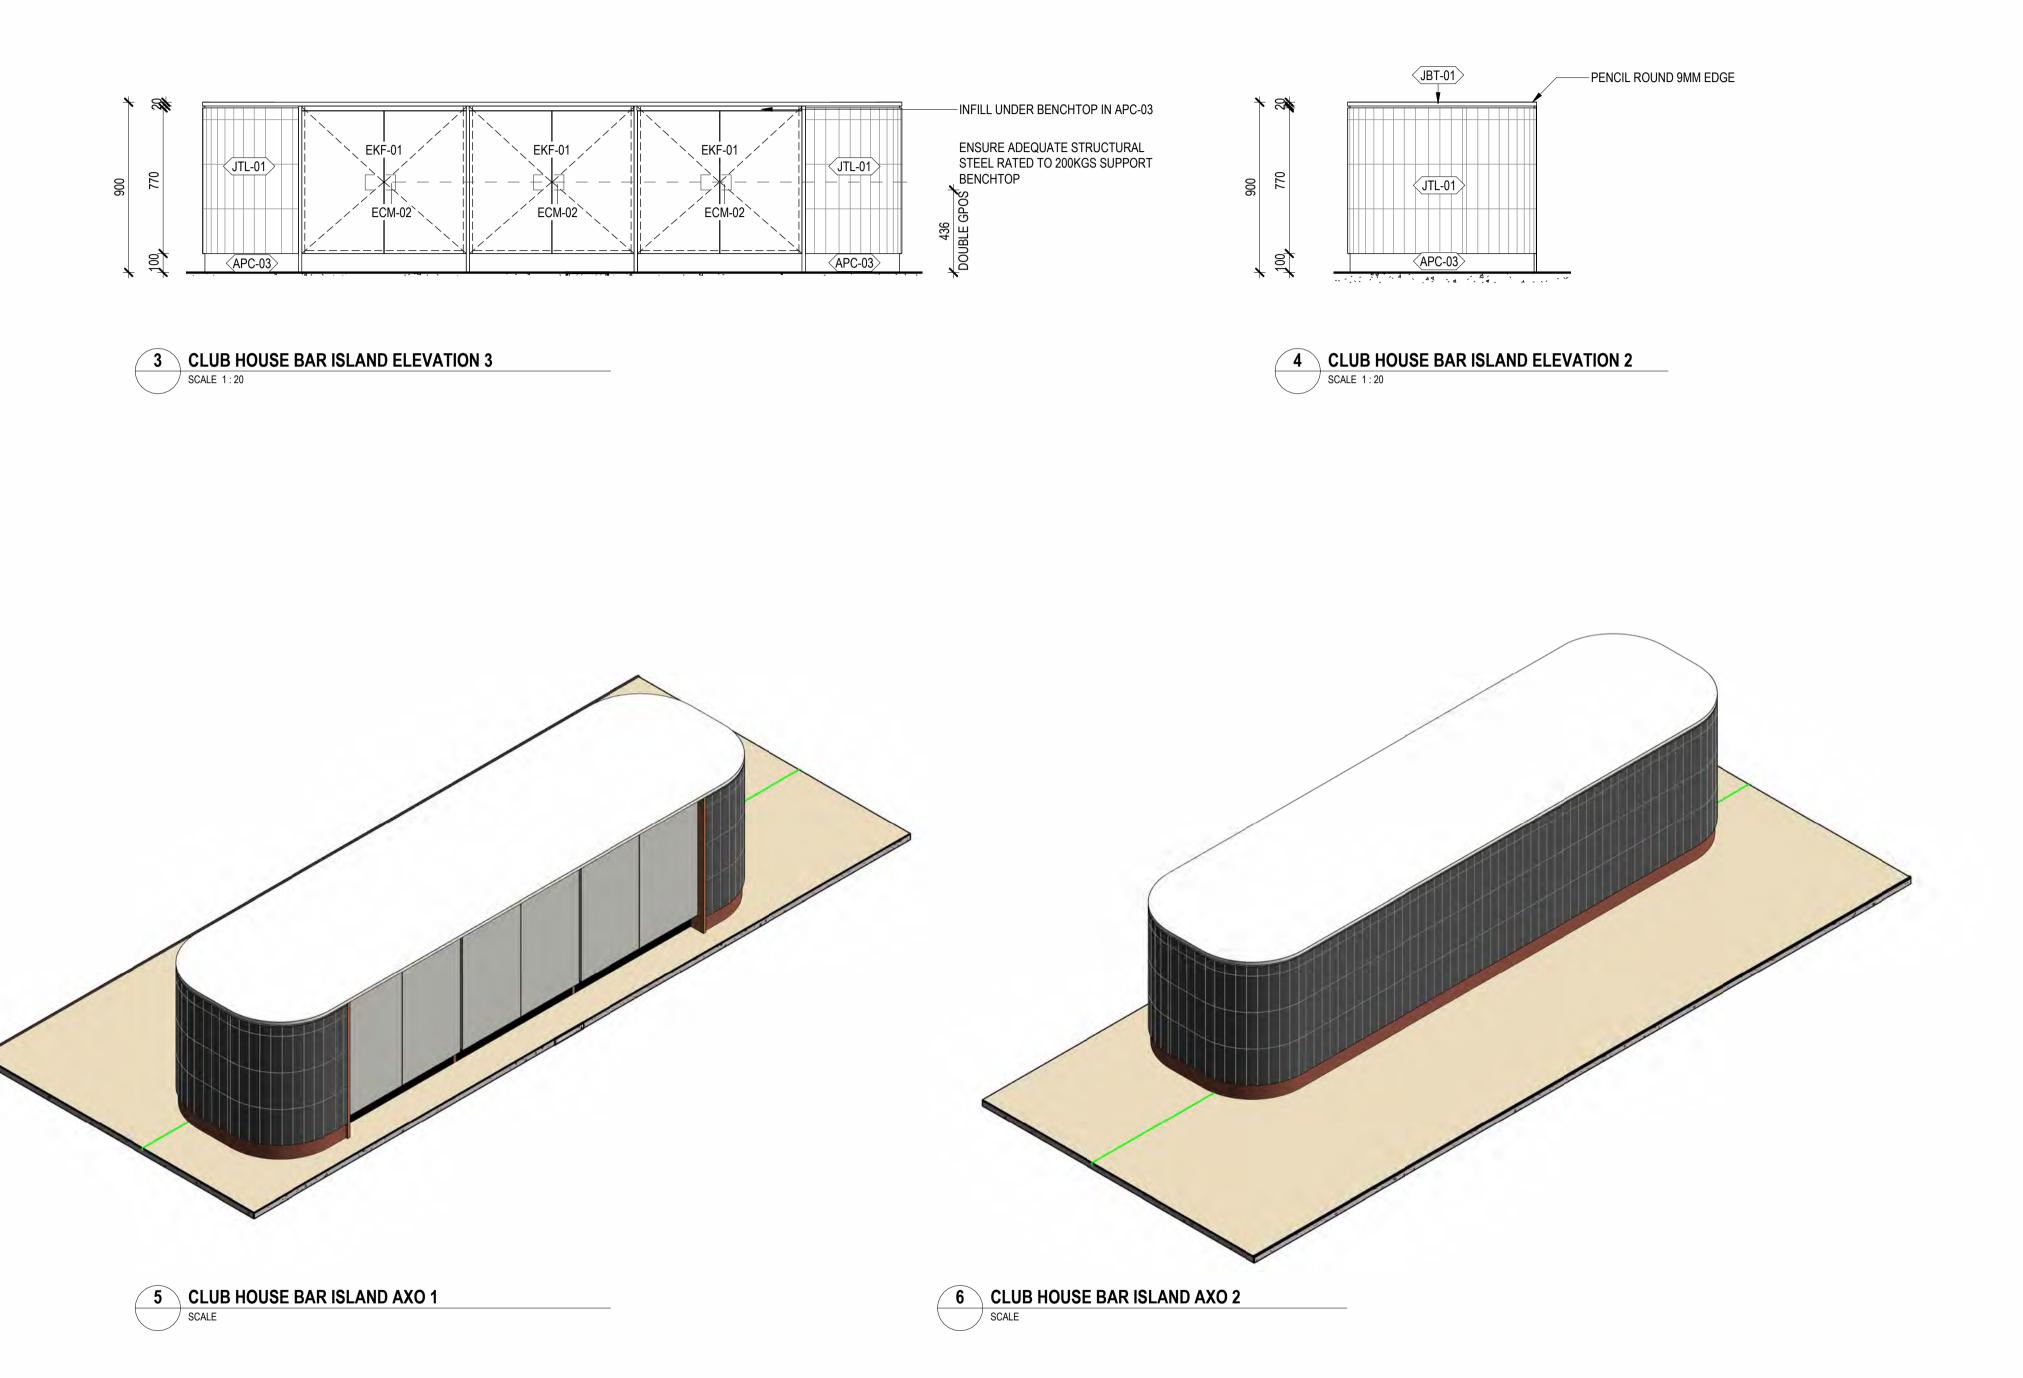
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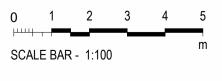
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TITLE **JOINERY PLANS & AXO - J.01 CLUB HOUSE BAR ISLAND** DRAWING NO.

**BPR-DIS-AR-DRG-7501** 

REVISION Α






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STATUS CONCEPT DESIGN

**SCALES** 1 : 10 @ A1

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TITLE **INTERNAL DESIGN DETAILS -**SHEET 1


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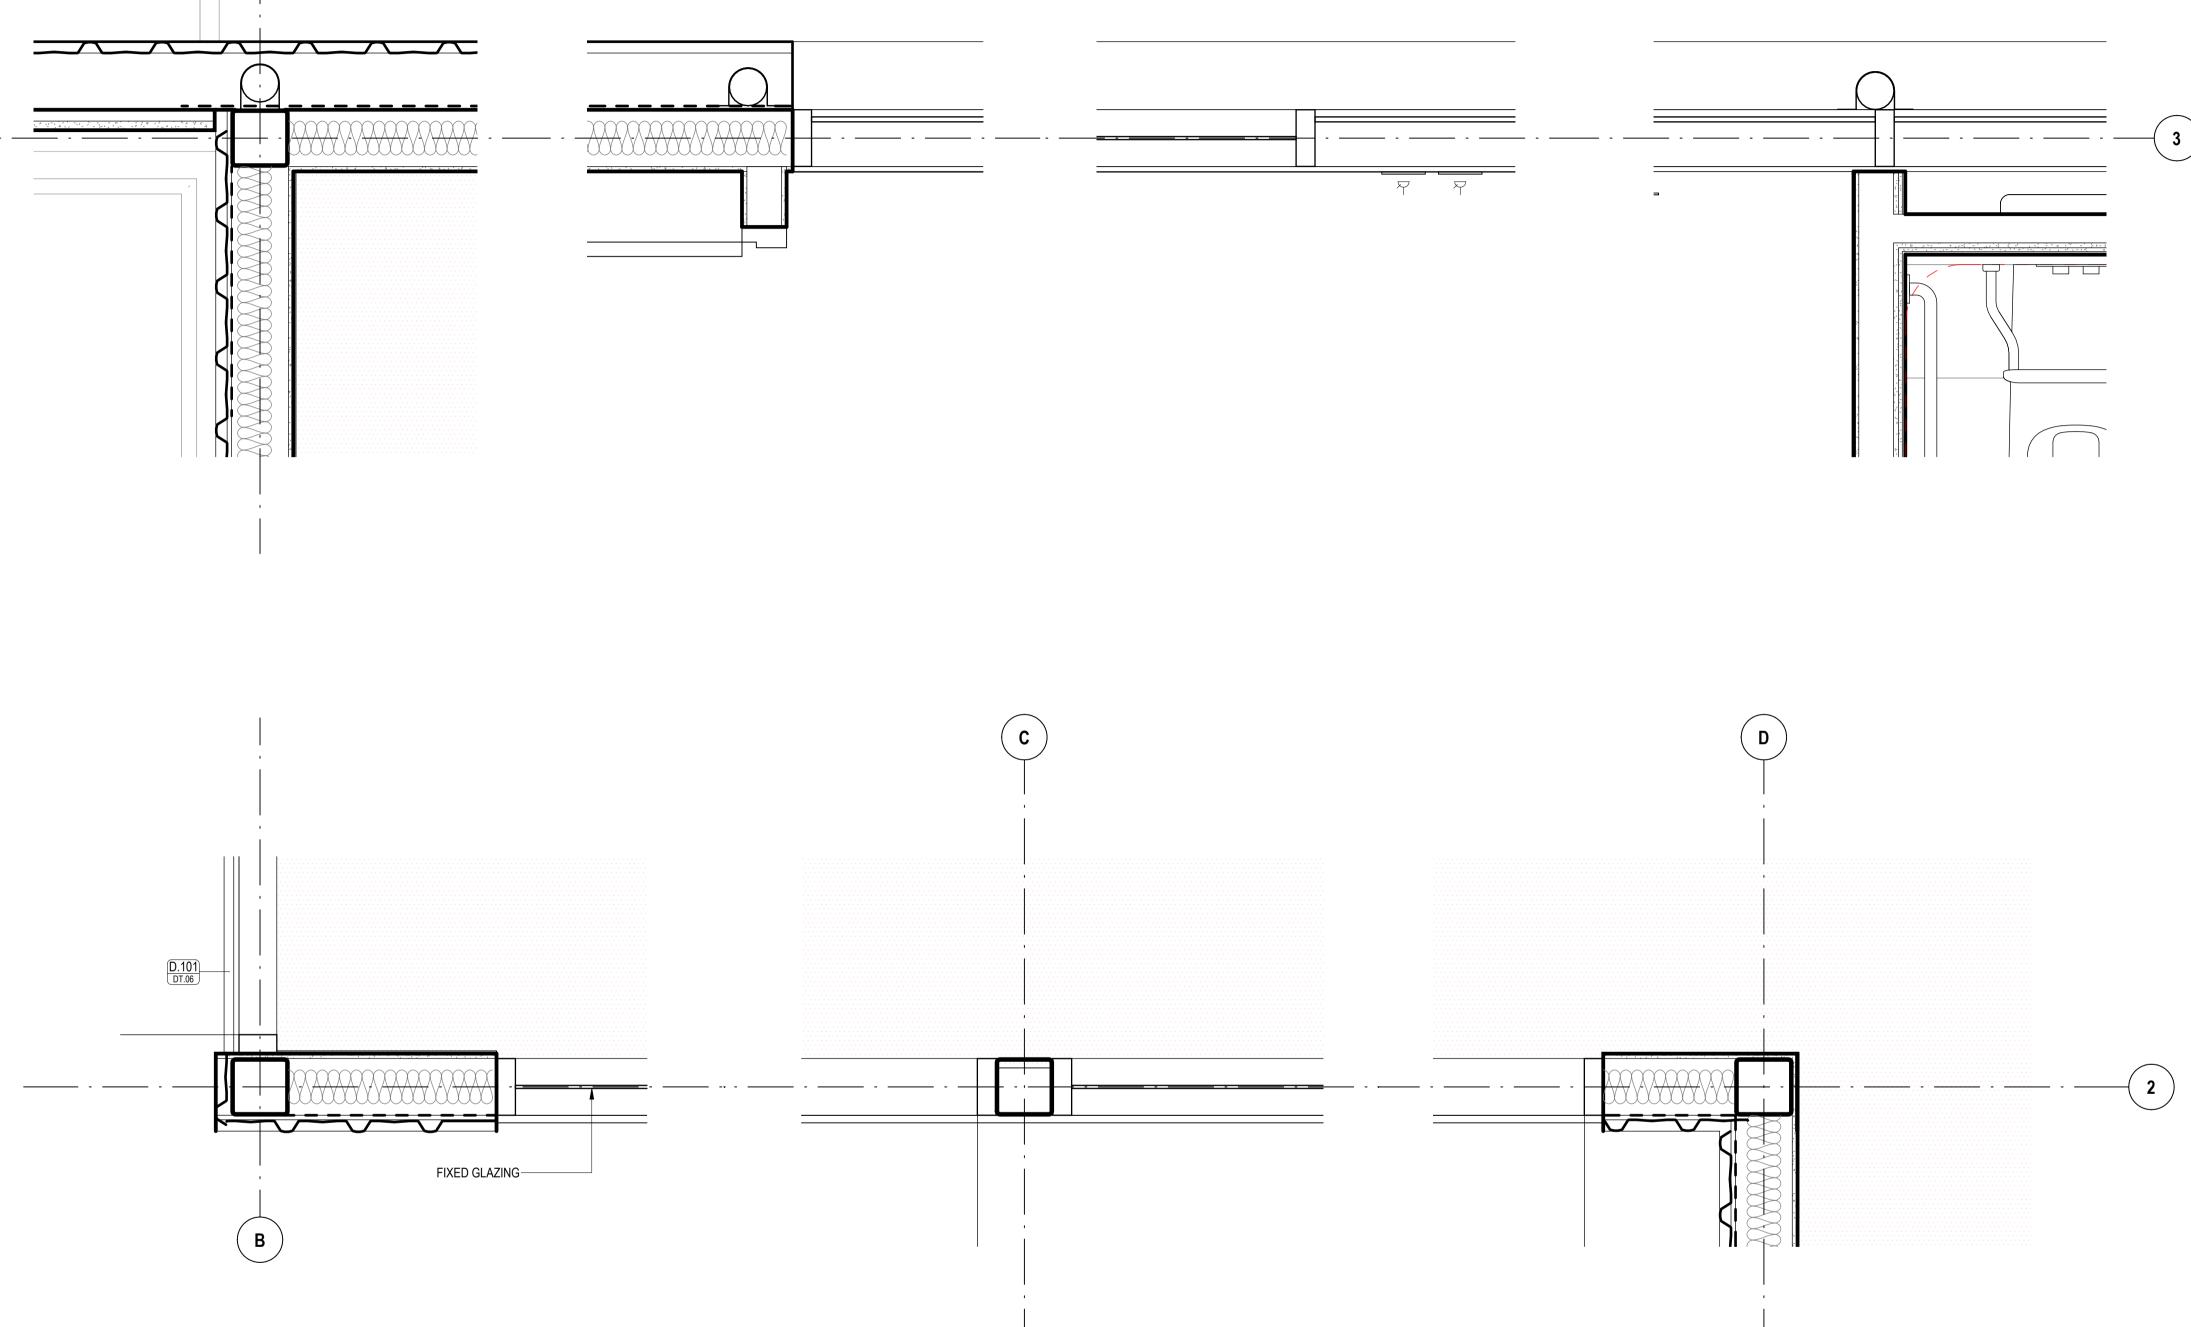
REVISION

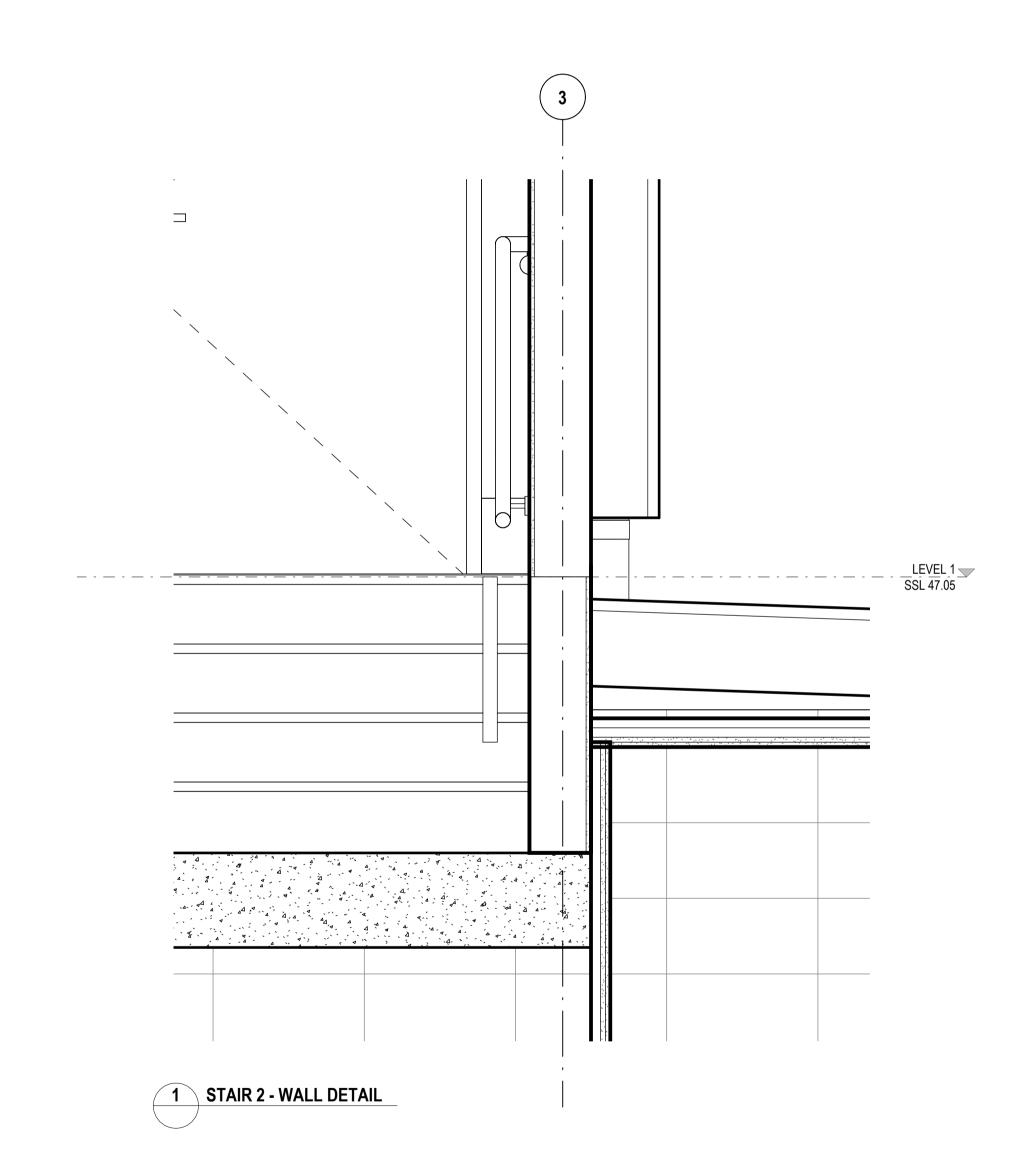A

DRAWING NO.

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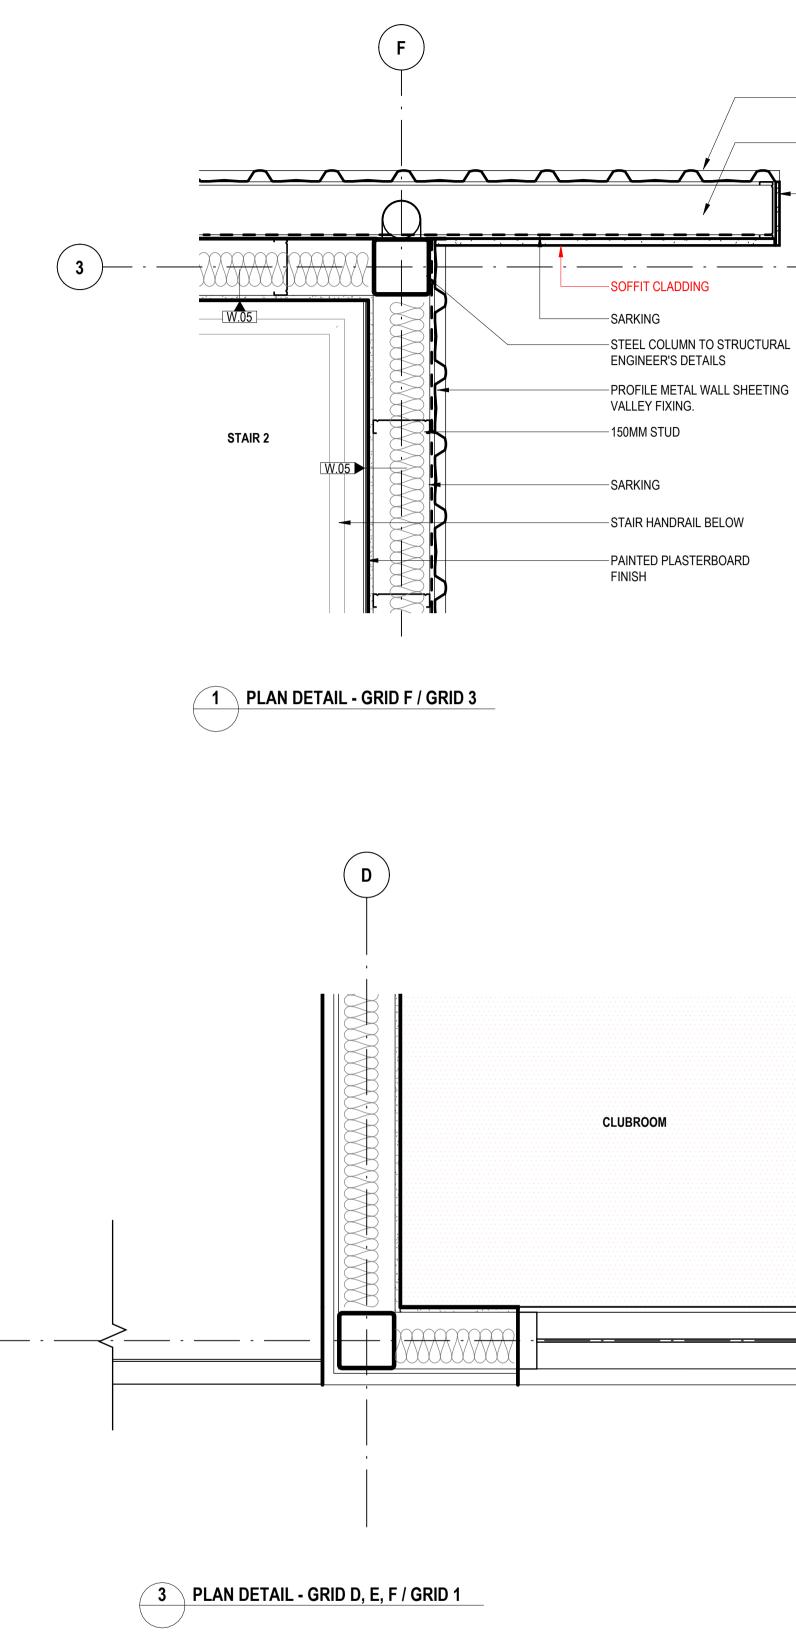
0 1 2 3 4 5 SCALE BAR - 1:100 STATUS CONCEPT DESIGN

**SCALES** 1 : 10 @ A1

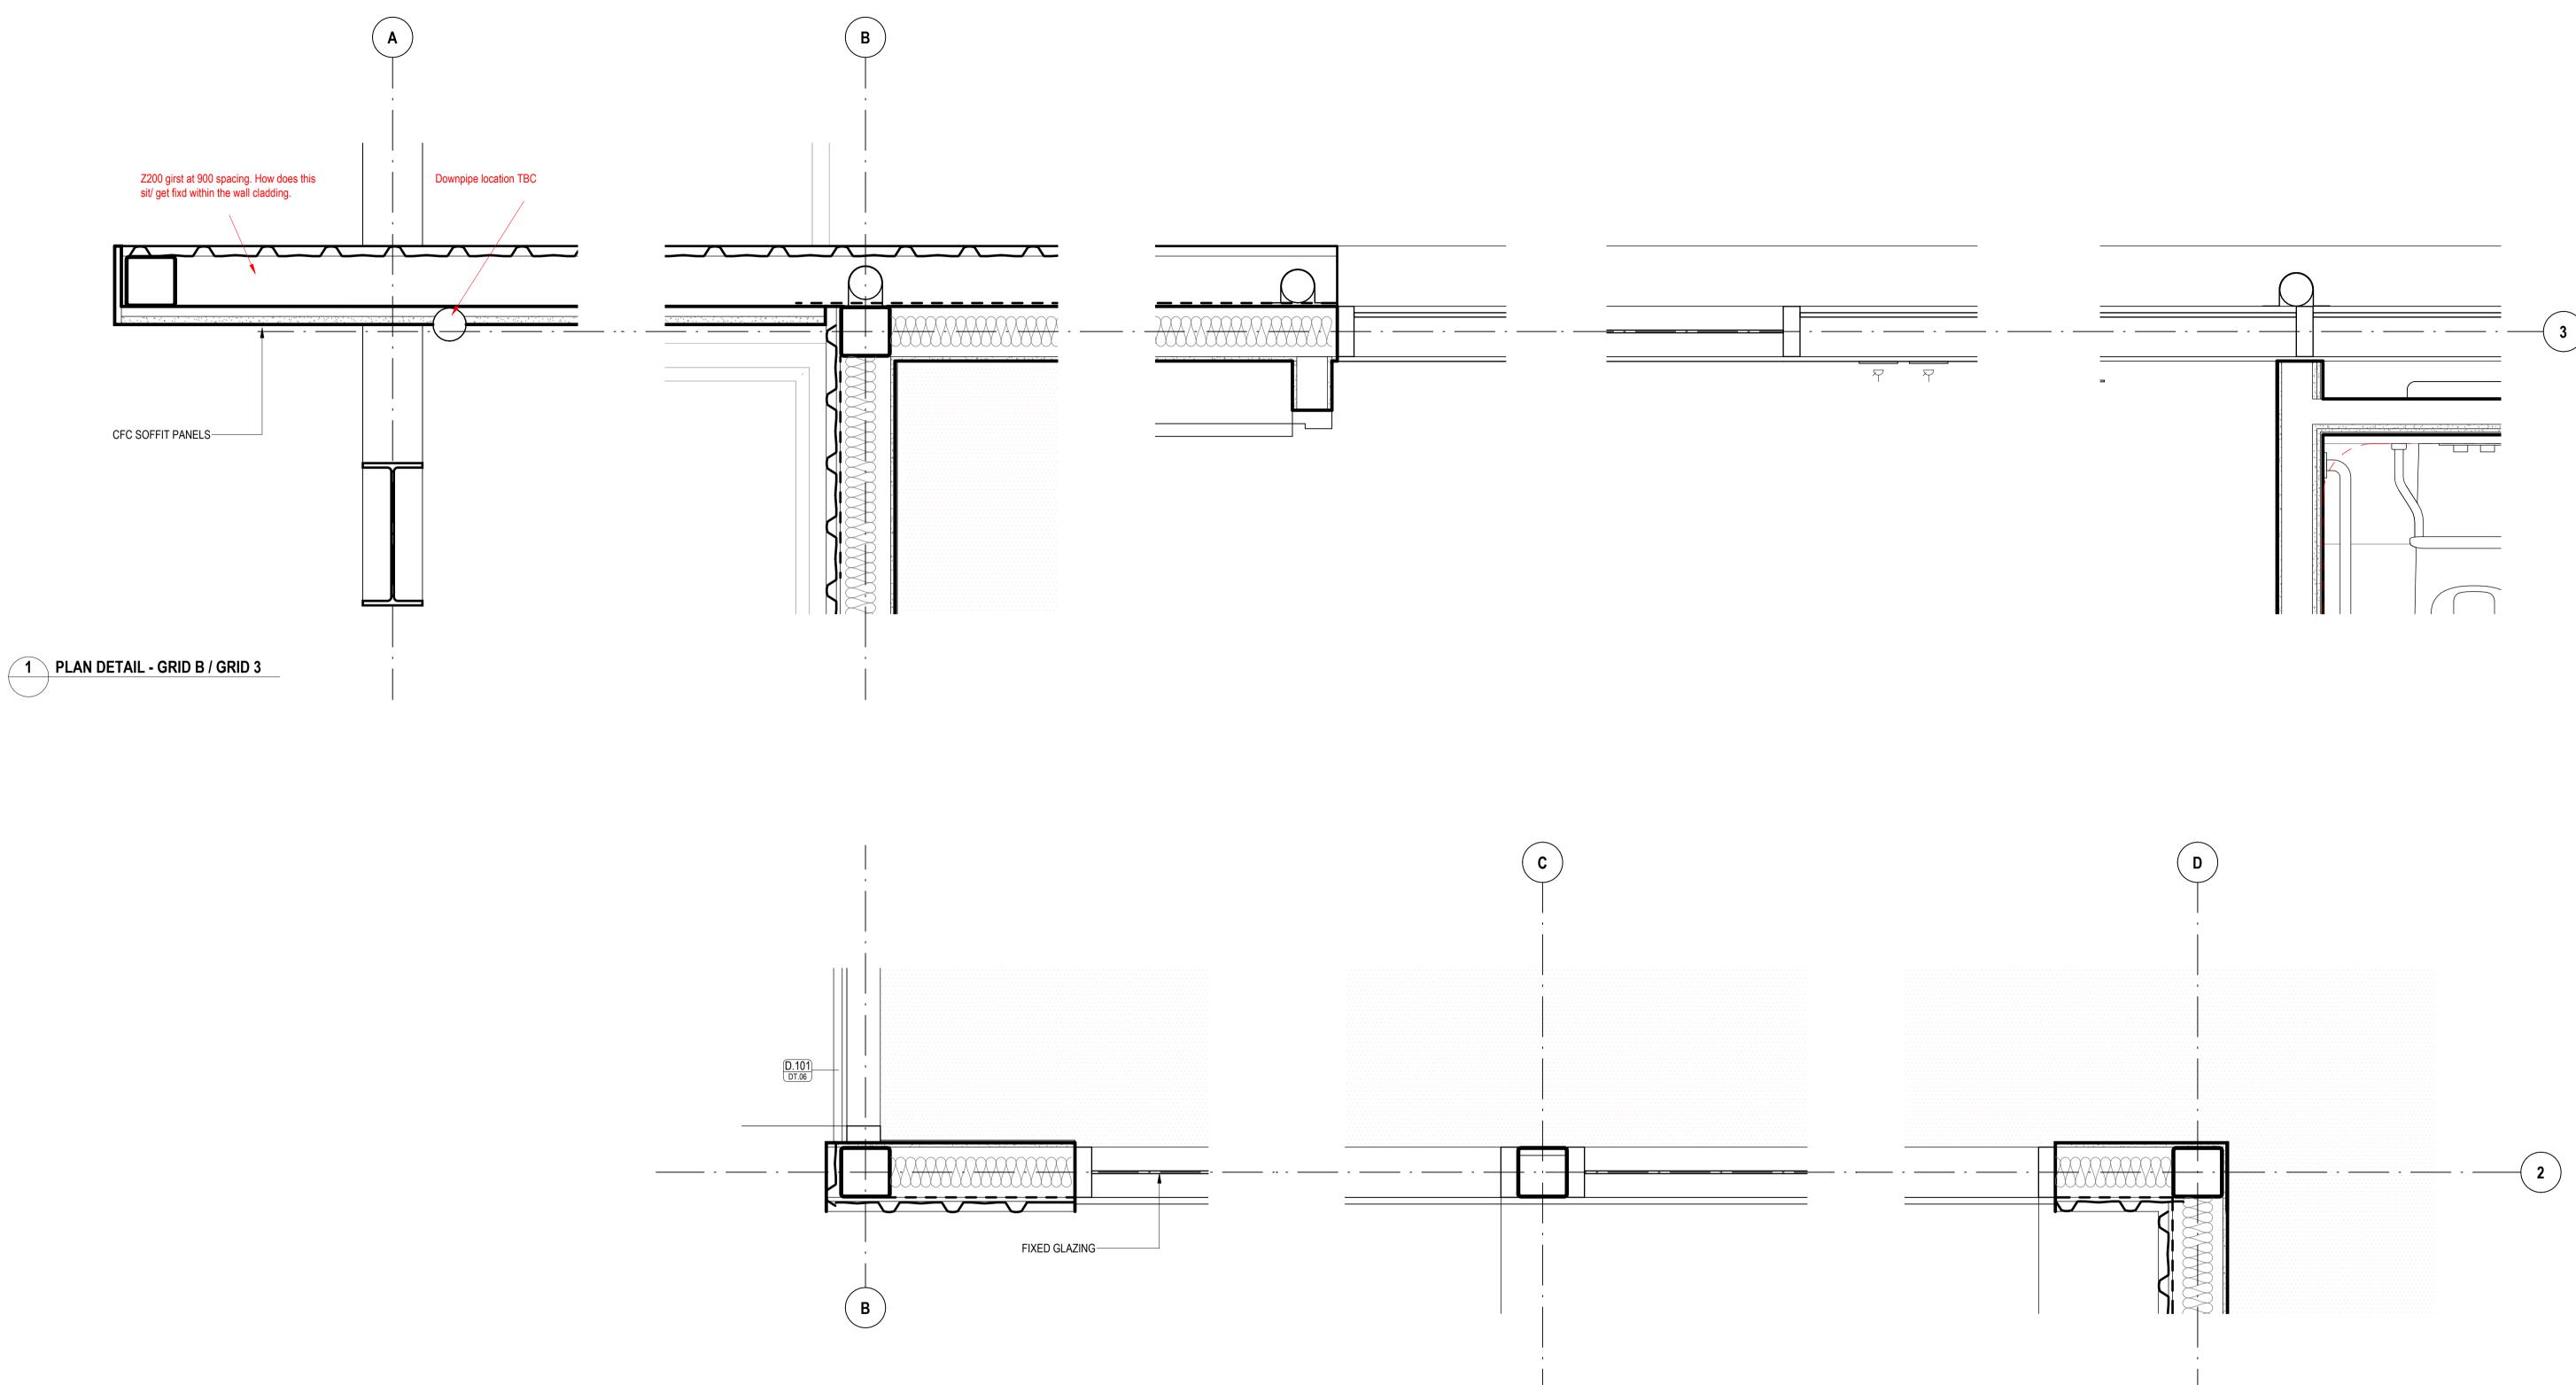DRAWING NO. **BPR-DIS-AR-DRG-8000** 



TITLE **PLAN DETAILS - SHEET** 







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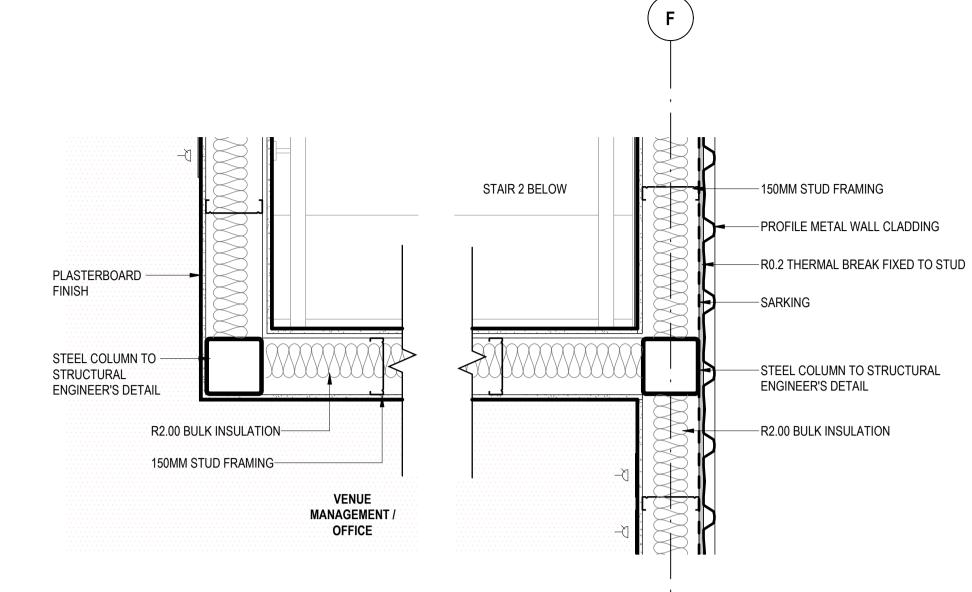
Gadigal Country Level 12, 126 Phillip Street, Sydney NSW 2000 +61 2 8905 7100 Reception@sydney.designinc.com.au Nominated Architects lan Armstrong 7260 Cathryn Drew-Bredin 7269 Cameron Martin 9194 Mary Anne McGirr 10946 PLOTTED : 9/12/2024 12:50:27 PM Autodesk Docs://P24-100 Bob Prenter Reserve Macquarie Fields/P24-100-AR-Bob Prenter Reserve Macquarie Fields.nvt




-PROFILE METAL WALL SHEETING

-150MM STUD LAYER TO SUPPORT WALL CLADDING

-COLORBOND METAL FASCIA. COLOUR TO MATCH WALL SHEETING (DUNE)





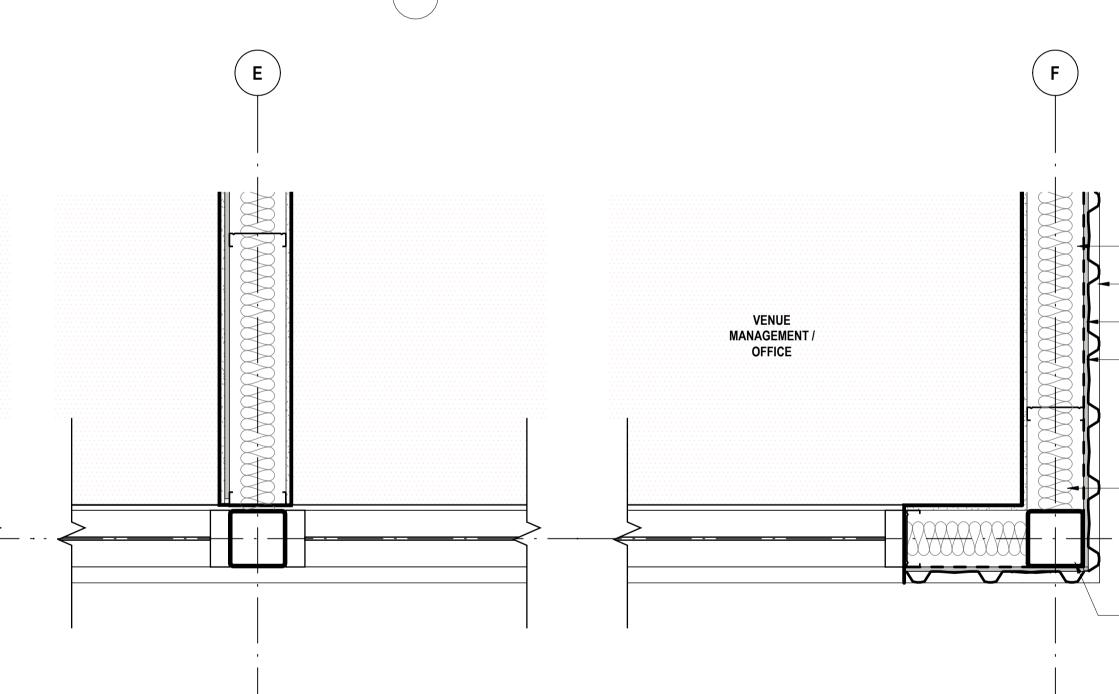



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PROJECT ADDRESS Fields Rd, Macquarie Fields NSW 2564

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DRAWING NO. **BPR-DIS-AR-DRG-8001**  REVISION Α

0 1 2 3 4 5 ┝┘┘┘┤╶╴┍╾╍┓ SCALE BAR - 1:100

STATUS CONCEPT DESIGN

TITLE PLAN DETAILS - SHEET 2

NOT FOR CONSTRUCTION DRAWING TO BE PRINTED IN COLOUR

-150MM STUD FRAMING

-R2.00 BULK INSULATION

-STEEL COLUMN TO STRUCTURAL


ENGINEER'S DETAIL

-SARKING

-R0.2 THERMAL BREAK FIXED TO STUD

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SCALES 1 : 10 @ A1



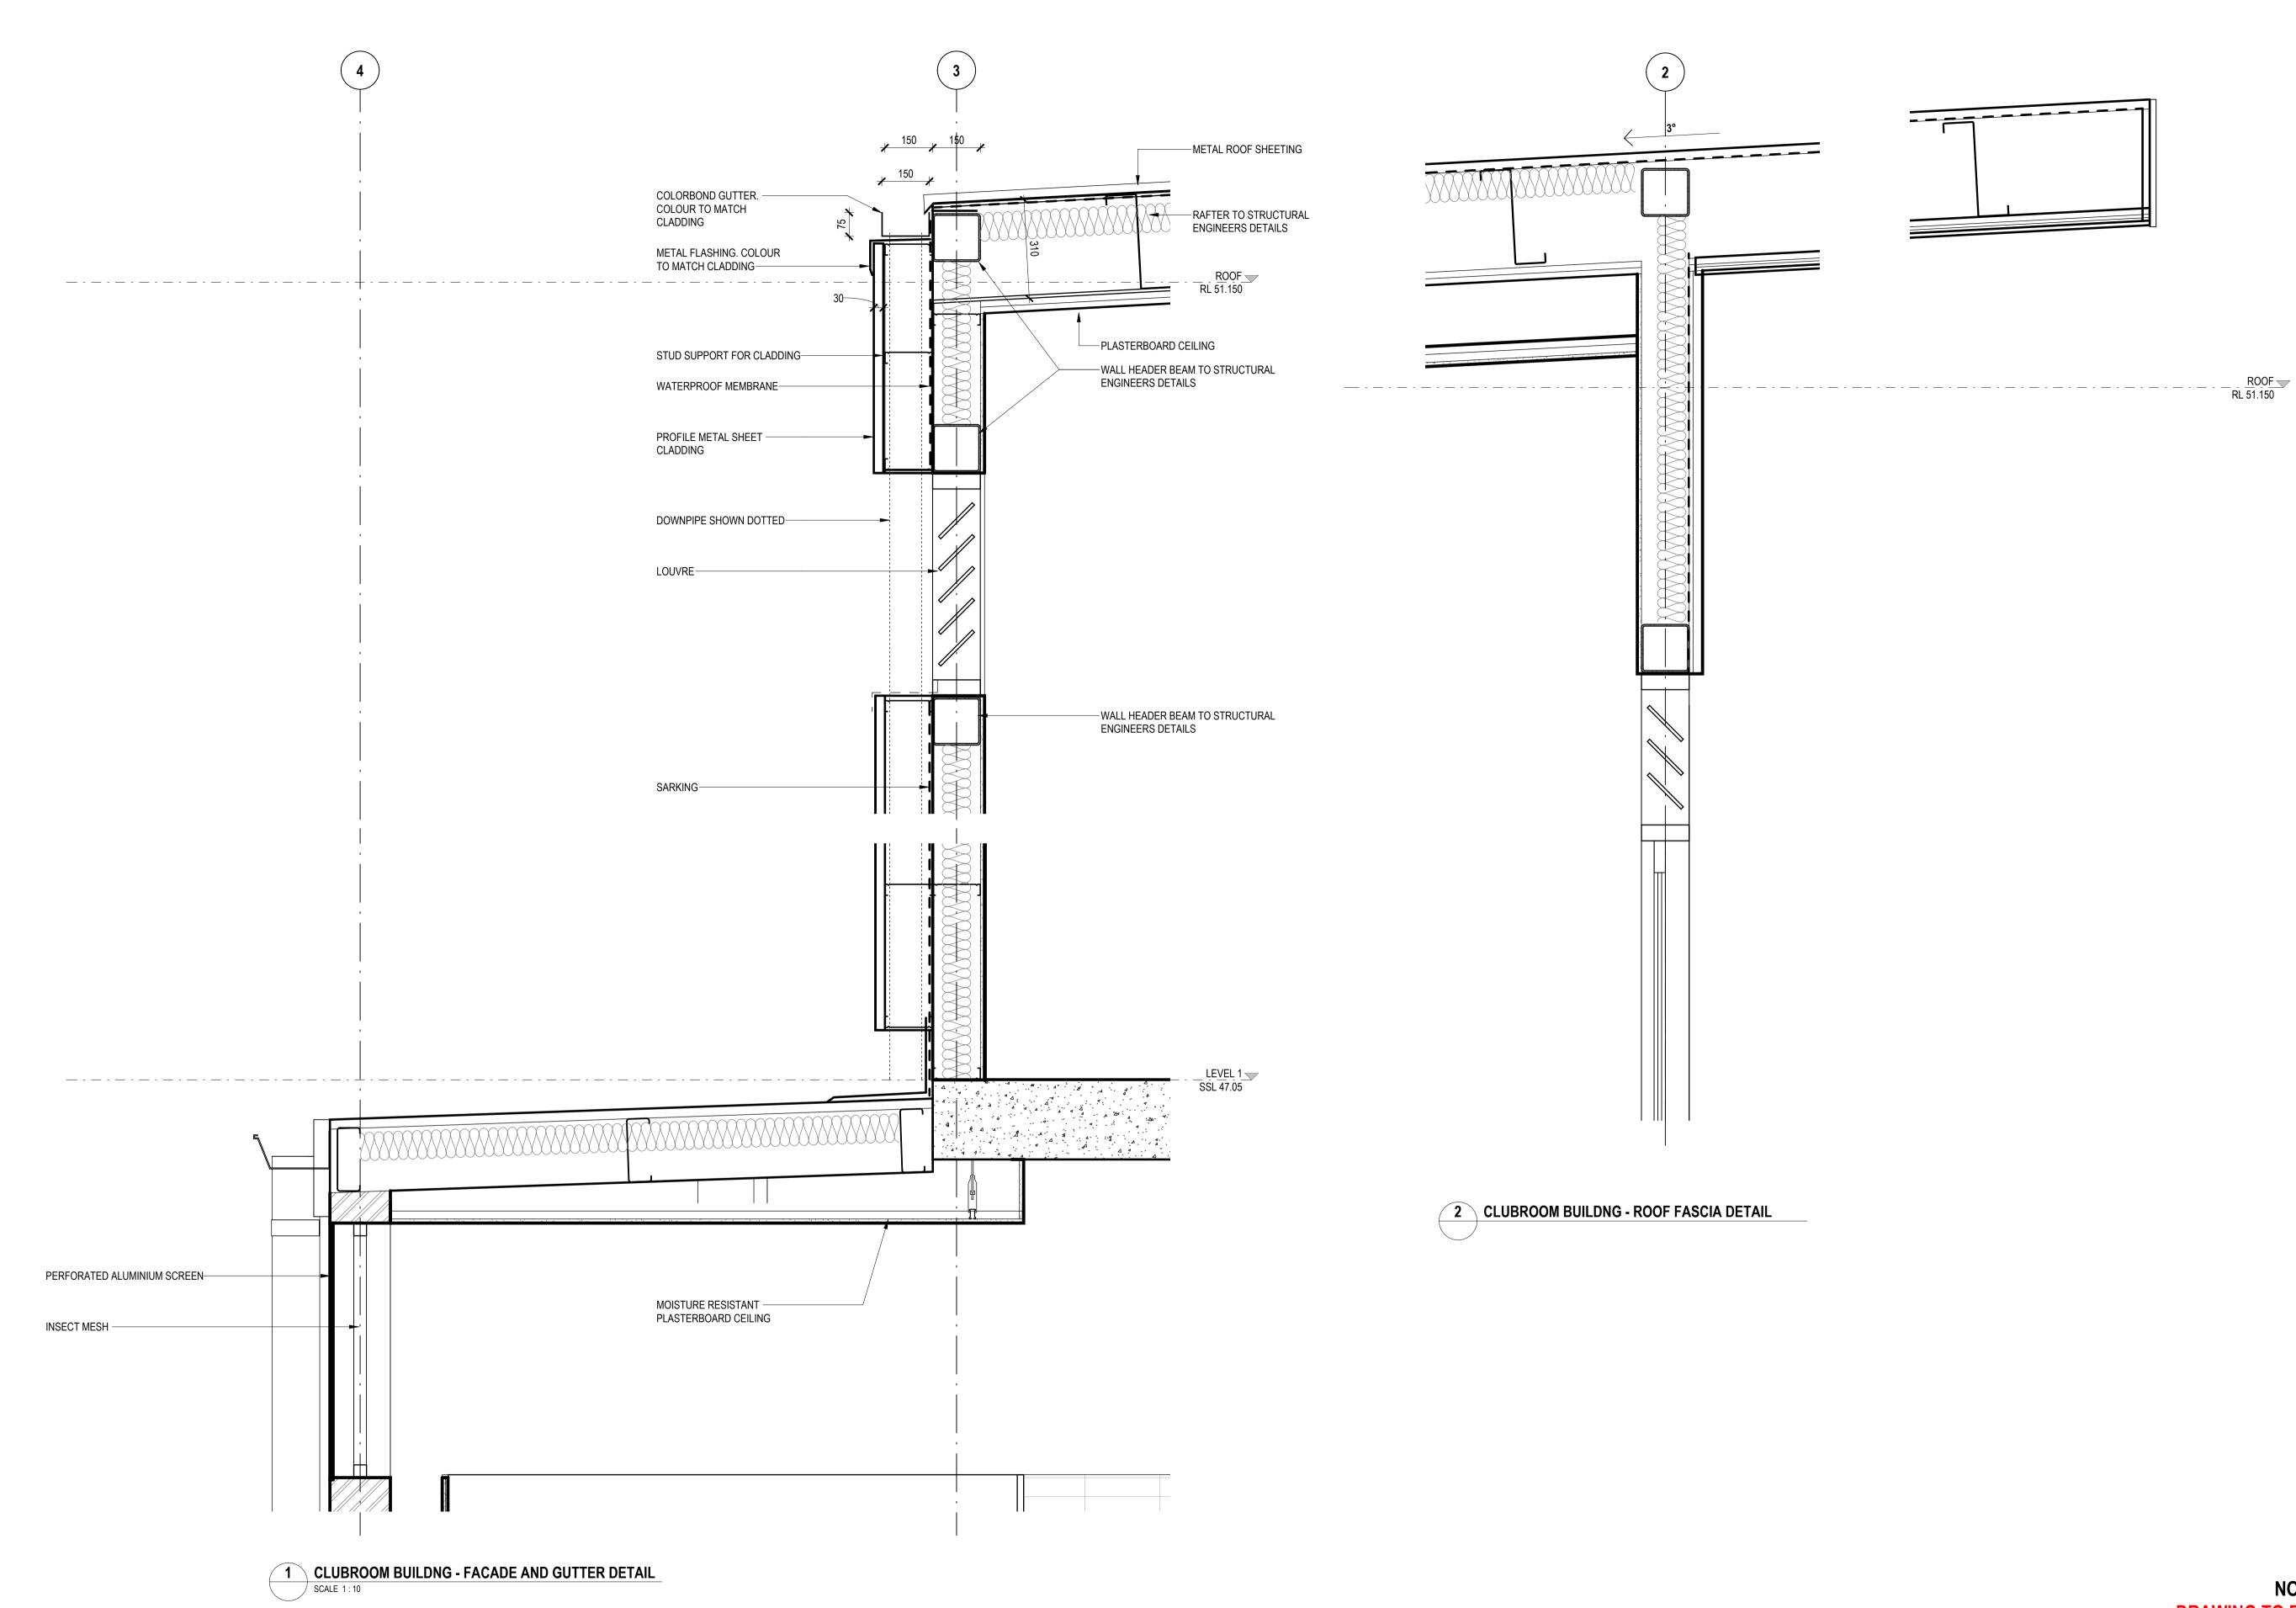



•

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STATUS CONCEPT DESIGN SCALES 1 : 10 @ A1

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TITLE **EXTERNAL DESIGN DETAILS -**SHEET 1 DRAWING NO. BPR-DIS-AR-DRG-8100



DesignInc






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#### 2 CLUBROOM BUILDNG - GROUND FLOOR DOOR THRESHOLD DETAIL SCALE 1:10



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**A** 

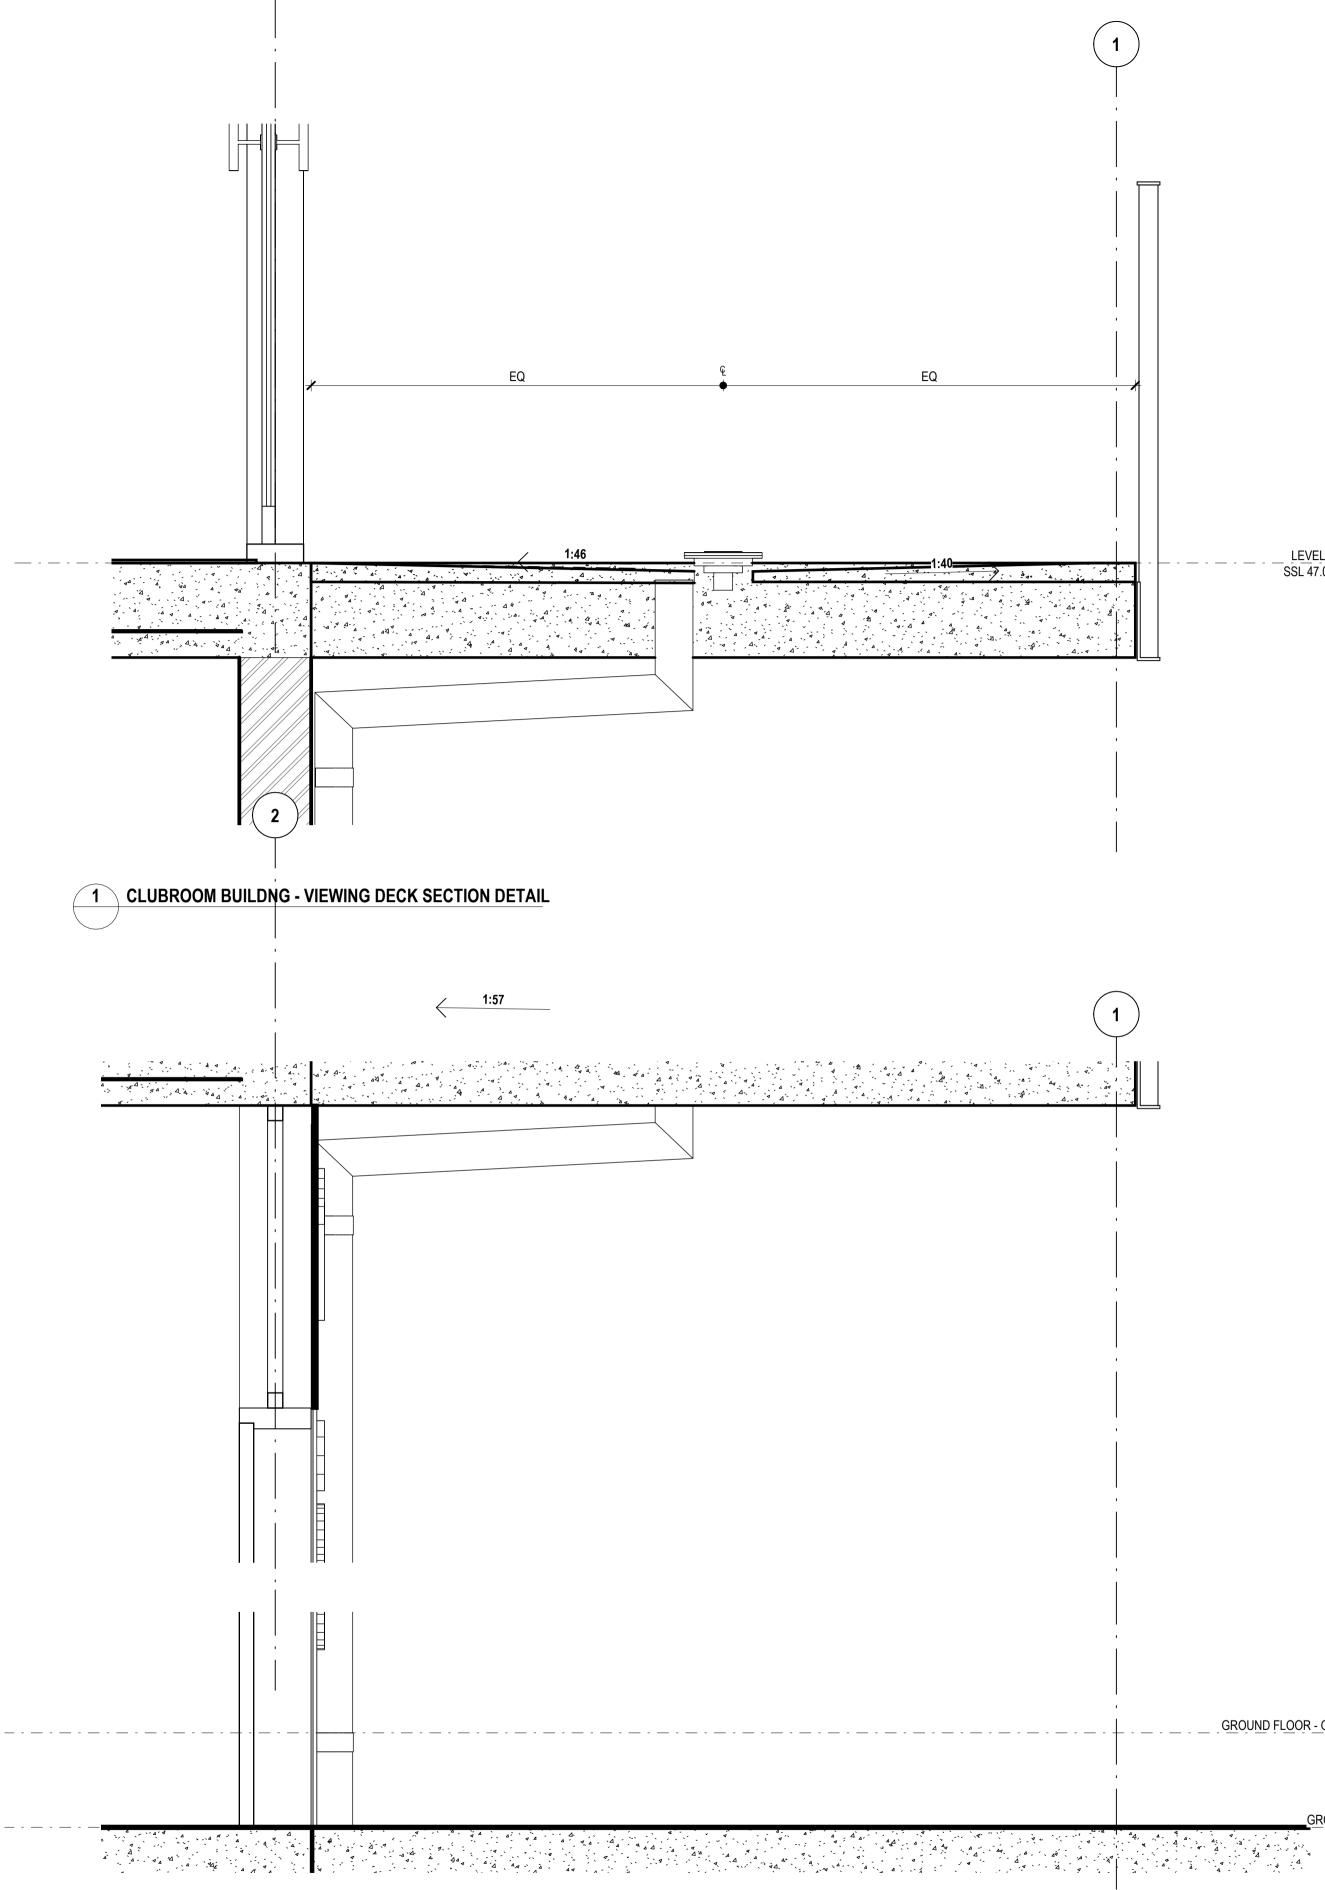0 1 2 3 4 5 ┟╵╵╵╎╴┦╴╴╸ SCALE BAR - 1:100 STATUS CONCEPT DESIGN

SCALES 1 : 10 @ A1

TITLE **EXTERNAL DESIGN DETAILS -**SHEET 2 DRAWING NO. **BPR-DIS-AR-DRG-8101** 

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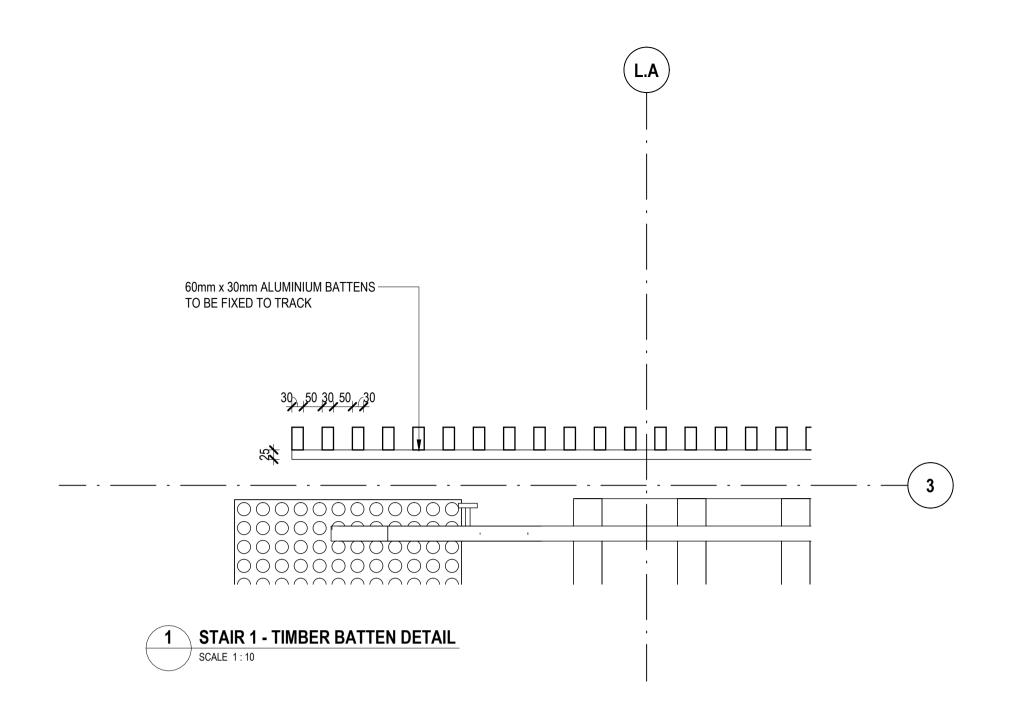
REVISION

Α

FFL 43.400

GROUND FLOOR - GRANDSTAND FFL 43.650

\_\_\_\_LEVEL 1\_\_\_\_\_ SSL 47.05





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STATUS CONCEPT DESIGN

SCALES 1 : 10 @ A1

DRAWING NO. **BPR-DIS-AR-DRG-8400** 

REVISION A

TITLE **METAL WORKS DETAILS** 

												DOOR SCHED	JLE							
						STRUCTUR	AL OPENING	CLEAR (	OPENING	DOOR	LEAF DIMEN	SIONS		FINISHES			DOOR HARD	WARE AND A	CCESSORIE	S
DOOR			DOOR		ACOUSTIC			CLEAR	CLEAR		LEAF	LEAF				DOOR	DOOR	DOOR	DOOR	
NUMBER	FROM ROOM	TO ROOM	TYPE	FIRE RATING	RATING	WIDTH	HEIGHT	WIDTH	HEIGHT	LEAF WIDTH	HEIGHT	THICKNESS	LEAF FINISH 1	LEAF FINISH 2	2 FRAME FINISH	SEALS	STOPS	CLOSER	GRILLES	SEC

GROUND	FLOOR															
001	CANTEEN		RD.01		2750	1100										
002	CANTEEN		RD.01		2170	1100										
003		CANTEEN	DT.01		1000	2600	867	2545	920	2560	38					
004	FHR		DT-10		950	2000	817	1945	870	1960	38					
005		ACC. WC	DT.01		1000	2600	867	2545	920	2560	38					
006		PLAYERS CHANGE RM	DT.01		1200	2600	1067	2545	1120	2560	38					
007		PLAYERS CHANGE RM	DT.01		1200	2600	1067	2545	1120	2560	38					
008		PLAYERS CHANGE RM	DT.01		1200	2600	1067	2545	1120	2560	38					
009		PLAYERS CHANGE RM	DT.01		1200	2600	1067	2545	1120	2560	38					
010	STAIR 2		DT.01		1000	2600	867	2545	920	2560	38					
011	FHR		DT-10		950	2000	817	1945	870	1960	38					
012	STORE		RD-02		2000	2400										
013	STORE		RD-02		2000	2400										
014	STORE		RD.02		4000	2400										
015		SERVICES 2	DT-01	-/60/30	1000	2400	867	2345	920	2360	38					
016		SERVICES 1	DT-01		1000	2400	867	2345	920	2360	38					
017		STORE	DT.01	-/60/30	1000	2200	867	2145	920	2160	38					
018	PLAYERS CHANGE RM	PLAYERS CHANGE RM	DT.05		6400	2400			175	2335						
019	PLAYERS CHANGE RM	PLAYERS CHANGE RM	DT.05		6400	2400	007	0445	175	2335	00					
025			DT.01		1000	2200	867	2145	920	2160	38	SMOKE				
	FLOOR - GRANDSTAND											SEAL				
020		MALE	DT.05		1996	2213	1850	2188	1970	2200	60					
020	MALE		DT.01		1000	2200	867	2100	920	2160	38					
022	MALE	ACC. WC	DT.01		1000	2200	867	2145	920	2160	38					
023	GYM / WALKTHROUGH		DT.03		2000	2400	1842	2347	1918	2359	38					
024	GYM / WALKTHROUGH	UMPIRE BRIEFING	DT.03		2000	2400	1842	2347	1918	2359	38					
026	UMPIRE BRIEFING	WC	DT.01		1000	2200	867	2145	920	2160	38					
027	UMPIRE BRIEFING	WC	DT.01		1000	2200	867	2145	920	2160	38					
028	UMPIRE BRIEFING	WC	DT.01		1000	2200	867	2145	920	2160	38					
029	UMPIRE BRIEFING		DT.01		1200	2400	1067	2345	1120	2360	38					
030	MAINTENANCE ACCESS		DT.04		1000	2450			1000	2450	12				STAFF ACCESS ONLY - PROHIBITED STORAGE AREA	
031		MAINTENANCE ACCESS	DT-02		1000	2200			1000	2200	12				STAFF ACCESS ONLY - PROHIBITED STORAGE AREA	
LEVEL 1																
101	CLUBROOM	EXTERNAL VIEWING	DT.06		1737	2625					35					
102	CLUBROOM	EXTERNAL VIEWING	DT.06		1725	2625					35					
103	CLUBROOM	EXTERNAL VIEWING	DT.06		1725	2625					35					
104	CLUBROOM	STORE	DT.01		1000	2200	867	2145	920	2160	38					
105	KITCHEN	STORE	DT.01		1000	2200	867	2145	920	2160	38					
106	CLUBROOM	ACC. WC	DT.01		1000	2200	867	2145	920	2160	38					
107	CLUBROOM	STAIR 2	DT.01		1000	2200	867	2145	920	2160	38					
108	STAIR 2	VENUE MANAGEMENT / OFFICE	DT.01		1000	2200	867	2145	920	2160	38					
109	EDB	VENUE MANAGEMENT / OFFICE	DT.01		1000	2200	867	2145	920	2160	38	SMOOKE SEAL				
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DRAWN BY Author

CHECKED BY Checker

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STATUS CONCEPT DESIGN

SCALES @ A1

**DOOR SCHEDULE** 

BPR-DIS-AR-DRG-9100

DRAWING NO.

DRAWING TO BE PRINTED IN COLOUR


TITLE

NOT FOR CONSTRUCTION


REVISION

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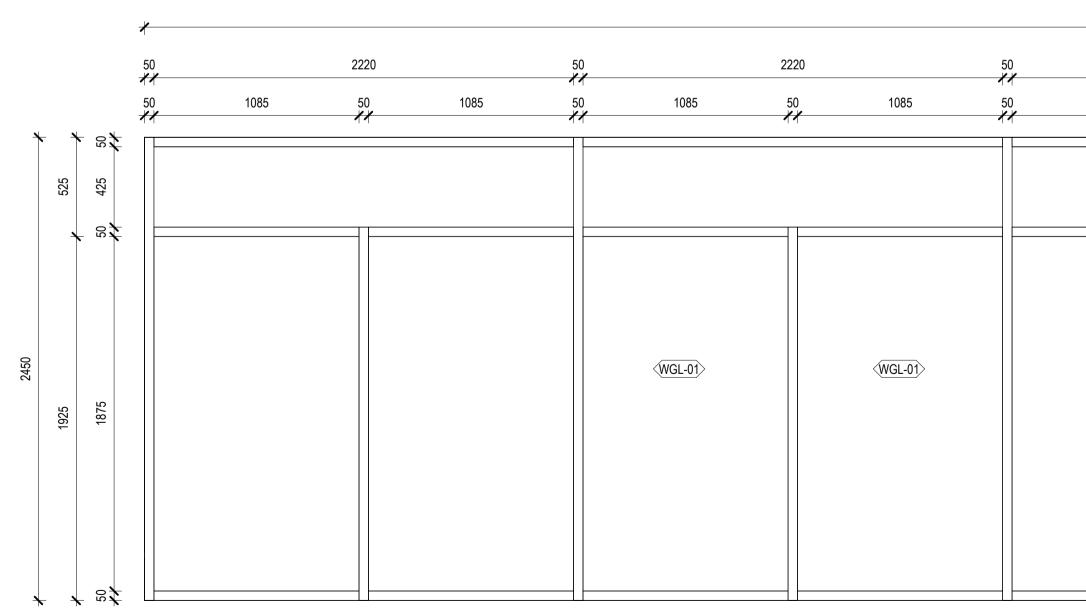
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1 GLAZING AND LOUVRE GRID 3 SCALE 1:20 1350 50 51 150 49 1105 1651 1105 50 50 50 11 11 11 WGL-01 WGL-01 WGL-01 700 GLZ-02 ≁ ¤‡

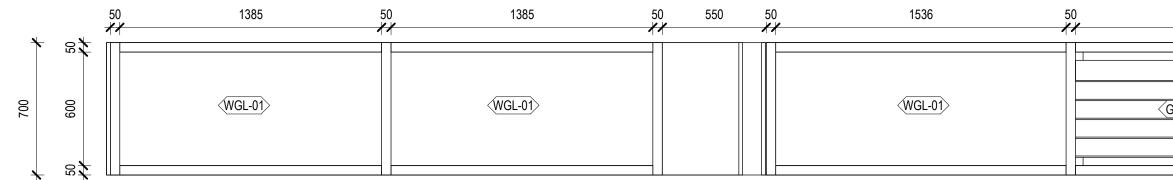

#### 2 GLAZING AND LOUVRE GRID 2 SCALE 1:20

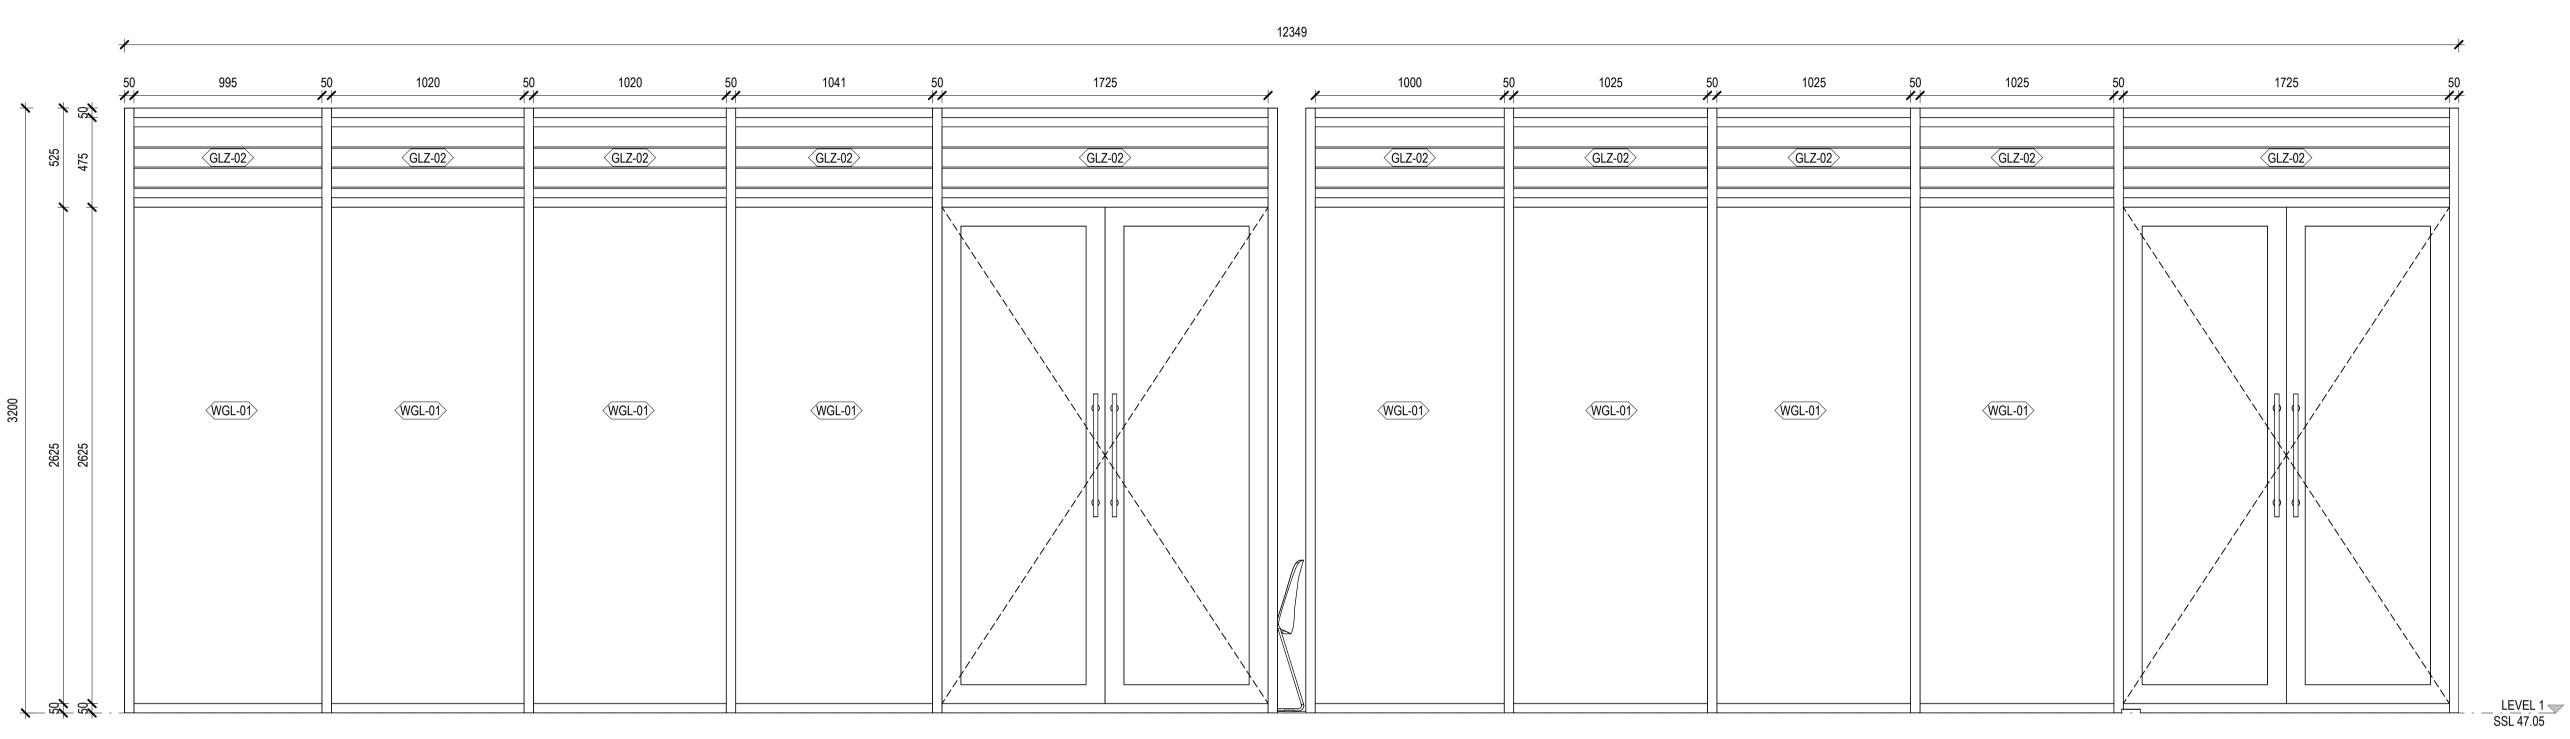

**3** GLAZING AND LOUVRE - GRID 1 SCALE 1:20

Cameron Martin 9194 Mary Anne McGirr 10946

7260 Cathryn Drew-Bredin 7269

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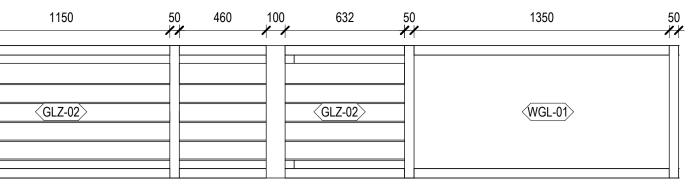


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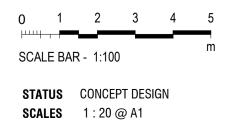
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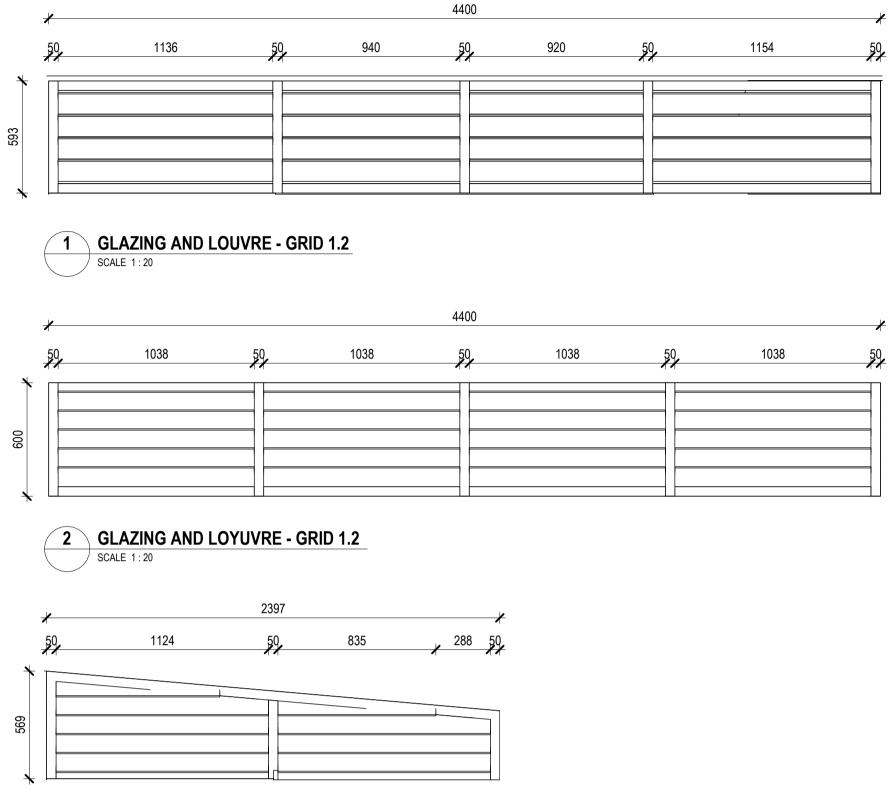



#### NOT FOR CONSTRUCTION DRAWING TO BE PRINTED IN COLOUR

TITLE **GLAZING AND LOUVRE SCHEDULE** SHEET 1 DRAWING NO. REVISION **BPR-DIS-AR-DRG-9200** 



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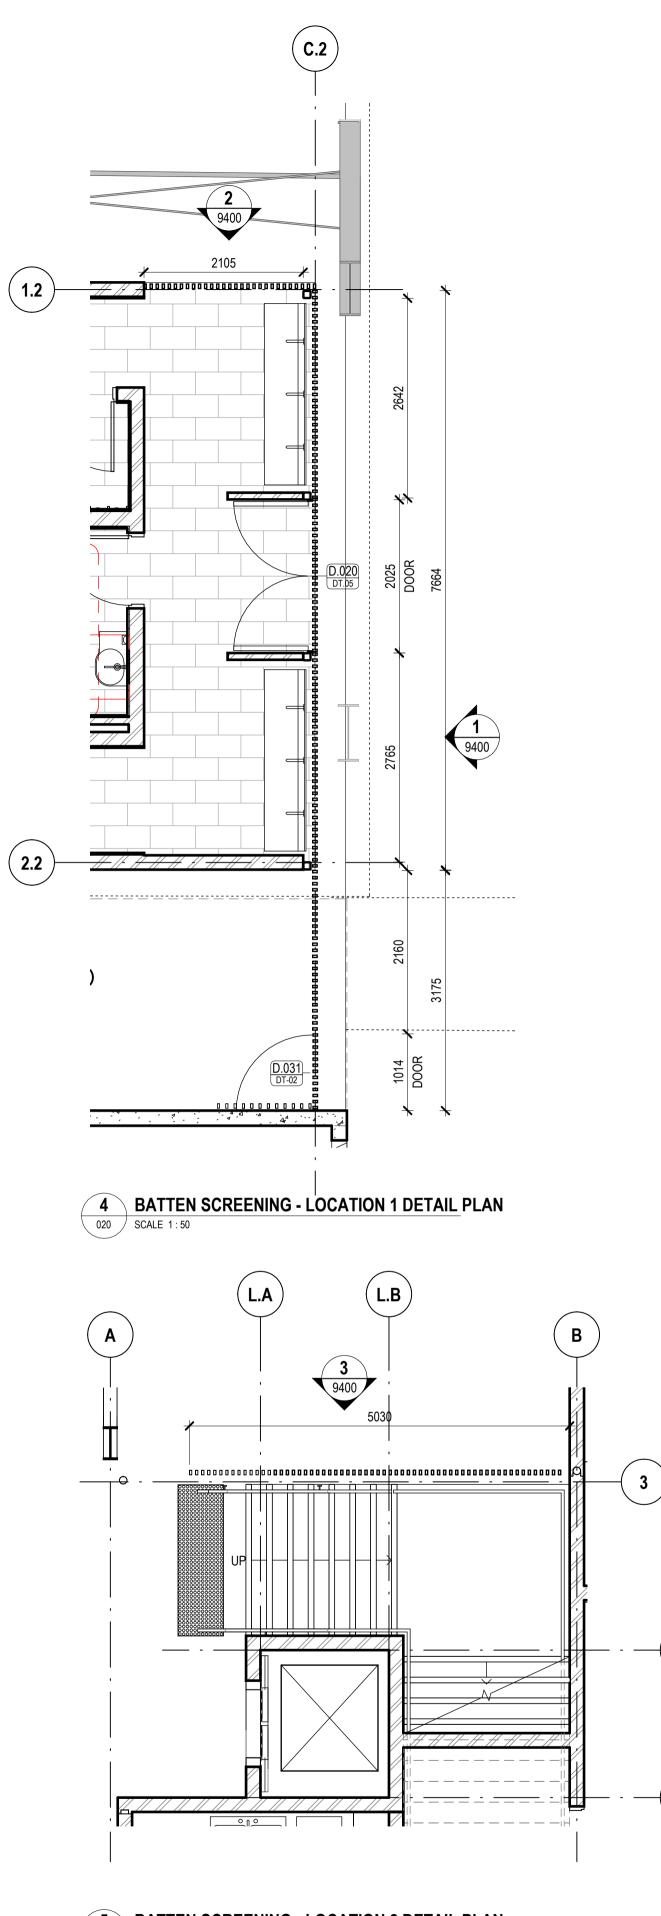
STATUS CONCEPT DESIGN SCALES 1 : 20 @ A1

TITLE **GLAZING AND LOUVRE SCHEDULE -**SHEET 2

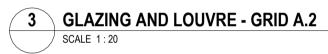DRAWING TO BE PRINTED IN COLOUR

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DRAWING NO. BPR-DIS-AR-DRG--9201 REVISION



5 BATTEN SCREENING - LOCATION 2 DETAIL PLAN 020 SCALE 1:50

7269

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Nominated Architects

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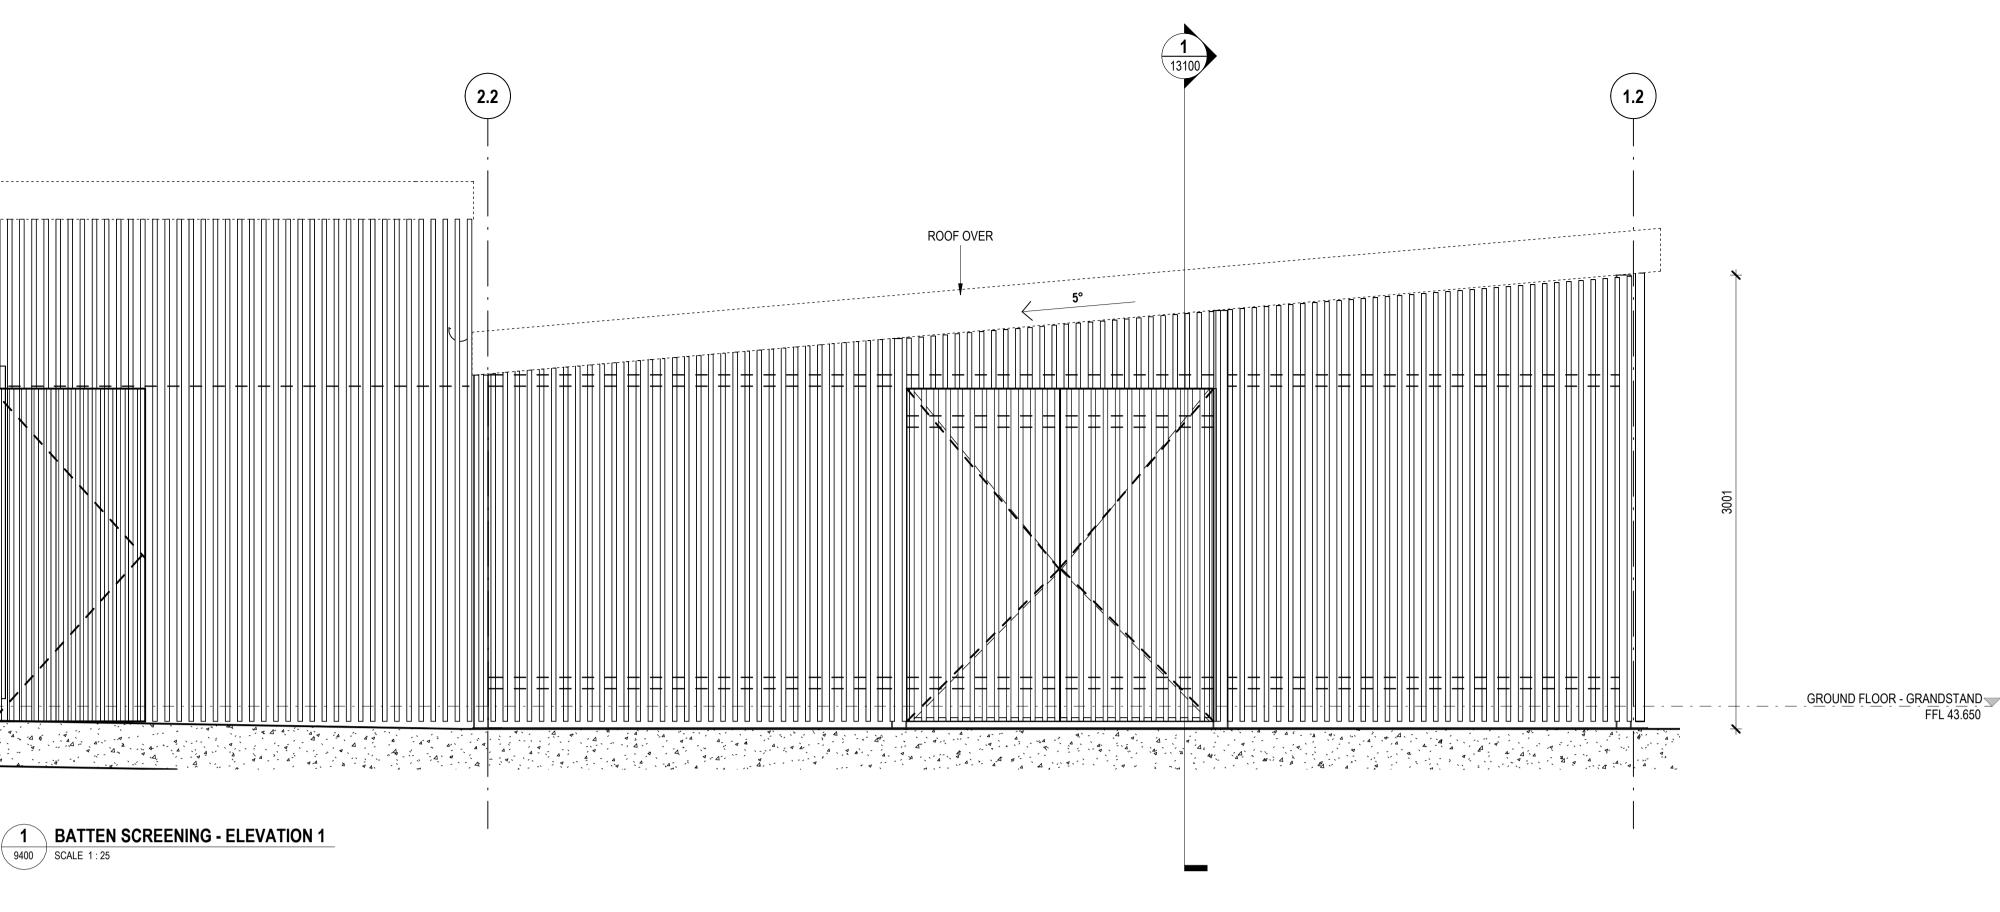
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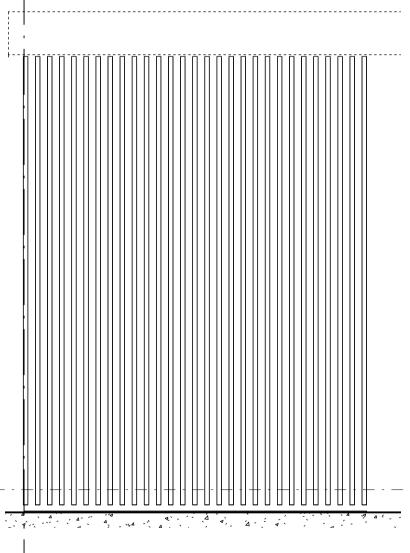
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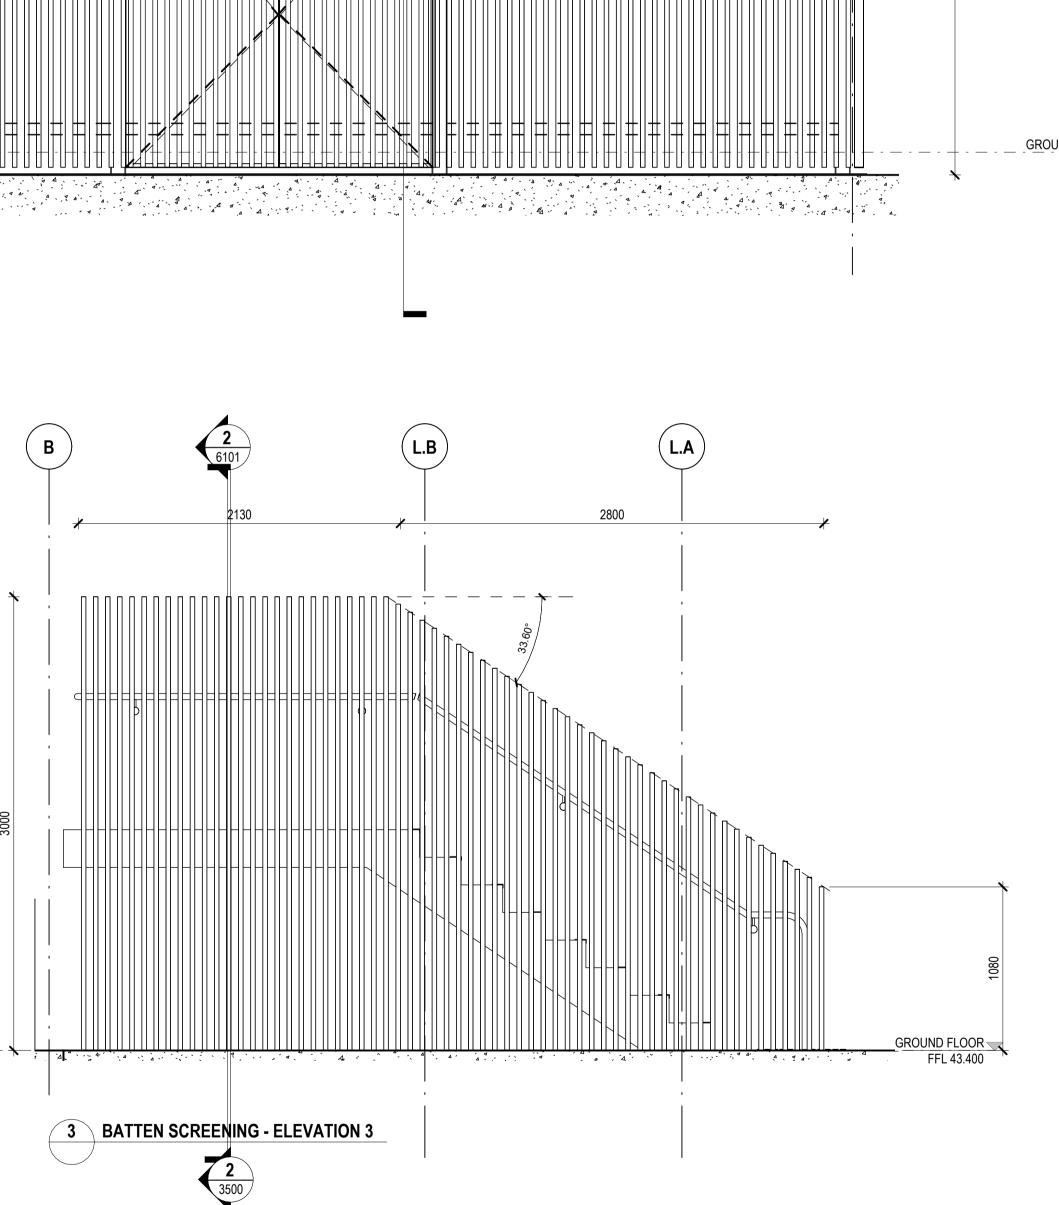
BLOCKWORK WALL-· • • 9400 SCALE 1:25 ( C.2 )  $\mathbf{X}$ 

CONCRETE SLAB OVER-

**2** BATTEN SCREENING - ELEVATION 2 9400 SCALE 1:25









GROUND FLOOR - GRANDSTAND FFL 43.650

#### PROJECT **BOB PRENTER RESERVE AMENITY BUILDING**

PROJECT ADDRESS Fields Rd, Macquarie Fields NSW 2564

# WORK-IN-PROGRESS

A 9.12.24 ISSUED FOR COORDIINATION No DATE REVISIONS


DRAWN BY Author APPROVED BY MAM

SCALES As indicated @ A1 CHECKED BY Checker

0 1 2 3 4 5 SCALE BAR - 1:100 STATUS CONCEPT DESIGN

DRAWING NO. **BPR-DIS-AR-DRG-9400**  REVISION Α

TITLE **BATTEN SCREENING SCHEDULE** 

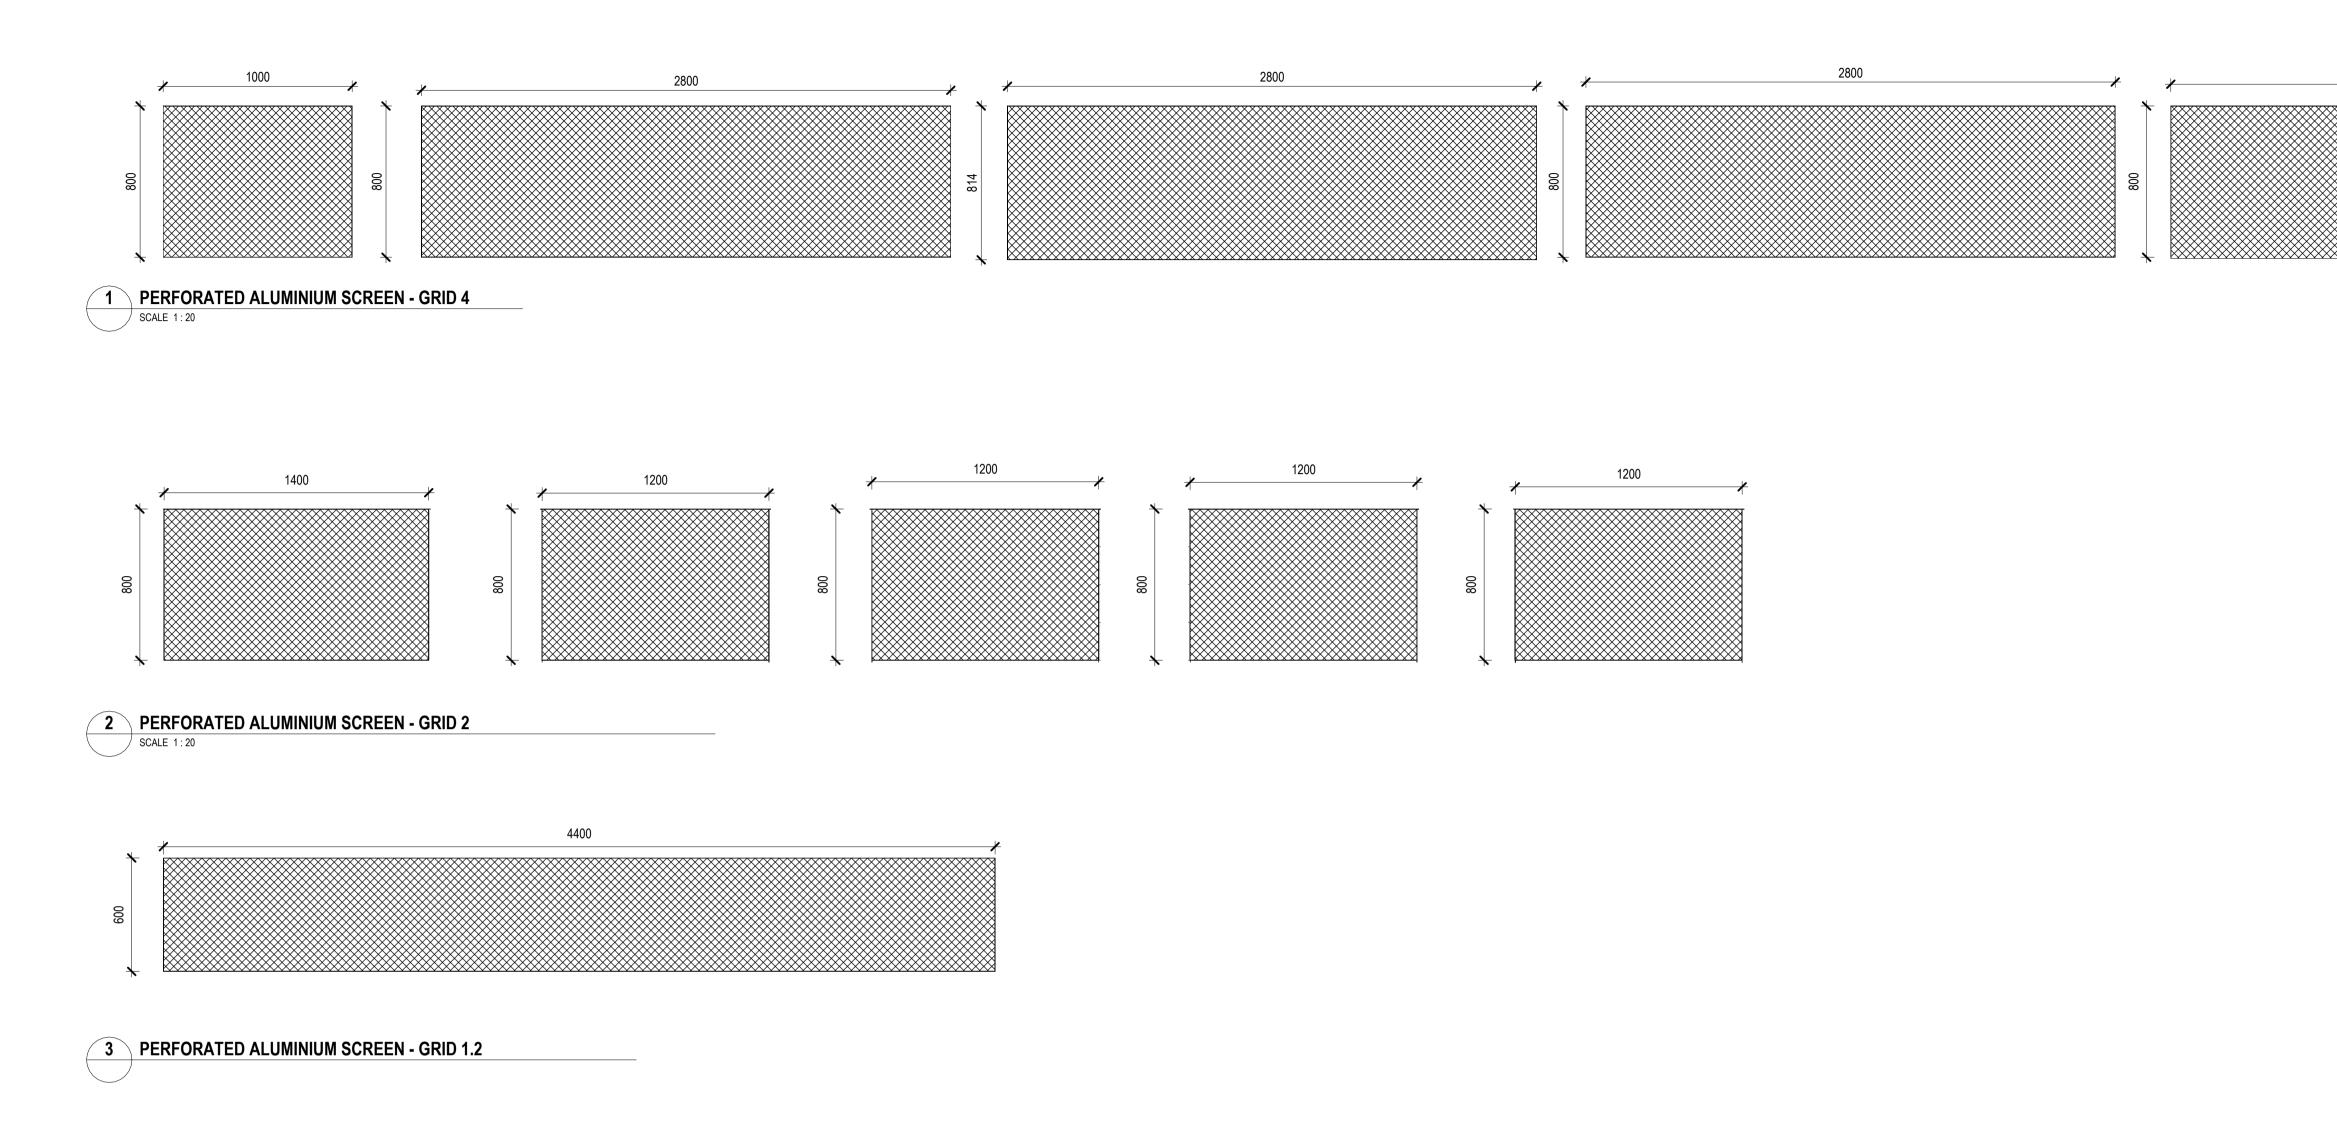



7260 Cathryn Drew-Bredin 7269

Autodesk Docs://P24-100 Bob Prenter Reserve Macquarie Fields/P24-100-AR-Bob Prenter Reserve Macquarie Fields.nvt

Cameron Martin 9194 Mary Anne McGirr 10946

Nominated Architects

PLOTTED : 9/12/2024 11:07:40 AM

lan Armstrong



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# PROJECT BOB PRENTER RESERVE AMENITY BUILDING

PROJECT ADDRESS Fields Rd, Macquarie Fields NSW 2564

## WORK-IN-PROGRESS

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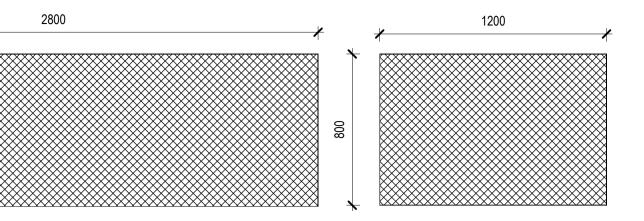
DRAWN BY Author STATUS CONCEPT DESIGN CHECKED BY Checker SCALES 1 : 20 @ A1 APPROVED BY Approver

0 1 2 3 4 5 SCALE BAR - 1:100

> DRAWING NO. **BPR-DIS-AR-DRG-9401**



TITLE PERFORATED SCREEN SCHEDULE



# **BOB PRENTER RESERVE PROJECT** FIELDS RD, MACQUARIE FIELDS NSW 2564 ELECTRICAL SERVICES



								CAMPBELLTOWN CITY COUNCIL	THE COPYRIGHT OF THIS DRAWING REMAINS WITH NORTHRO
ISS	JED FOR COOI	RDINATION		JDC		HK	06.12.24		Desimulas
/		DESCRIPTION		ISSUED	VER'D	APP'D	DATE	CLIENT	ARCHITECT
		Reserve Macquarie Fields.rvt							
	2	P24-100-AR-Bob Prenter	xxxx						
		Reserve Project_R24.rvt		_					
	1	CR241531-00_AR_Bob Prenter	xxxx						
	Maine	Туре	13302 Dali	-					
	Name	Туре	Project Issue Date						
		REVIT LINKS SCHEDULE							

Autodesk Docs://CR241531-00 - Bob Prenter Reserve Project/CR241531-00\_CM\_Bob Prenter Reserve Project\_R24.rvt

No.	DRAWING TI
E00.00	COVER SHEET AN
E00.01	LEGEND OF SYME
E00.02	LUMINAIRE SCHEE
E10.00	SITE PLAN
E20.00	GROUND FLOOR L
E20.01	LEVEL 1 – LIGH
E30.00	GROUND FLOORP
	LAYOUT
E30.01	LEVEL 1 - POWE
E30.02	ROOF PLAN



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**BOB PRENTER RESERVE PROJECT** FIELDS RD, MACQUARIE FIELDS NSW 2564

PROJECT

Canberra 2-6 Shea Street, Phillip A.C.T. 2606 Ph (02) 6285 1822 Email: canberra@northrop.com.au ABN 81 094 433 100



TITLE AND DRAWING SCHEDULE MBOLS AND NOTES EDULE

LIGHTING LAYOUT HTING LAYOUT POWER, COMMUNICATION AND SECURITY

/ER, COMMUNICATION AND SECURITY LAYOUT

# PRINT IN COLOUR NOT FOR CONSTRUCTION JOB NUMBER

DRAWING TITLE

ELECTRICAL SERVICES **COVER SHEET AND DRAWING** SCHEDULE

CR241531-00 DRAWING NUMBER REVISION E00.00 DRAWING SHEET SIZE = A1 6/12/2024 9:28:22 AM

#### POWER

SYMBOL	DESCRIPTION	SYMBOL	E DESCRIPTION	-
	SINGLE 10A GPO NON-ESSENTIAL UNO SINGLE 10A GPO ESSENTIAL SERVICES UNO	DEEED	R TO LUMINAIRE SCHEDULE	
	SINGLE 10A GPO UPS SERVICES UNO DOUBLE 10A GPO NON-ESSENTIAL UNO		S OF LUMINAIRES	
	DOUBLE 10A GPO ESSENTIAL UNO DOUBLE 10A GPO UPS UNO	•		
Ø Ø Ø	SINGLE PHASE IP56 POWER OUTLET, 20A NON-ESSENTIAL SINGLE PHASE IP56 POWER OUTLET, 20A ESSENTIAL UNO SINGLE PHASE IP56 POWER OUTLET, 20A UPS UNO		SINGLE POINT LED CEILING RECESSED EMERGENCY	
ø	SINGLE PHASE PERMANENT CONNECTION C/W FULL CURREN		EMERGENCY FLOOD LIGHT	
۶	ISOLATOR, 20A NON-ESSENTIAL UNO SINGLE PHASE PERMANENT CONNECTION C/W FULL CURREN ISOLATOR, 20A ESSENTIAL UNO		ILLUMINATED EXIT SIGN (PICTORIAL TYPE)	
۶	SINGLE PHASE PERMANENT CONNECTION C/W FULL CURREN	NT X	ILLUMINATED EXIT SIGN WITH DIRECTIONAL ARRON	N
¢ ¢	THREE PHASE IP56 5 PIN POWER OUTLET, 20A NON-ESSEI THREE PHASE IP56 5 PIN POWER OUTLET, 20A ESSENTIAL	NTIAL UNO	2W - DENOTES TWO WAY SWITCH THREE BLADE CEILING FAN	
Ø ø	THREE PHASE IP56 5 PIN POWER OUTLET, 20A UPS UNO THREE PHASE PERMANENT CONNECTION C/W FULL CURREN		Inkee DLADE LEILING FAN	
<i>*</i> ₽ <i>∳</i>	ISOLATOR, 20A NON-ESSENTIAL UNO THREE PHASE PERMANENT CONNECTION C/W FULL CURREN	$\searrow$	FOUR BLADE CEILING FAN	
<b>*</b>	ISOLATOR, 20A ESSENTIAL UNO THREE PHASE PERMANENT CONNECTION C/W FULL CURREN ISOLATOR, 20A UPS UNO		LED STRIP	
ю	WALL MOUNTED FAN		SWITCHING WIRE	
DBn-P/L1	CIRCUIT REFERENCE DBn – DENOTES DISTRIBUTION BOARD No.	LSP	MULTI-GANG LIGHT SWITCH PANEL SS – STAINLESS STEEL ENGRAVED RECESSED LIG SWITCH PANEL	iНТ
	P – DENOTES POWER L – DENOTES LIGHTING	PE	PHOTOELECTRIC CELL	
	1 - DENOTES CIRCUIT No.	FC	FAN CONTROLLER	
	SOLAR PANEL	*	240V 360° CEILING RECESSED OCCUPANCY SENSO	R
	CONTROL PANEL	<b>9</b> −	240V 90° WALL OCCUPANCY SENSOR	
	DISTRIBUTION BOARD	X	FLOOD LIGHT	
	2-CHANNEL SKIRTING DUCT	DALI	DALI LIGHTING CONTROL	
$\boxtimes$	CABLE PIT	CBUS	CBUS LIGHTING CONTROL	
	E – DENOTES ELECTRICAL TYPE C			
PE	PHOTOELECTRIC / TIME SWITCH			
	POWER CABLE TRAY SIZE AS NOTED ON DRAWING			
	POWER CABLE LADDER SIZE AS NOTED ON DRAWING			
	POWER CONDUIT SIZE AS NOTED ON DRAWING			
<b>©</b>	POWER UMBILICAL CORD			
UED FOR COORDINAT		ER'D APP'D DATE CLIE HK 06.12.24	ENT	ARCHITECT

LIGHTING	
SYMBOL	DF

SYMBOL

## Ē $\nabla$ MDF IDF $\boxtimes$ レ PSU PNTD PDH CTL FDT NTD X ΤV

PTV

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REV	DESCRIPTION	ISSUED	VER'D	APP'D	DATE	CLIENT	ARCHITECT
1	ISSUED FOR COORDINATION	JDC		HK	06.12.24		
						CAMPBELLTOWN	Πος
							Des
						CITY COUNCIL	
							THE COPYRIGHT OF THIS
							CONSULTIN

#### COMMUNICATIONS/MATV

ATIONS/MATV
DESCRIPTION
SINGLE 8P8C (RJ45) COMMUNICATIONS OUTLET (CATEGORY 6A)
DUAL-GANG 8P8C (RJ45) COMMUNICATIONS OUTLET (CATEGORY 6A)
MULTIGANG 8P8C (RJ45) COMMUNICATIONS OUTLET (CATEGORY 6A) # – DENOTES NUMBER OF OUTLETS DEDICATED TELEPHONE OUTLET
MAIN DISTRIBUTION FRAME
INTERMEDIATE DISTRIBUTION FRAME
FLOOR/WALL MOUNTED COMMUNICATIONS RACK
POWER SUPPLY UNIT
PRIVATE FIBRE NETWORK TERMINATION DEVICE
NBN PREMISES DISTRIBUTION HUB
NBN CABLE TRANSITION LOCATION
NBN FIBRE DISTRIBUTION TERMINAL
NBN NETWORK TERMINATION DEVICE
MATV ANTENNA
F-TYPE TELEVISION OUTLET
PAY TV OUTLET
СГОСК
NBN PIT TYPE 2 SERVICE DROP ACCESS
CABLE PIT C – DENOTES COMMUNICATIONS CLASS C WHERE NON-TRAFFICABLE SIZE OF PIT 900mm x 900mm UNO

COMMUNICATIONS CABLE TRAY SIZE AS NOTED ON DRAWING

COMMUNICATIONS CABLE LADDER SIZE AS NOTED ON DRAWING

COMMUNICATIONS CONDUIT SIZE AS NOTED ON DRAWING

HEAVY DUTY STAINLESS STEEL REED SWITCH

DESCRIPTION

REED SWITCH

MOTION DETECTOR

INTERCOM DOOR STATION

MAIN SECURITY ALARM PANEL

MAIN EXPANDER PANEL

#### <u>FIRE</u>

SYMBOL

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		SCHEM
	DESCRIPTION	SYMBOL
	SMOKE DETECTOR	- <b>o</b> ×
	240V SMOKE DETECTOR	20A
	CONCEALED SMOKE DETECTOR	
	THERMAL DETECTOR	
	CONCEALED THERMAL DETECTOR	-050-
	CONCEALED SPACE DETECTOR INDICATOR	-00-
	SURFACE MOUNTED BOWS SPEAKER	
	CEILING RECESSED BOWS SPEAKER	20A
	FIRE DETECTION CONTROL & INDICATION EQUIPMENT	-0
	SUB-FIRE INDICATOR PANEL	- <b>o</b> o-
	VESDA DETECTOR	U MAN
	FIRE ANNUNCIATOR PANEL	
•	SURFACE MOUNTED HORN	<b></b>
	FIRE ALARM BELL	느
	MAGNETIC DOOR HOLDER C/W DOOR RELEASE BUTTON	Q
	EMERGENCY WARNING CONTROL & INDICATING EQUIPMENT	PFC
	MIMIC PANEL	UPS
	WARDEN INTERCOM POINT	EPJ
	EWIS MANUAL CALL POINT	G
	FIP MANUAL CALL POINT	LB
	STROBE	ATS
	FIRE CABLE TRAY SIZE AS NOTED ON DRAWING	PV
	FIRE CABLE LADDER SIZE AS NOTED ON DRAWING	INV
	FIRE CONDUIT SIZE AS NOTED ON DRAWING	3
		PM
		~

## MATIC

(M)

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INFORMATION)

'IA I	
	DESCRIPTION
	CIRCUIT BREAKER
	CIRCUIT BREAKER RCD TYPE
	CHANGEOVER CONTACT
-	CONTACTOR
	FUSE SWITCH
-	MAIN SWITCH
	NORMALLY CLOSED CONTACT
	NORMALLY OPEN CONTACT
UTO OFF ANUAL	THREE POSITION SWITCH
	FUSE
	CIRCUIT JOIN
	EARTH
	SURGE PROTECTION DEVICE
	POWER FACTOR CORRECTION UNIT
	UN-INTERUPTABLE POWER SUPPLY
	EARTH POTENTIAL JUNCTION
	STAND-BY GENERATOR SET
	GENERATOR CONNECTOR LINK BOX
	AUTO TRANSFER SWITCH
	PHOTOVOLTAIC SOLAR CELLS
	SOLAR PANEL INVERTER
	CURRENT TRANSFORMER
	PRIVATE MULTI-FUNCTION METER
	SUPPLY AUTHORITY METER
	PAD-MOUNT KIOSK SUBSTATION (REFER LEVEL 3 DESIGN DOCUMENTATION FOR FURTHER

#### ABBREVIATIONS

INTERLUM DUUR STATIUN				
AUDIO INTERCOM & DOOR BUTTON PANEL	AB	ABOVE BENCH	HD	HAND DRYER
AUDIO, VISUAL INTERCOM & DOOR BUTTON PANEL	AC	AIR CONDITIONING	HL	HIGH LEVEL
AUDIO, VISUAL INTERCON & DOOR BUTTON FANEL	AD	AUTOMATIC DOOR	HP	HEATED PLATE DISPENSER
PROXIMITY CARD READER	BB	BELOW BENCH	HWU	HOT WATER UNIT
KEYPAD	BC	BLAST CHILLER	ICE	ICE MAKER
	BM	BAIN MARIE	КT	TILTING KETTLE
BREAK GLASS PRESS TO EXIT	BOWS	BUILDING OCCUPANT WARNING SYSTEM	LL	LOW LEVEL
PUSH BUTTON PRESS TO EXIT	BP	BRATT PAN	LF	LARGE FORMAT
	BWU	BOILING WATER UNIT	MW	MICROWAVE
ELECTRIC DOOR STRIKE	С	CEILING	٥V	OVEN
F - DENOTES CONNECTION TO FIP FOR	CAB	CABINETS BY JOINERY CONTRACTOR	Р	PENDANT OUTLET
AUTOMATIC RELEASE ON FIRE ALARM	CCS	CONCEALED SPACE	PC	PASTA COOKER
ELECTRIC LOCK	CEIL	CEILING CONCEALED	RCD	INTEGRAL RCD
V-LOCK	CFE	COFFEE MACHINE	RD	ROLLER DOOR
V-LOCK	CG	COFFEE GRINDER	RFC	REFRIGERATION CONDENSER
DIGITAL VIDEO RECORDER	CL	CLEANERS OUTLET	RH	RANGE HOOD
ACCESS CONTROL SYSTEM HEADEND	CM	CEILING MOUNTED	R	RED OUTLET
ACCESS CONTROL STSTEIT HEADEND	CR	COOL ROOM	S	STARTER SOCKET
CCTV CAMERA	CS	COMBI STEAMER	SK	SKIRTING DUCT
	СТ	COOKTOP	SS	SOFTWIRE STARTER
DOME CCTV CAMERA	C/W	COMPLETE WITH	SW	SOFTWIRED
CCTV MONITOR	DW	DISHWASHER	TAB	TABLE MOUNTED
	ESC	ESCALATOR	ΤV	TELEVISION
SECURITY CABLE TRAY SIZE AS NOTED ON DRAWING	EWIS	EMERGENCY WARNING AND INTERCOMMUNICATION SYSTEM	USB	CHARGING USB
	F	FLOOR	U	UPS BACKUP
SECURITY CABLE LADDER SIZE AS NOTED ON DRAWING	FR	FRIDGE	UB	UNDER BENCH
SECURITY CONDUIT SIZE AS NOTED ON DRAWING	FIP	FIRE INDICATOR PANEL	UNO	UNLESS NOTED OTHERWISE
SECONTE CONDOLE SIZE AS NOTED ON DRAWING	FLR	FLOOR RECESSED	WAP	WIRELESS ACCESS POINT
BMS CABLE TRAY SIZE AS NOTED ON DRAWING	FRY	FRYER	WM	WALL MOUNTED IP66 RATED
	GM		WP	WEATHERPROOF
BMS CABLE LADDER SIZE AS NOTED ON DRAWING	GR	TOASTER/GRILLER	1PH	SINGLE PHASE
	GW	GLASS WASHER	3PH	THREE PHASE
BMS CONDUIT SIZE AS NOTED ON DRAWING	HC	HOT CUPBOARD		

# signInc

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Canberra 2-6 Shea Street, Phillip A.C.T. 2606 Ph (02) 6285 1822 Email: canberra@northrop.com.au ABN 81 094 433 100

NORTHROP

**BOB PRENTER RESERVE PROJECT** FIELDS RD, MACQUARIE FIELDS **NSW 2564** 

PROJECT

#### NOTES

- 1. ALL WORK SHALL BE CARRIED OUT IN ACCORDANCE WITH THE CURRENT REVISIONS OF THE BCA, AS/NZS 3000, STATE ELECTRICAL SERVICE AND INSTALLATION RULES, AUSTRALIAN STANDARDS, COUNCIL AND SUPPLY AUTHORITY REQUIREMENTS AND ALL OTHER APPROPRIATE STANDARDS, CODES, RULES AND REGULATIONS.
- 2. ELECTRICAL SERVICES DRAWINGS MUST BE READ IN CONJUNCTION WITH THE ELECTRICAL SPECIFICATIONS, ARCHITECTURAL DRAWINGS, LIGHTING SCHEDULE AND ALL OTHER CONTRACT DOCUMENTATION. WHERE THERE IS CONFLICTING INFORMATION WITHIN THE DOCUMENTATION, CONTRACTOR SHALL ALLOW FOR THE MOST ONEROUS AND SEEK CLARIFICATION.
- 3. DO NOT SCALE OFF DRAWINGS. VERIFY ALL DIMENSIONS ON SITE.
- 4. EQUIPMENT LOCATIONS AND SIZES ARE DIAGRAMMATIC ONLY, REFER TO ARCHITECT'S AND INTERIOR DESIGNER'S DOCUMENTATION FOR EXACT LOCATIONS.
- 5. NO VARIATIONS TO THE EXTENT OF THE WORK SHALL BE UNDERTAKEN WITHOUT PRIOR WRITTEN CONSENT.
- 6. THE ELECTRICAL CONTRACTOR SHALL UNDERTAKE A "DIAL BEFORE YOU DIG" SEARCH FOR EXISTING IN-GROUND SERVICES PRIOR TO EXCAVATION ON SITE. ANY DAMAGE TO EXISTING IN-GROUND SERVICES SHALL BE THE CONTRACTOR'S RESPONSIBILITY.
- 7. EXISTING SERVICES SHOWN IN THIS DRAWING PACKAGE HAVE BEEN PLOTTED FROM THE SUPPLIED DATA. NORTHROP CANNOT GUARANTEE THE ACCURACY OF THIS INFORMATION. IT IS THE CONTRACTORS RESPONSIBILITY TO CARRY OUT A SURVEY FOR EXISTING SERVICES PRIOR TO THE COMMENCEMENT OF WORKS. THE CONTRACTOR SHALL BE RESPONSIBLE FOR ANY DAMAGE CAUSED TO EXISTING SERVICES AS A RESULT OF THE EXECUTION OF THESE WORKS.
- 8. THE ELECTRICAL CONTRACTOR SHALL CO-ORDINATE ALL OUTLETS, LIGHT FITTINGS, PPLY SMOKE DETECTORS, THERMAL DETECTORS, EXIT SIGNS, EMERGENCY LUMINAIRES, SPEAKERS, ANNUNCIATOR PANELS AND THE LIKE WITH OTHER SERVICES, REFLECTED CEILING PLANS, FURNITURE LAYOUTS, JOINERY DETAILS, WET AREA DETAILS ON SITE AND PRIOR TO ROUGHING & INSTALLATION OF CABLING.
  - 9. CONTRACTOR SHALL CONFIRM LOCATION, RATING AND PHASE REQUIREMENTS FOR SUPPLIES TO EQUIPMENT WITH THE RELEVANT TRADE (E.G. CONFIRM PUMPS WITH HYDRAULIC CONTRACTOR) ON SITE AND PRIOR TO INSTALLATION.
  - 10. ALL SWITCHBOARDS, COMMUNICATION RACKS, HEAD-END EQUIPMENT AND THE LIKE SHALL BE SIZED TO FIT SPACES PROVIDED.
  - 11. ALL SUB-CIRCUITS SHALL BE PROTECTED BY 20A 30mA EARTH LEAKAGE CIRCUIT BREAKERS UNLESS OTHERWISE NOTED.
  - 12. WHERE ELECTRICAL INSTALLATION OCCURS IN A FIRE-RATED SURFACE, THE FIRE RATING OF THE SURFACE MUST BE MAINTAINED BY THE USE OF WALL BOXES TESTED IN ACCORDANCE WITH AS1530.4 AND AS4072.1 OR EQUIVALENT. REFER TO MANUFACTURER'S RECOMMENDATION FOR INSTALLATION.
  - 13. IT IS THE CONTRACTOR'S RESPONSIBILITY TO ENSURE THAT FINAL LOCATIONS OF ALL OUTLETS, LUMINAIRES, SWITCHBOARDS AND OTHER ELECTRICAL EQUIPMENT ARE INSTALLED WITH CONSIDERATION TO THE NSW ACT OF SAFETY IN DESIGN.
  - 14. CONTRACTOR SHALL REFER TO DRAWINGS WITH RESPECT TO AREA/SCOPE OF WORKS FOR DEMOLITION. CONTRACTOR SHALL REMOVE ALL REDUNDANT CABLING BACK TO SWITCHBOARD, COMMUNICATIONS RACK, HEAD-END EQUIPMENT ETC. UNLESS OTHERWISE NOTED.
  - 15. ANY PRODUCTS SPECIFIED OR USED ARE TO BE VERIFIED BY THE CONTRACTOR AS BEING SAFE AND APPROPRIATE FOR USE. NORTHROP DOES NOT TAKE ANY RESPONSIBILITY FOR THE PROVISION OF BANNED BUILDING PRODUCTS AS DEFINED BY NSW BUILDING PRODUCTS (SAFETY) ACT 2017.
  - 16. NOTE, NOT ALL SYMBOLS MAY BE USED.

#### PRINT IN COLOUR NOT FOR CONSTRUCTION DRAWING TITLE

**ELECTRICAL SERVICES** LEGEND OF SYMBOLS AND NOTES

JOB NUMBER CR241531-00 DRAWING NUMBER REVISION E00.01 DRAWING SHEET SIZE = A1

						LUMINAIRE SCHEDULE				
	CODE	Description	Supplier	Name of Fitting	Finish	Dimensions	Wattage	Lumen output, colour temperature, CRI, IP Rating	Beam Angle	Image
	D1	IP Rated Downlights	Trend Lighting	MiniLED XDJ10	TBC by Architect	B8 B3 Cutout Ø70 mm	10W	1450 lm 3000K CRI 80 IP65		
	D2	Downlights	Trend Lighting	Midiled XDF15	TBC by Architect	150 150 150 150 150 150 150 150	15W	2000 lm 3000K CRI 90 IP65	Wide	
	S1	IP rated Surface Mounted Lights	Est Lighting	CORE 70 Caliber	TBC by Architect		15W	1190 lm 3000K CRI 90+ IP54		
	S2	Surface Mounted External Light	Trend Lighting	Candela CAN12	TBC by Architect	Mounting Plate 51 51 150 95 Ø95	12W	1150 lm 3000К СRI 90+ IP54		
	T1	Clean Room Surface Mounted Troffers	Eagle Lighting	Cleanroom IP65 LED EL-CR65L-1115-000	TBC by Architect	L=1255mm, W=380mm, H=107mm	39.8W	4287 lm 4000K CRI IP65, IK08		
	Т2	Surface Mounted Vandal proof Troffers	Versalux	ASTI ATP.R1H.4080.19	TBC by Architect	597 297	19.3W	2149 lm 3000K CRI 80 IP40, IK08		
	Т3	IP Rated Amenties Troffers	Versalux	ASTI ATP.R1M.4080.19	TBC by Architect	597	13.7W	1552 lm 3000K CRI 80 IP40, IK08		
	L1	Recessed Linear	Trend Lighting	Extrusion EX241 Flexiled XF24RGBW	TBC by Architect		20W/m	1000 lm 3000К СRI 90+ IP20		
с с	L2	Suspended Bi- directional Linear	Trend Lighting	Slot ZDA90-DI	TBC by Architect	D Extrusion Profile	35W	4964 lm 3000K CRI 90 IP20		
VERIFIER:	L3	Suspended Linear	Trend Lighting	Isla ZTL12-D	TBC by Architect		32W	4464 lm 3000K CRI 90+ IP20		
AGER: S.PARAJULI	F1	Batten	Trend Lighting	Mono ZSB38	TBC by Architect	Height 60 mm	30W	4700 lm 4000K CRI 85+ IP40, IK10		
JOB MANAGER:	F1E	Emergency Batten	Trend Lighting	Mono ZSB39 Emergency	TBC by Architect	Largh 100 mm	30W	4700 lm 4000K CRI 85+ IP40, IK10		
H. KAMAL	W1	Wall Mounted Light	Versalux	MIDNA - Unidirectional	TBC by Architect	8 8 1 1 220	11W	763lm 3000K IP66, IK10		
DESIGNED:	W2	Wall Mounted Light	Versalux	MIDNA - Bidirectional	TBC by Architect	00 SE Z20	19W	2 x 763lm 3000K IP66, IK10		
DRAWN: J. DELA CRUZ										
REV       DESCRIPTION       ISSUED       VER'D       APP'D       DATE         1       ISSUED FOR COORDINATION       JDC       HK       06.12.24         1       ISSUED FOR COORDINATION       Inc       Inc       Inc         1       ISSUED FOR COORDINATION       Inc       Inc       Inc         1       ISSUED FOR COORDINATION       Inc       Inc       Inc         1       Inc       Inc       Inc       Inc       Inc         1       Inc       Inc       Inc       Inc       Inc         1       Inc       Inc       Inc       Inc       Inc	CLIENT CAMPBELLTOWI CITY COUNCIL		Des	ignInc		ALL SETOUT TO ARCHITECT'S DRA DIMENSIONS TO BE VERIFIED WITH BUILDER BEFORE COMMENCING SHO SITE WORK. NORTHROP ACCEPTS FOR THE USABILITY, COMPLETENE DRAWINGS TRANSFERRED ELECTR	I ARCHITECT AN OP DRAWINGS O NO RESPONSIBIL SS OR SCALE O			<b>RTHRO</b> <b>Canberra</b> ea Street, Phillip A.C.T. 2606
Autodock Docs://(E2/1531.00 Bob Broater Becoryo Project/(E2/1531.00 (M. Bob Broater Becoryo Project P2/				DRAWING REMAINS WITH NOF ENGINEERS PTY LTD	RTHROP				Ph (02) 6285 18	822 Email: canberra@northrop.com.au ABN 81 094 433 100




BOB PRENTER RESERVE PROJECT FIELDS RD, MACQUARIE FIELDS NSW 2564


PROJECT



ELECTRICAL SERVICES LUMINAIRE SCHEDULE

CR241531-00 DRAWING NUMBER REVISION E00.02 DRAWING SHEET SIZE = A1 6/12/2024 9:28:28 AM

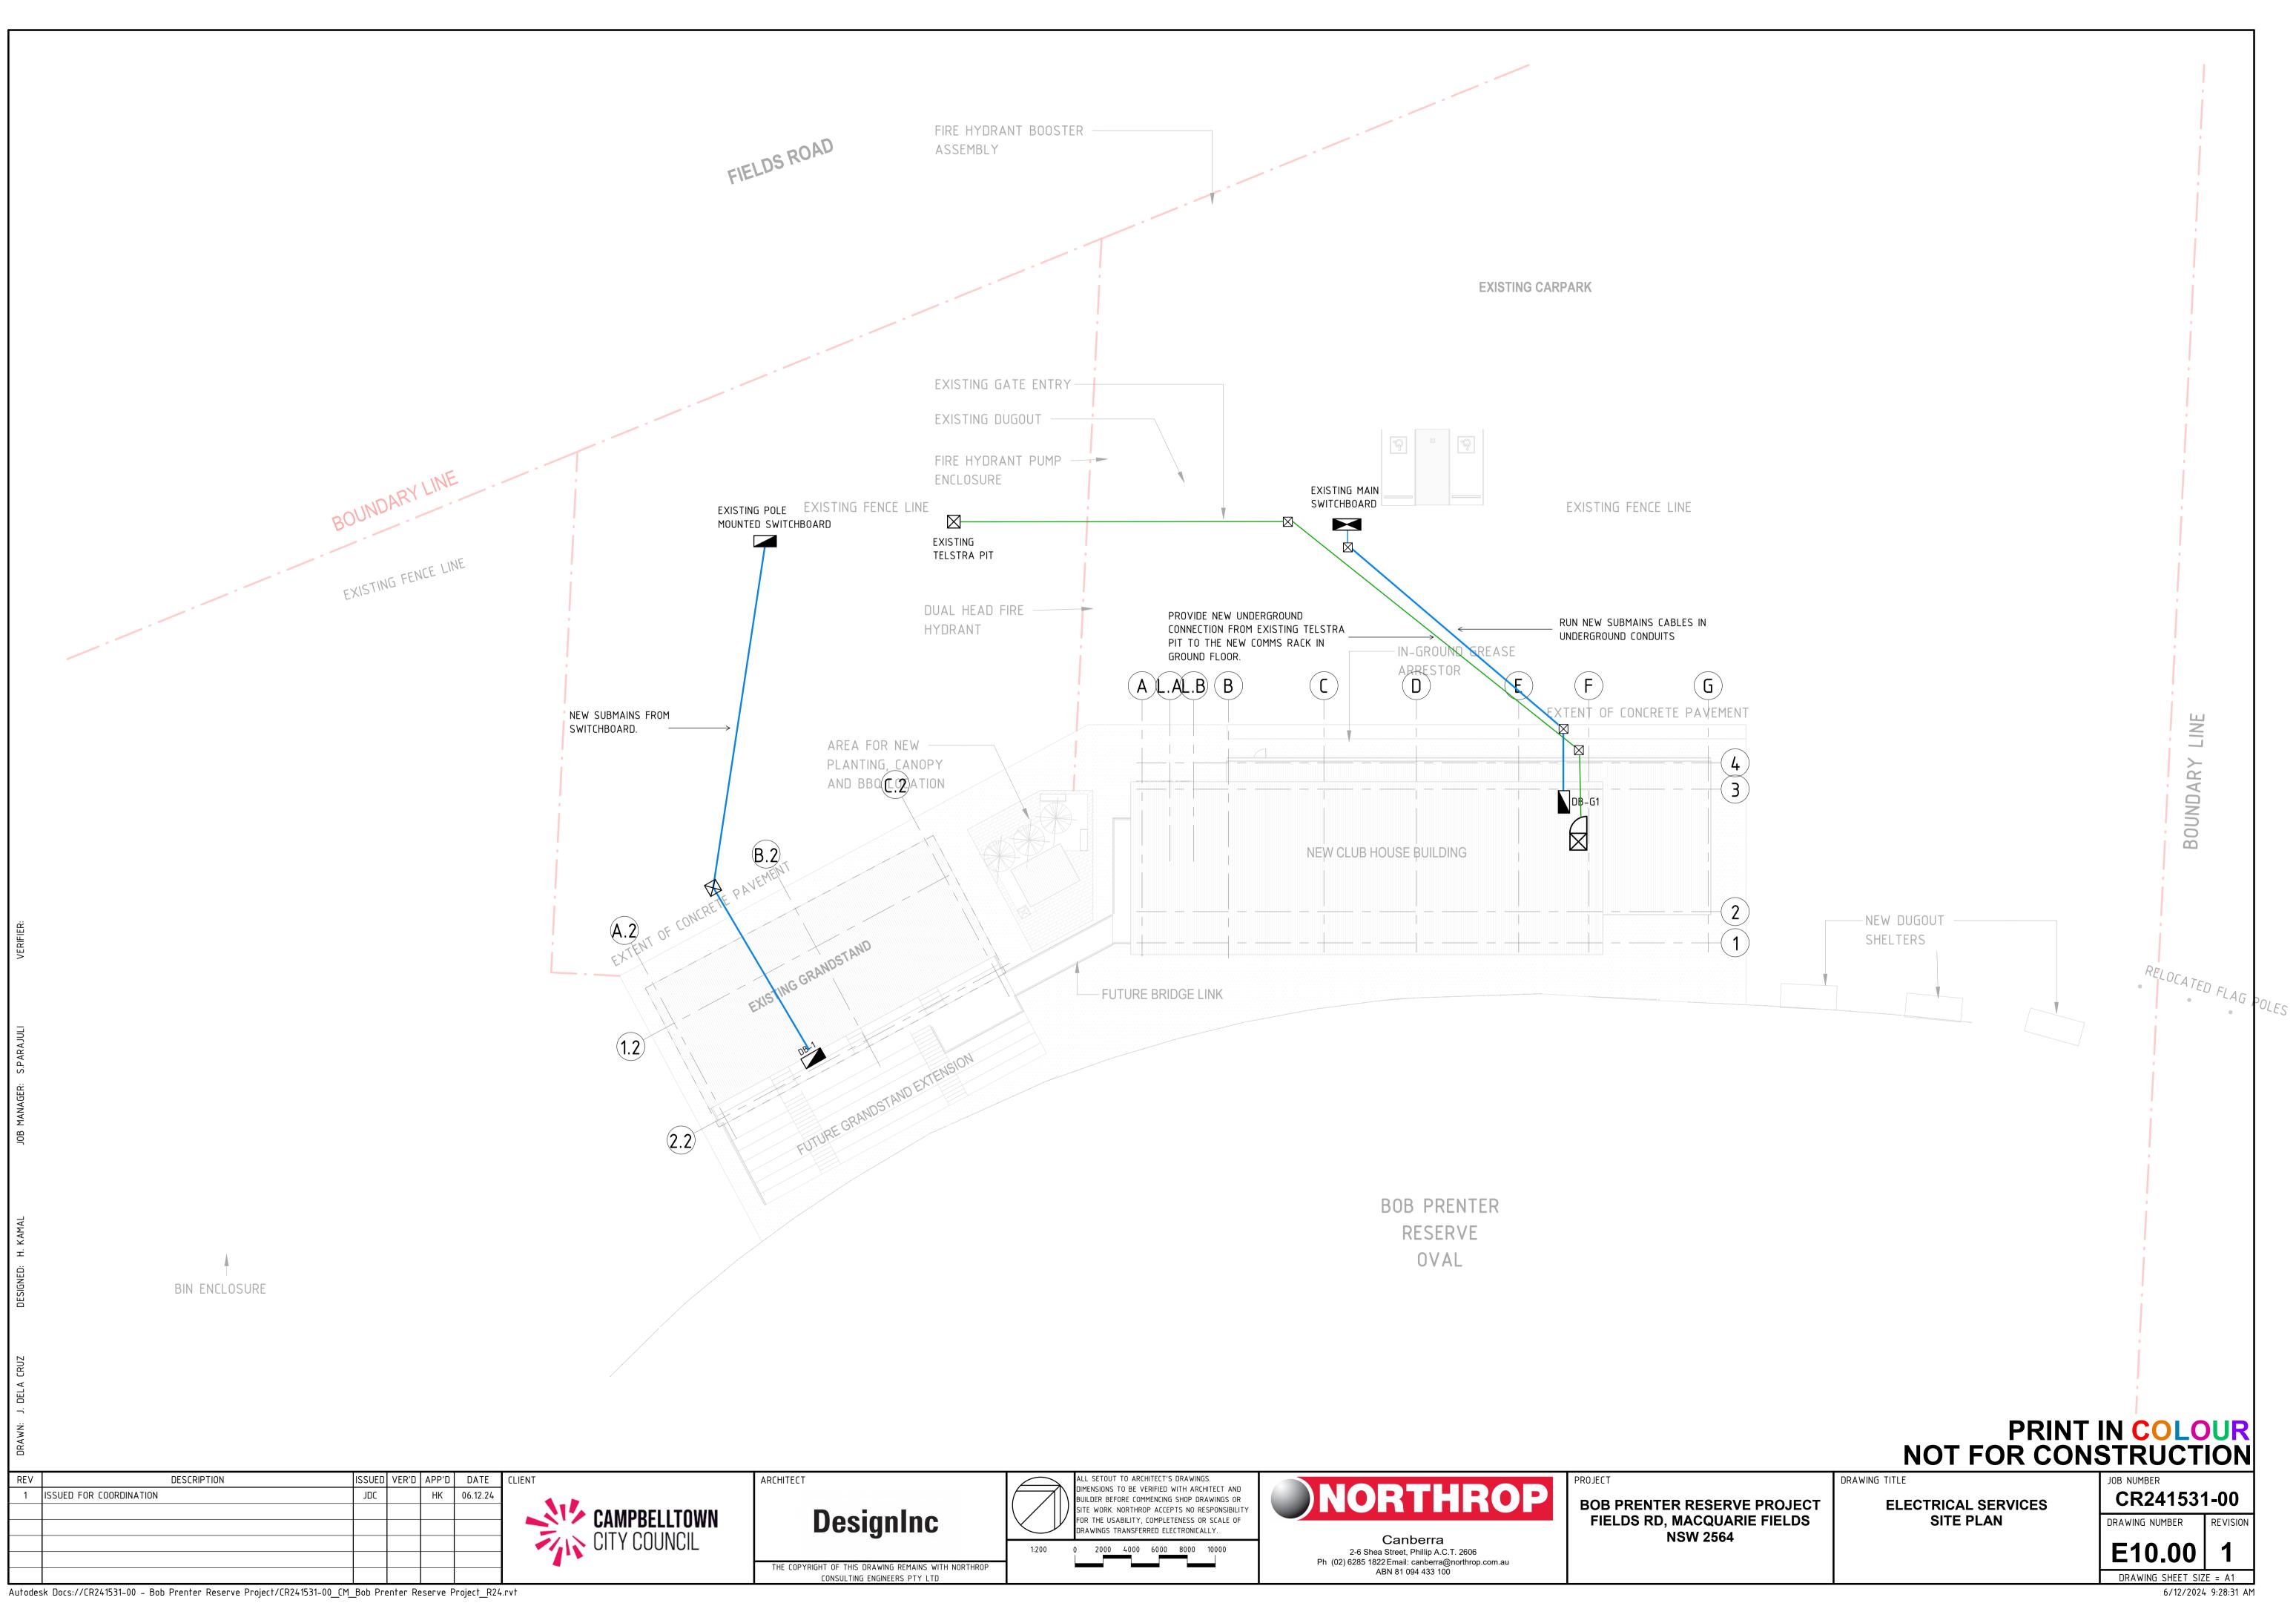

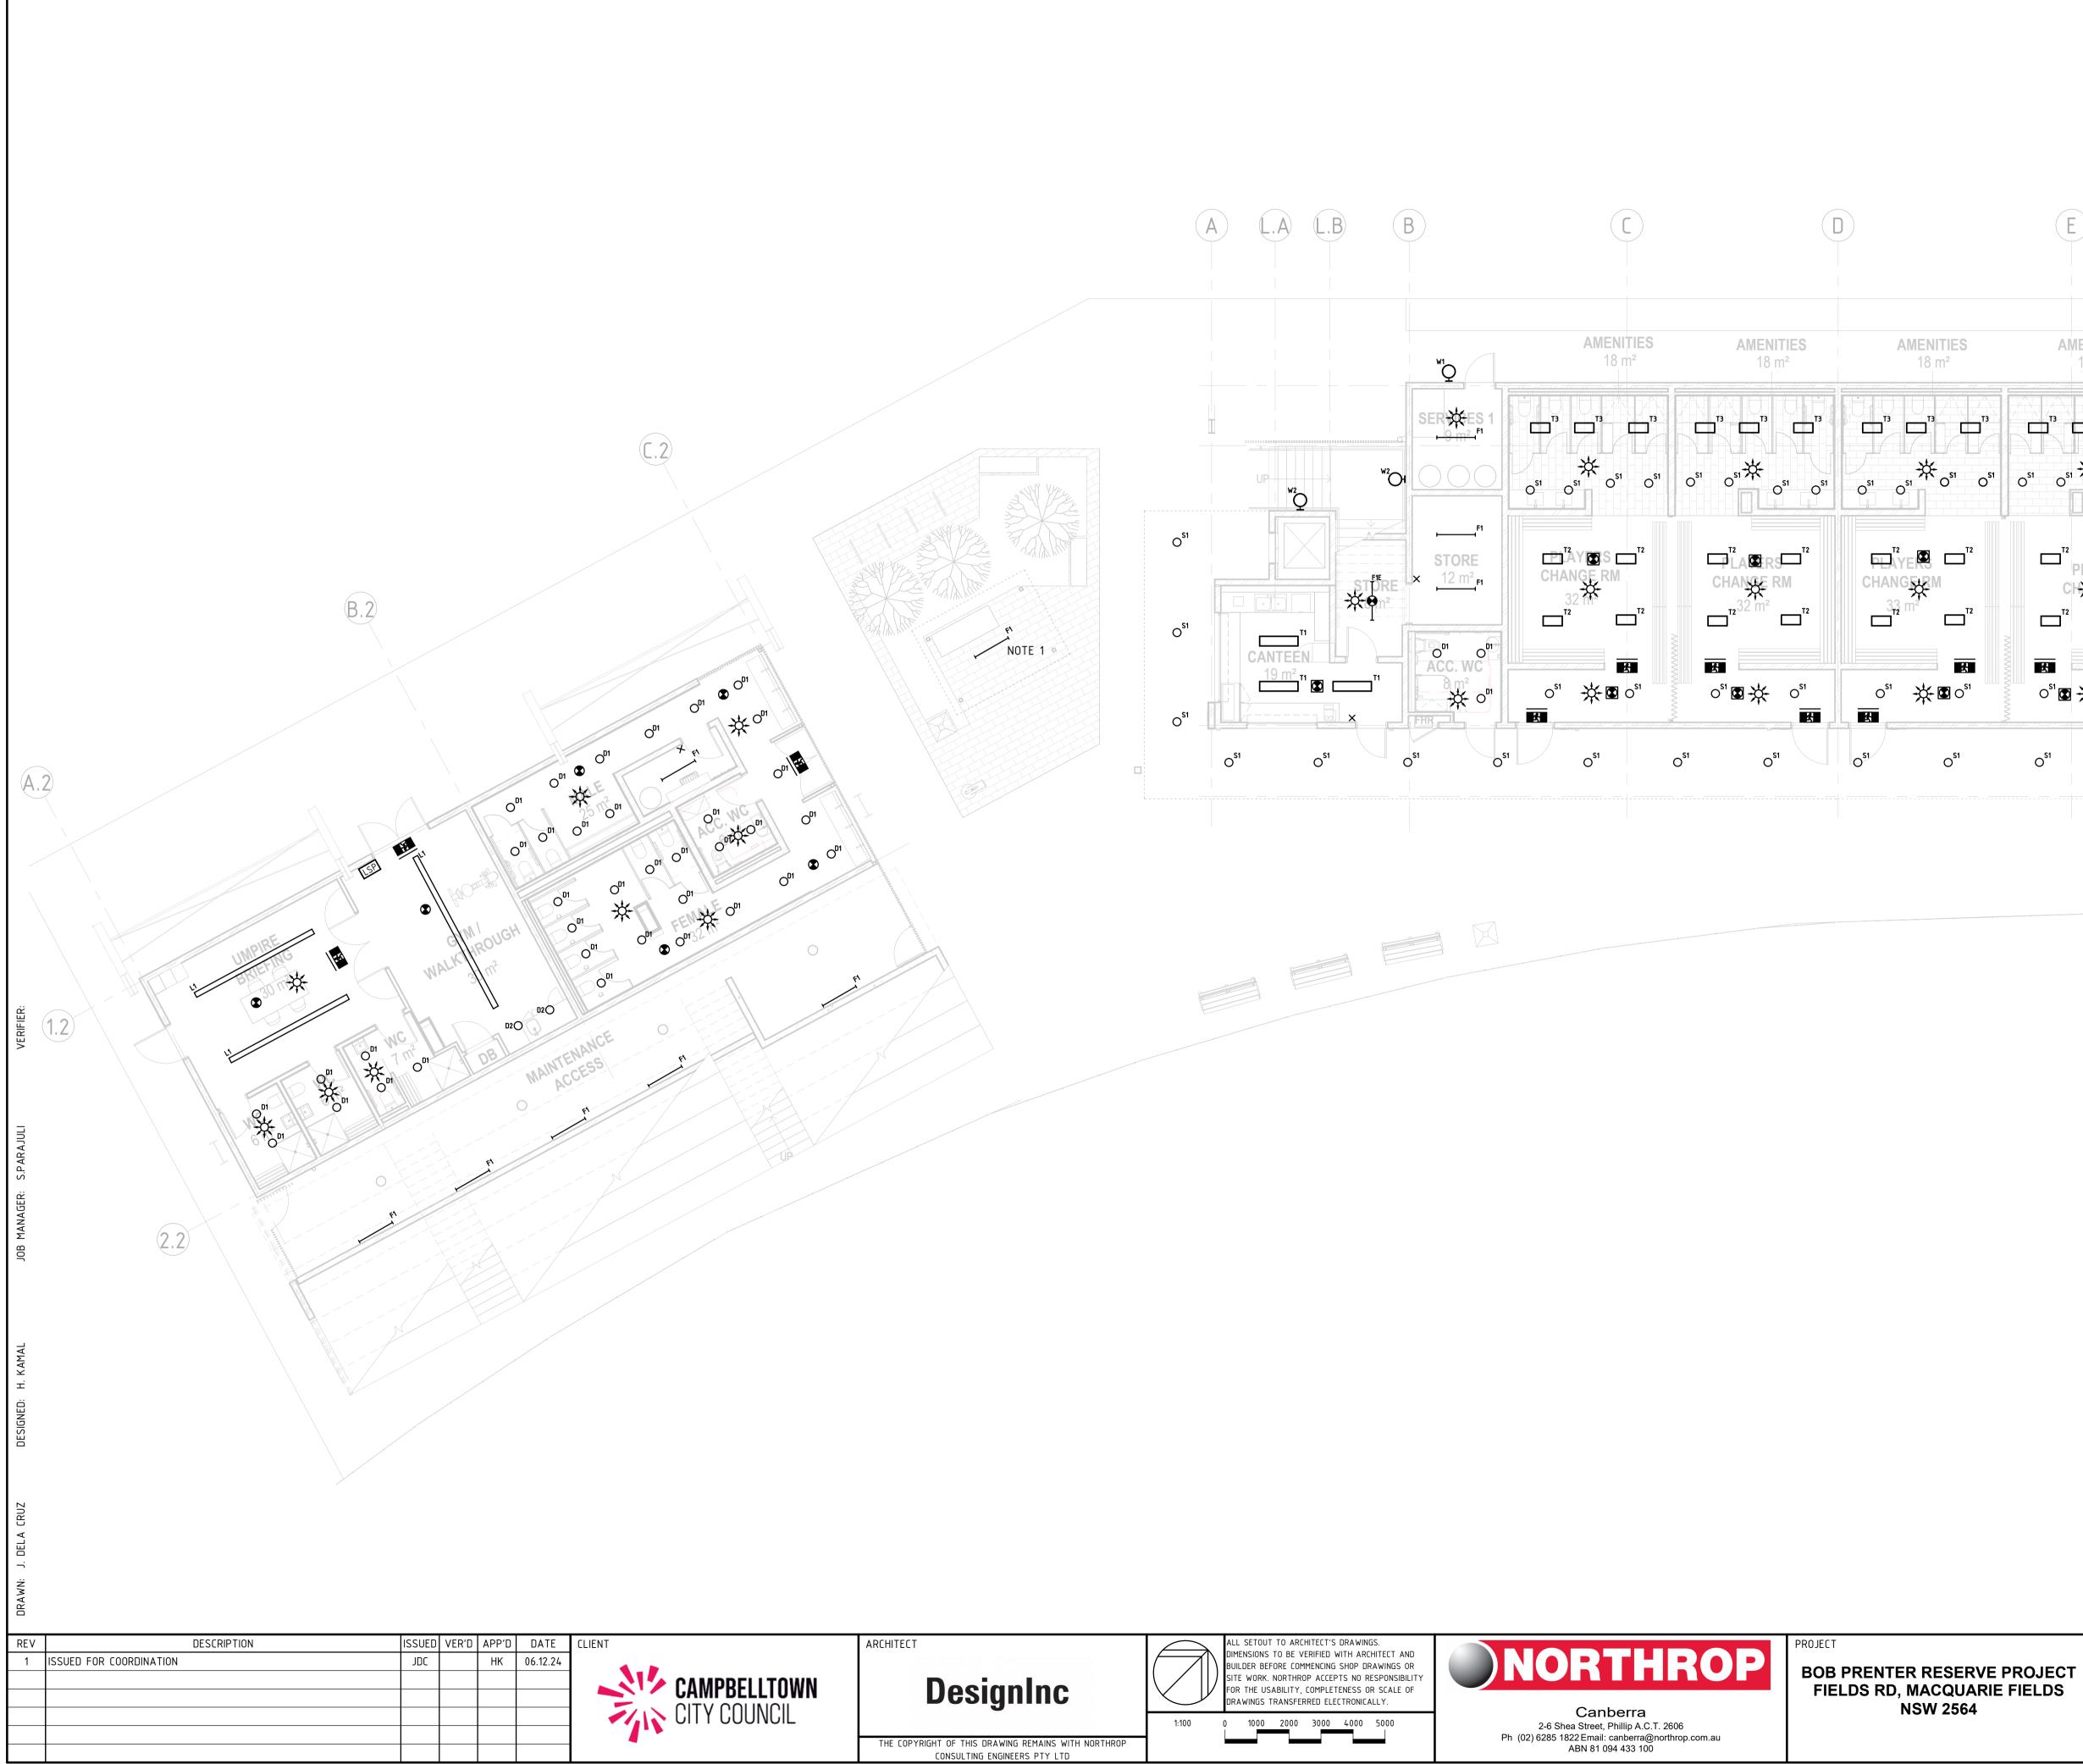



Autodesk Docs://CR241531-00 - Bob Prenter Reserve Project/CR241531-00\_CM\_Bob Prenter Reserve Project\_R24.rvt

esignInc		ALL SETOUT TO ARCHITECT'S DRAWINGS. DIMENSIONS TO BE VERIFIED WITH ARCHITECT AND BUILDER BEFORE COMMENCING SHOP DRAWINGS OR SITE WORK. NORTHROP ACCEPTS NO RESPONSIBILITY FOR THE USABILITY, COMPLETENESS OR SCALE OF DRAWINGS TRANSFERRED ELECTRONICALLY.	NORTHROP	PROJECT BOB PRENTE FIELDS RD,
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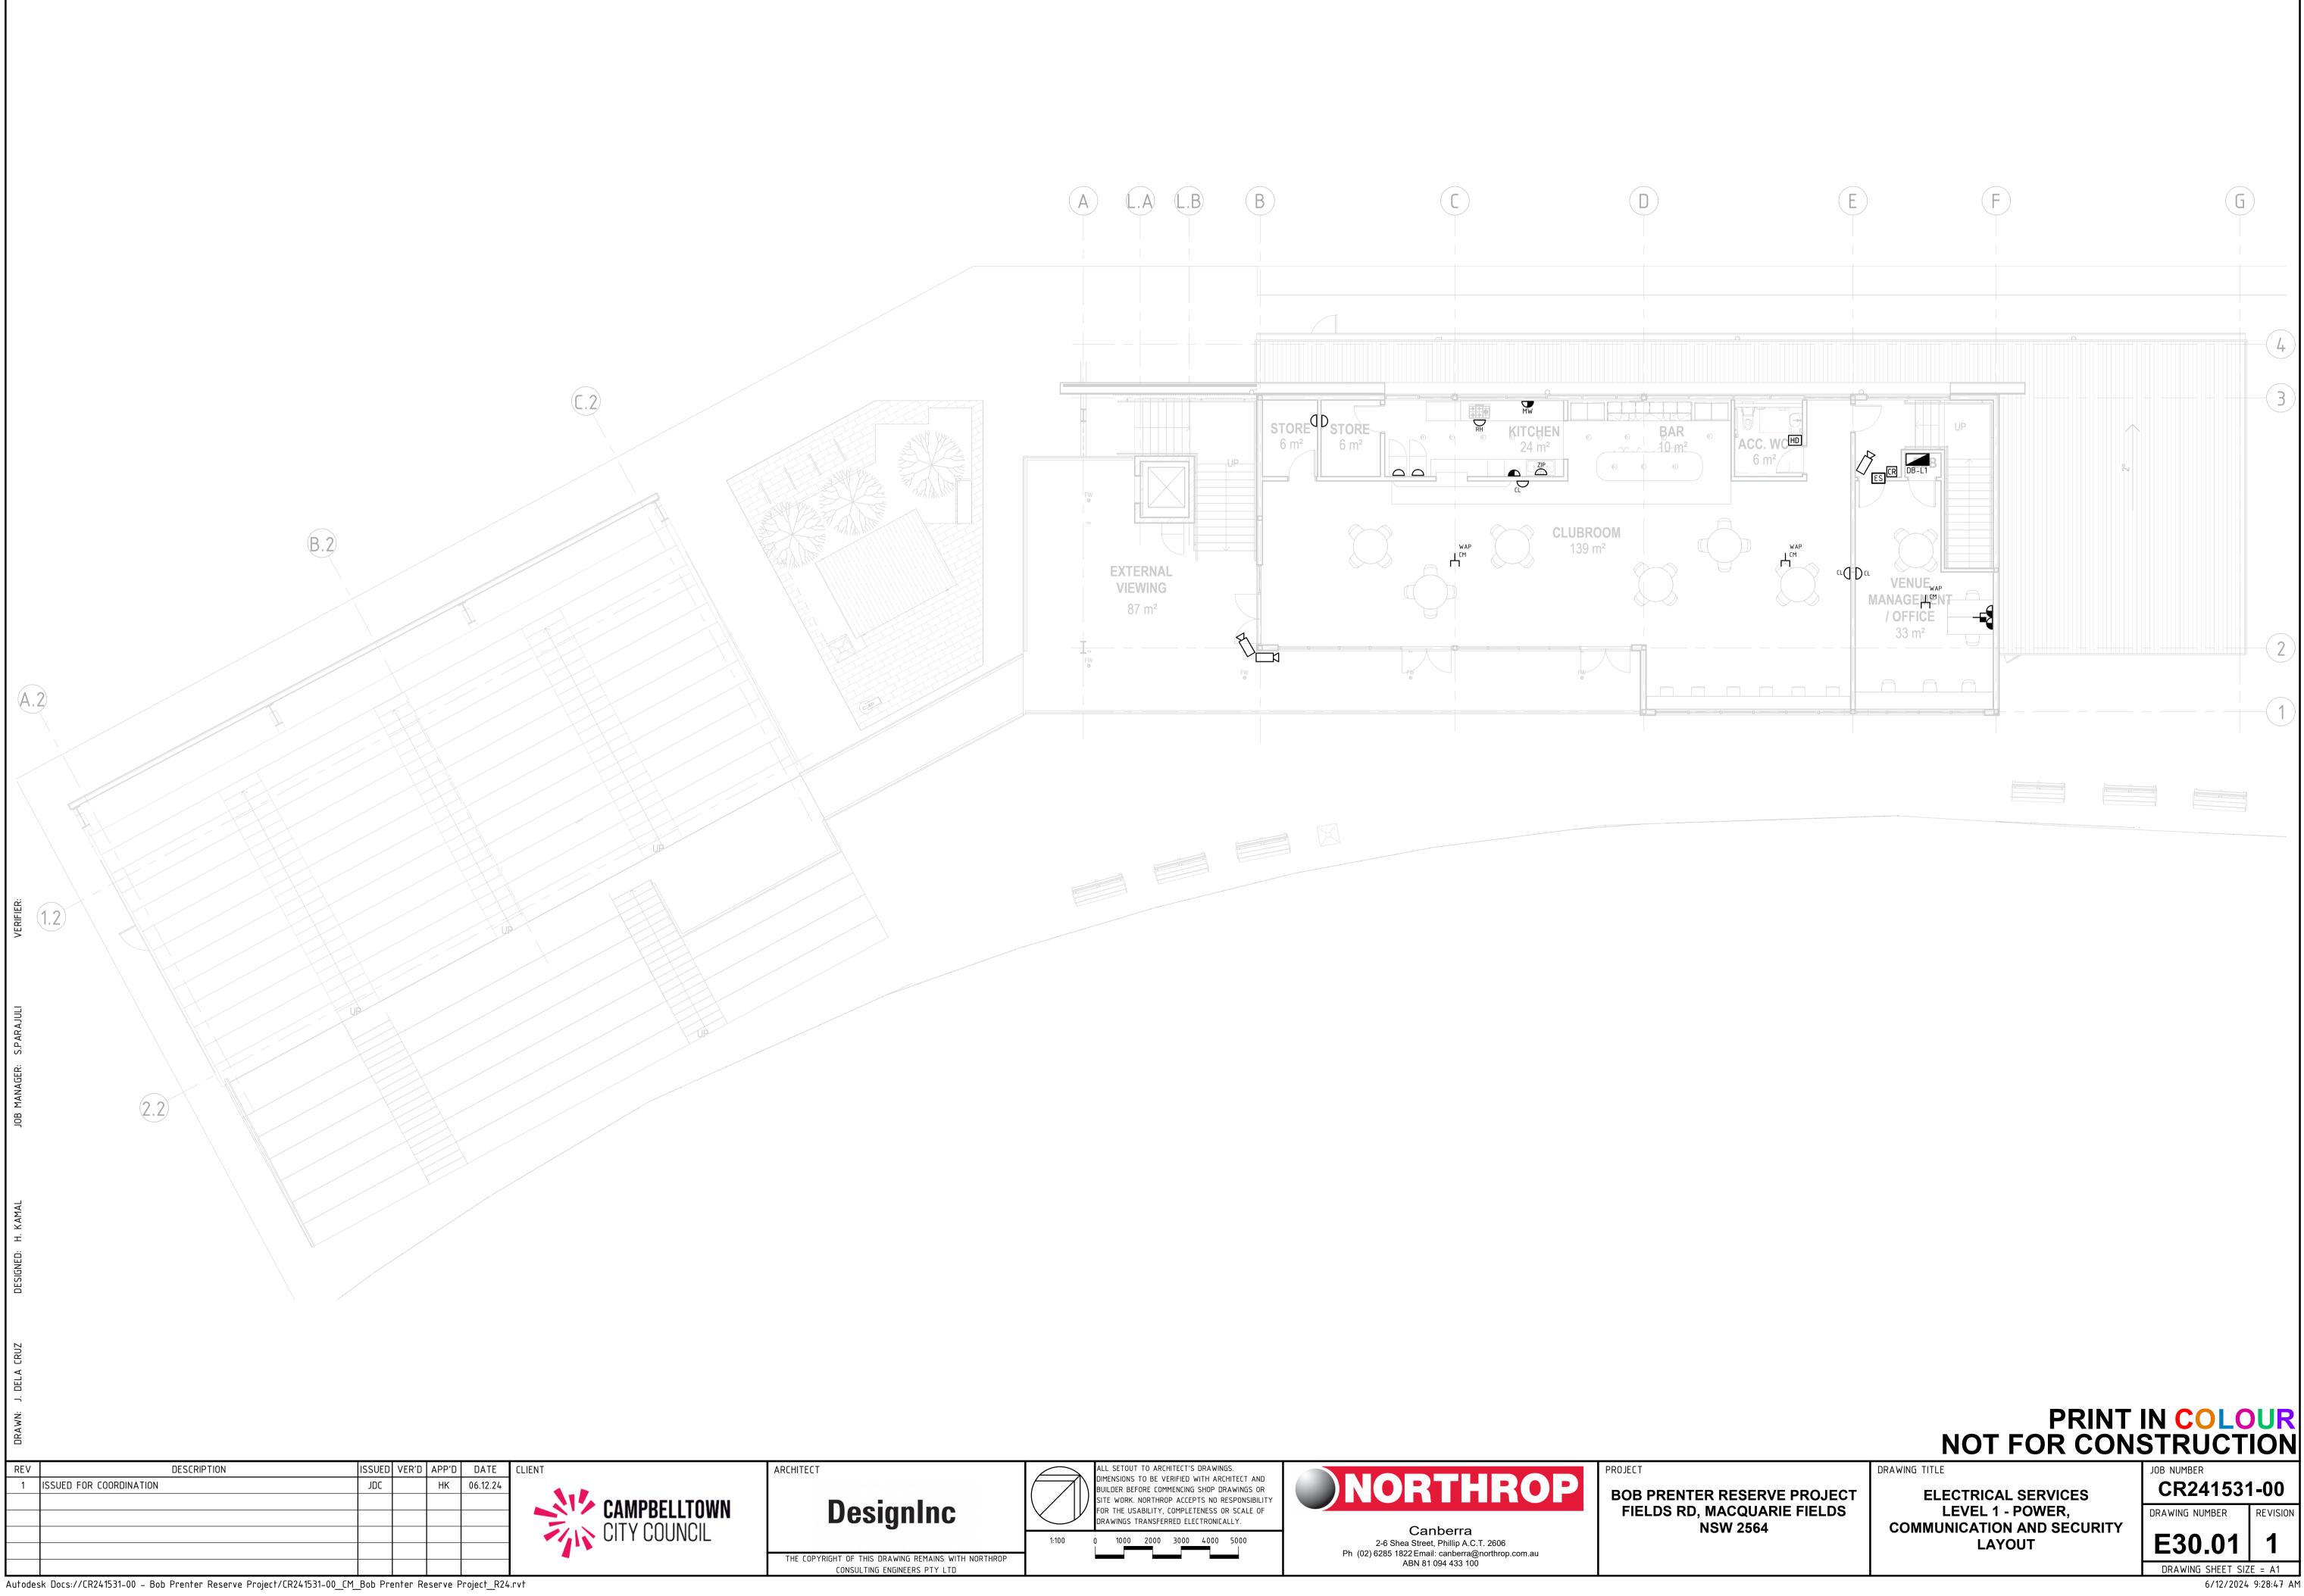
NOTE: 1. LIGHT UNDER THE CANOPY F G E **SERVICES 2** AMENITIES 17 m<sup>2</sup> 8 m² <sup>w1</sup>Q X Ю ТЭ 0<sup>\$1</sup> Ю CHARIGE RM **□**<sup>T2</sup> 32 -045 n<del>3</del> ✻ 23 o<sup>s1</sup> **☑** ⅔ o<sup>s1</sup> 0 2 A Ю O<sup>\$1</sup> PRINT IN COLOUR NOT FOR CONSTRUCTION DRAWING TITLE JOB NUMBER CR241531-00 ELECTRICAL SERVICES GROUND FLOOR LIGHTING LAYOUT DRAWING NUMBER REVISION


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F THIS DRAWING REMAINS WITH NORTHROP	1:100	0 1000 2000 3000 4000 5000	Canberra 2-6 Shea Street, Phillip A.C.T. 2606 Ph (02) 6285 1822 Email: canberra@northrop.com.au ABN 81 094 433 100	

# **BOB PRENTER RESERVE PROJECT** FIELDS RD, MACQUARIE FIELDS NSW 2564 HYDRAULIC SERVICES

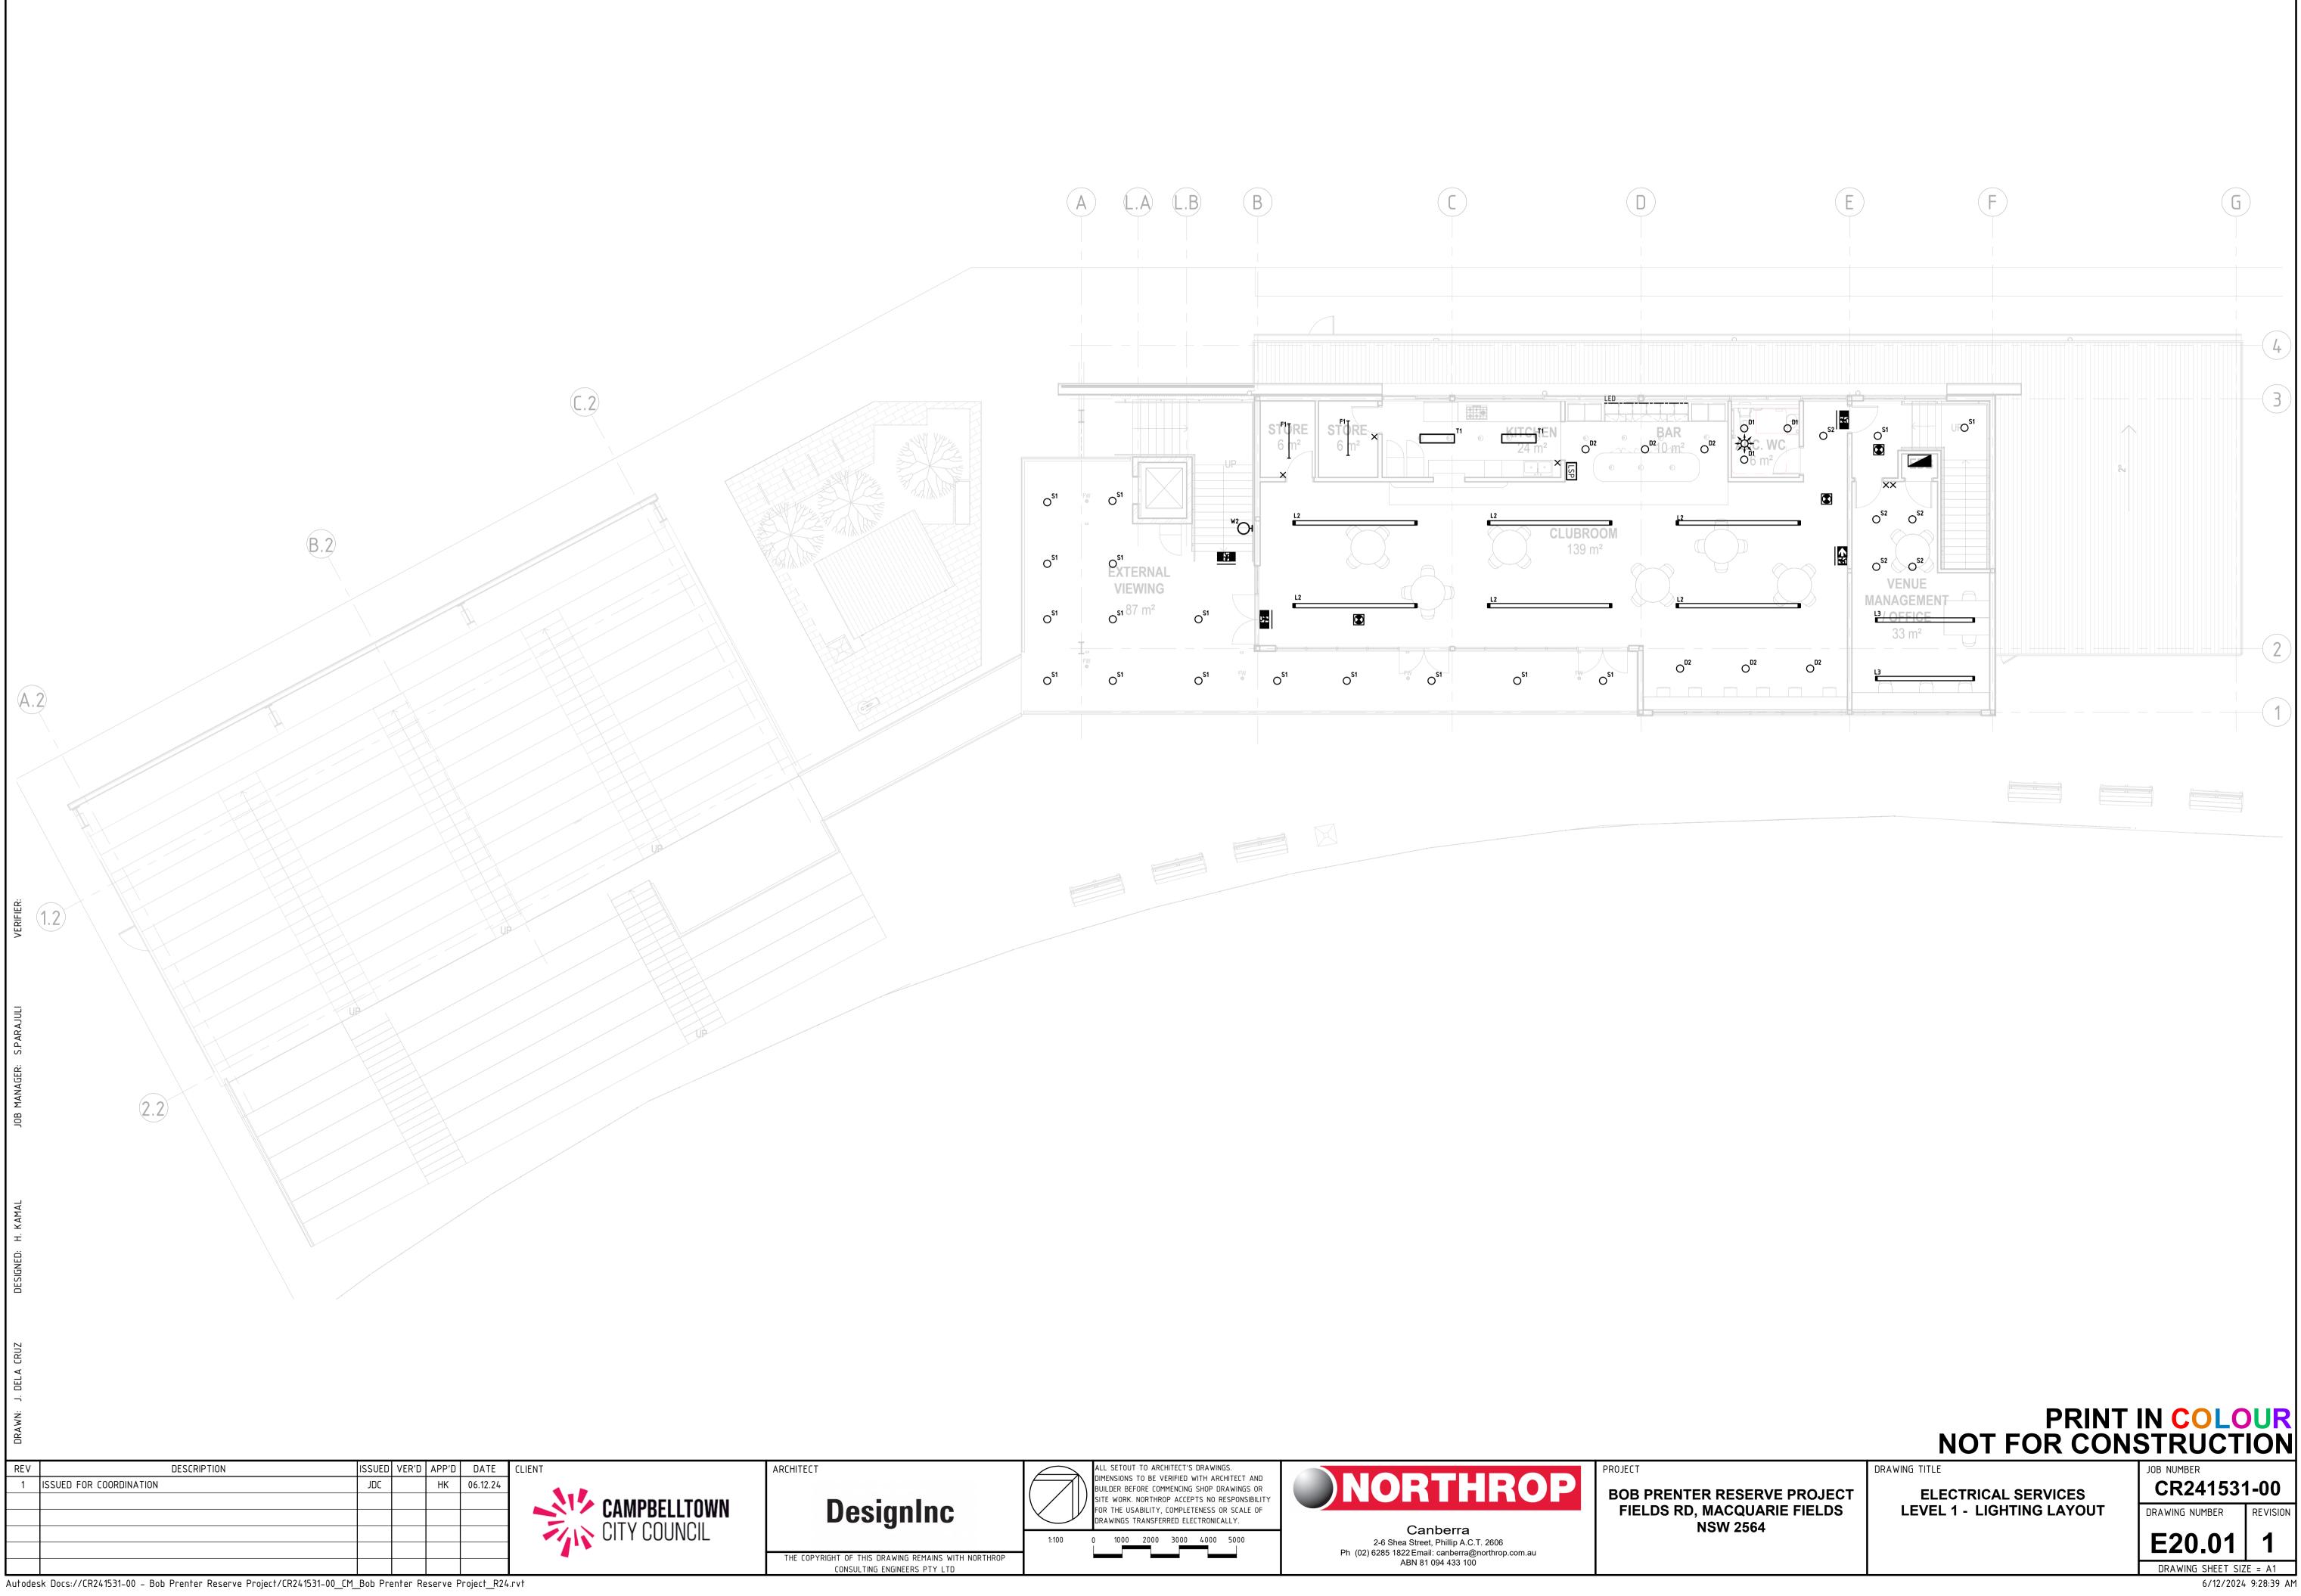

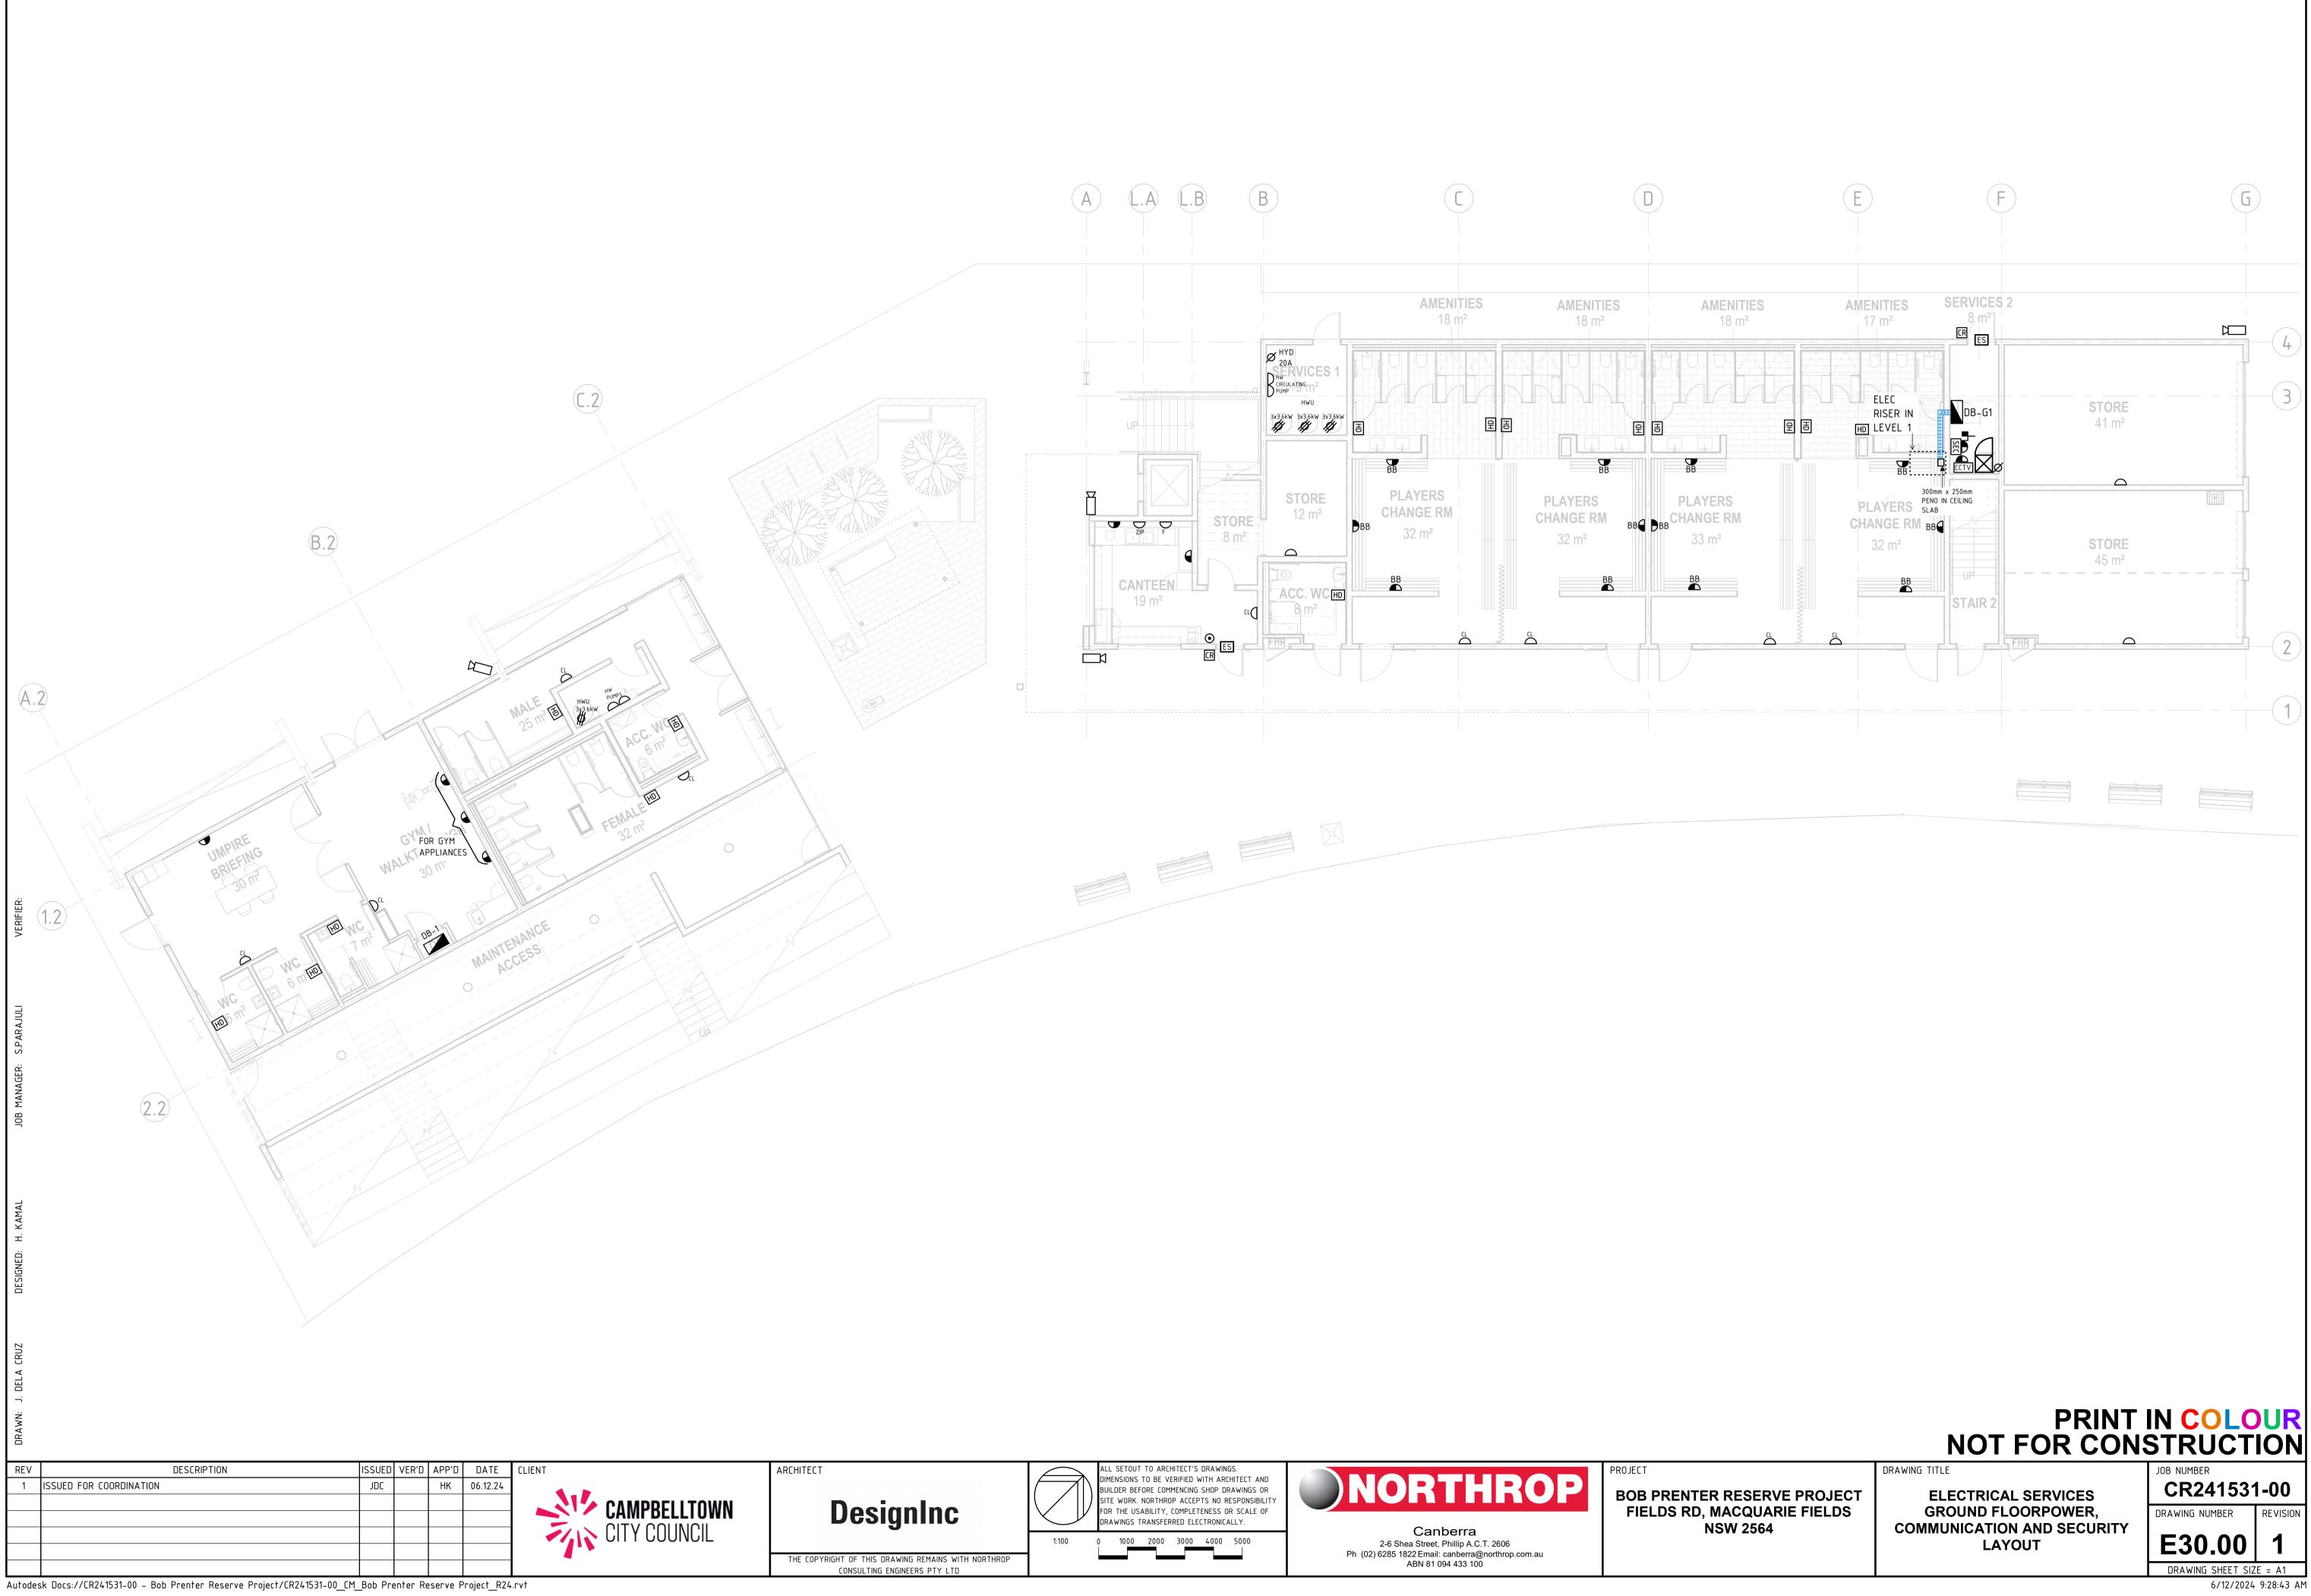REV	DESCRIPTION	ISSUED	VER'D	APP'D	DATE	CLIENT	ARCHITECT
1	ISSUED FOR COORDINATION	BP		GL	06.12.24		
						<b>CAMPBELLTOWN</b>	DesignIne
							DesignInc
						CITY COUNCIL	•
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**BOB PRENTER RESERVE PROJECT** FIELDS RD, MACQUARIE FIELDS NSW 2564

PROJECT
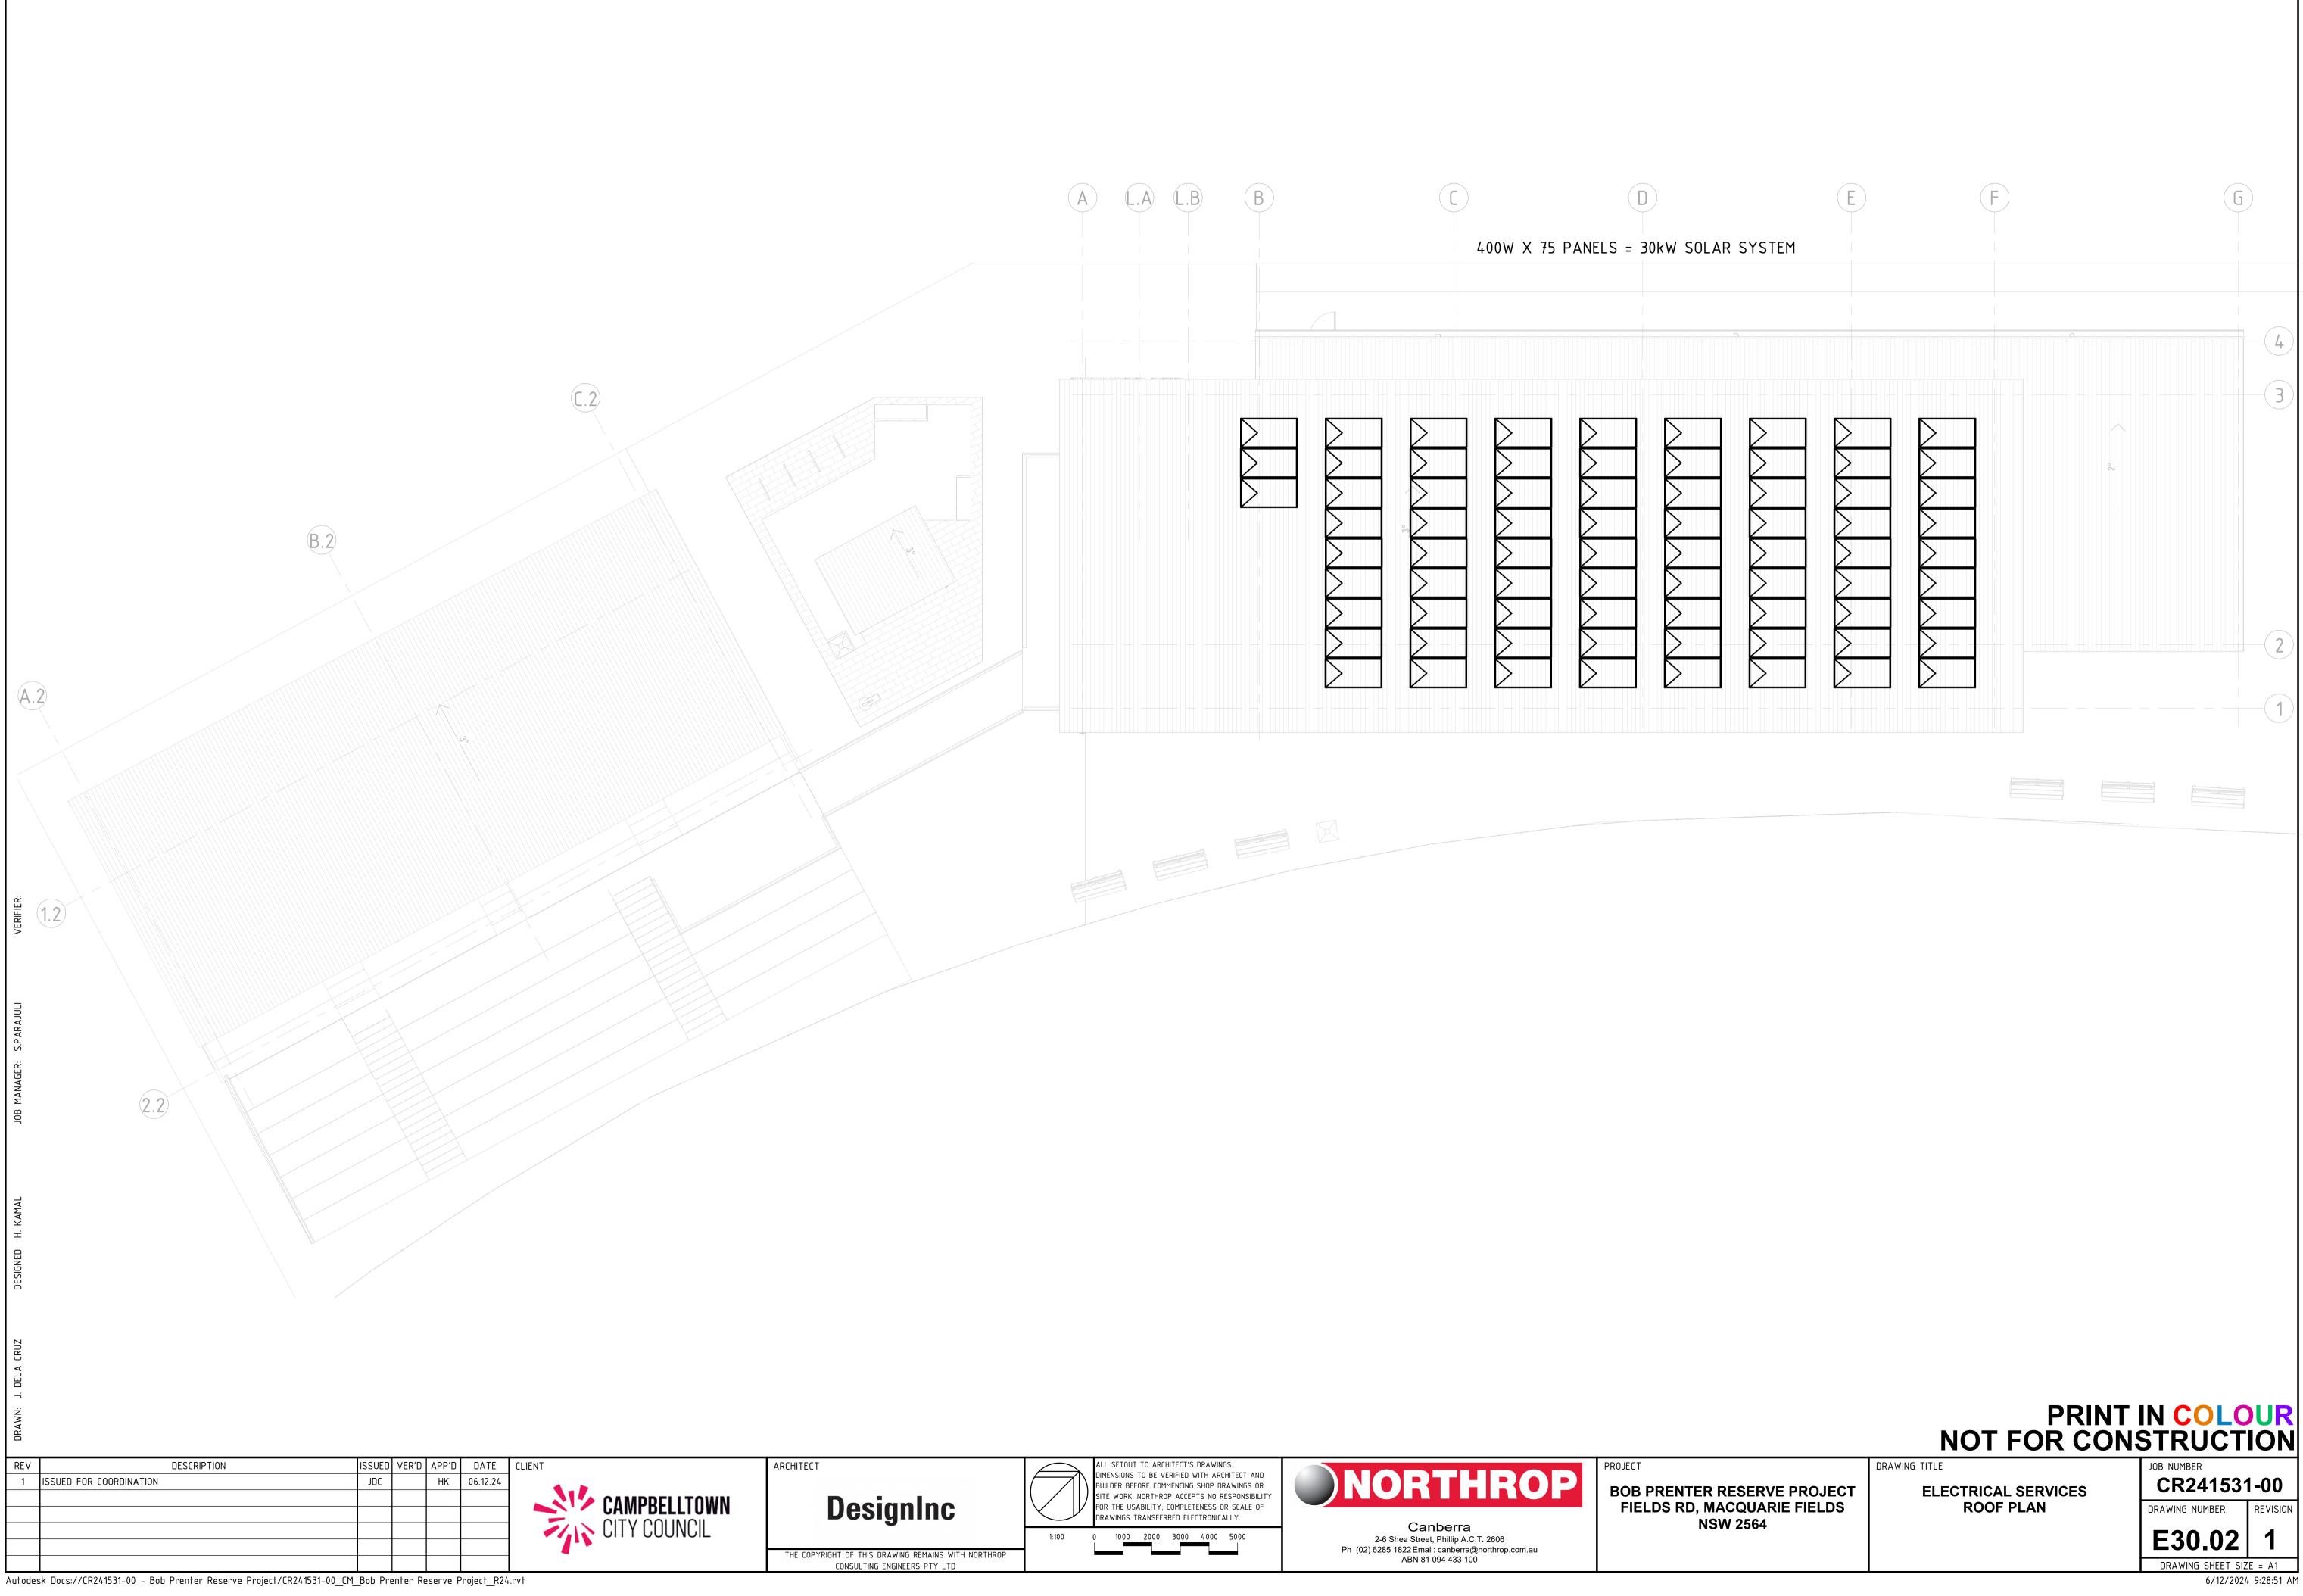
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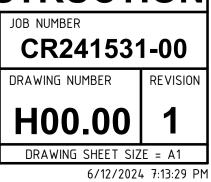
#### HYDRAULIC SERVICES DRAWING ...

DWG No.	DRAWING TITLE
H00.00	COVER SHEET AND DRAWING SCHEDULE
H00.01	LEGEND OF SYMBOLS AND NOTES
H10.00	SITE PLAN
H20.00	GROUND FLOOR - DRAINAGE LAYOUT
H20.01	LEVEL 1 – DRAINAGE LAYOUT
H20.02	ROOF – DRAINAGE LAYOUT
H30.00	GROUND FLOOR - PRESSURE LAYOUT
H30.01	LEVEL 1 – PRESSURE LAYOUT
H70.00	DETAILS SHEET 1
H70.01	DETAILS SHEET 2



DRAWING TITLE

HYDRAULIC SERVICES COVER SHEET AND DRAWING SCHEDULE



	ABBREVIATIONS	
AAV	AIR ADMITTANCE VALVE	
BT	BASKET TRAP	
CL	COVER LEVEL	
C0	CLEAR OUT	
Cu.	COPPER	
[/S		
CW		
)P		
EJ	EXPANSION JOINT	
=FL =u	FINISHED FLOOR LEVEL FIRE HYDRANT	
FH FHR	FIRE HOSE REEL	
FW	FLOOR WASTE	
GM	GAS METER	
GMS	GALVANISED MILD STEEL	
=U	FIXTURE UNITS	
HER	HIGH END RISER	
HT	HOSE TAP	
	HEAVY DUTY	
HDPE	HIGH DENSITY POLYETHYLENE	
HW	HOT WATER	
HWF	HOT WATER FLOW	
HWR	HOT WATER RETURN	
IL	INVERT LEVEL	
10	INSPECTION OPENING	
S	INSPECTION SHAFT	
_IT	LEVEL INVERT TAPER REDUCER	
NPCW	NON POTABLE COLD WATER	
D/F	OVER FLOW	
DRG	OVERFLOW RELIEF GULLY	
20	PLANTER OUTLET	
80	REVERSE OSMOSIS	
2W0	RAINWATER OUTLET	
RPZD	REDUCED PRESSURE ZONE DEVICE	
RV	REFLUX VALVE RAW WATER	
RW SC	STOP COCK	
SD	SEWER DRAIN	
SMH	SEWER MANHOLE	
SRM	SEWER RISING MAIN	
ST	SILT TRAP	
SV	STOP VALVE	
SVP	SEWER VENT PIPE	
SW	STORMWATER	
SWMH	STORMWATER MAN HOLE	
SWRM	STORMWATER RISING MAIN	
ТВ	THRUST BLOCK	
TD	TUNDISH	
TDCV	TESTABLE DOUBLE CHECK VALVE	
TMV	THERMOSTATIC MIXING VALVE	
TTD	TRAPPED TUNDISH	
ΤW	TRADE WASTE	
TWV	TRADE WASTE VENT	
U/B	UNDER BENCH	
UPVC	UNPLASTICISED POLYVINYL CHLORIDE	
VJU	VERTICAL JUMP UP	
VP	VENT PIPE	
WM	WATER METER	
WWF	WARM WATER FLOW	
WWR	WARM WATER RETURN	

٥	◄ ISOLATION VALVE	• wc	WATER CLOSET
۲	$oldsymbol{\Theta}$ isolation valve in path box	• UR	URINAL
Þ	■ BALL VALVE	• <sub>td</sub>	TUNDISH
Þ	₩ GATE VALVE	• <sub>ttd</sub>	TRAPPED TUNDIS
Þ	■ GLOBE VALVE	• <sub>sk</sub>	SINK
L	BUTTERFLY VALVE	ST	SILT TRAP
Þ	∽ NON RETURN VALVE	⊘ SHR	SHOWER
	DOUBLE VALVE	Ø	OVERFLOW RELIEF
E	REDUCED PRESSURE ZONE DEVICE	• <sub>T</sub>	LAUNDRY TAB
L	A REFLUX VALVE	• 10	INSPECTION OPEN
٢	<pre> FLAP VALVE </pre>	⊘ IPMF	INDUCT PIPE MICA
Þ	GAS ISOLATION VALVE	ø <sub>FW</sub>	FLOOR WASTE
5	GAS PRESSURE REGULATOR VALVE	Ø <sub>DT</sub>	DISCONNECTOR GU
	PRESSURE REDUCING VALVE	• co	CLEAROUT
C	■ RATIO REDUCTION VALVE	• <sub>cs</sub>	CLEANER'S SINK
Þ	PRESSURE LIMITING VALVE	_	BUCKET TRAP FL
	PRESSURE RELIEF VALVE	• <sub>bt</sub>	BOUNDARY TRAP
1	✓ BALANCING VALVE	• bth	BATH
Þ	<pre> FLOAT VALVE </pre>	• <sub>B</sub>	BASIN
ļ	MONITORED VALVE		FLOW DIRECTION
ļ	SOLENOID VALVE	O+	HOSE TAP RISE
[	FLOW SENSOR	\$+ HT	HOSE TAP DROP
E	S FLOW SWITCH	Э+ НТ	HOSE TAP DROP
(	PRESSURE SENSOR	MM N	WATER METER
E	과 PRESSURE SWITCH	GM	GAS METER
[	TEMPERATURE SENSOR		TEMPERING VALVI
¢	PRESSURE GAUGE	TMV	THERMOSTATIC MI
C	♥ TEMPERATURE GAUGE	CH/BWU	CHILLED AND BOIL
			BOILING WATER U
		BWU DW	DISH WASHER

DESCRIPTION	ISSUED	VER'D	APP'D	DATE	CLIENT	ARCHITECT
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# R CLOSET PED TUNDISH LOW RELIEF GULLY

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HY101

SWMH

DRY TAB TION OPENING t pipe mica flap **WASTE** NNECTOR GULLY

IER'S SINK T TRAP FLOOR WASTE DARY TRAP

DIRECTION TAP RISE TAP DROP TEE

RING VALVE

IOSTATIC MIXING VALVE

D AND BOILING WATER UNIT

G WATER UNIT

DRAINAGE OUTLET SETOUT BOX GUTTER GRATED TRENCH DRAIN DOWNPIPE SPREADER RAINWATER OUTLET PLANTER OUTLET BALCONY OUTLET RAINWATER HEAD GRATED STORMWATER PIT CONCRETE INFILL STORMWATER PIT SEWER MANHOLE

DRAWING CONTINUATION

STORMWATER MANHOLE

750L GREASE ARRESTOR

# LINETYPES

		AUTHORITY SEWER
		SEWER DRAINAGE
		SANITARY PLUMBING
		TRADEWASTE
		STORMWATER DRAINAGE
		SUBSOIL DRAINAGE
		SANITARY VENT
		RAINWATER
		RISING SEWER MAIN
		RISING STORMWATER MAIN
		COLD WATER SERVICES
		HOT WATER SERVICE
		HOT WATER RETURN
		WARM WATER
		NON POTABLE WATER
		GAS SERVICE
		FIRE HYDRANT SERVICE
		FIRE HOSE REEL SERVICE
		FIRE SPRINKLER SERVICE
		SYPHONIC
		TEST DRAIN
ее	-e	EXISTING SERVICES
eW	-e W	EXISTING WATER MAIN
eS	-eS	EXISTING SEWER MAIN
—eSW——	-eSW	EXISTING STORMWATER MAIN
eG	-eG	EXISTING GAS MAIN

#### PIPEWORK

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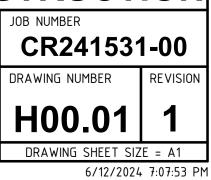
PROJECT


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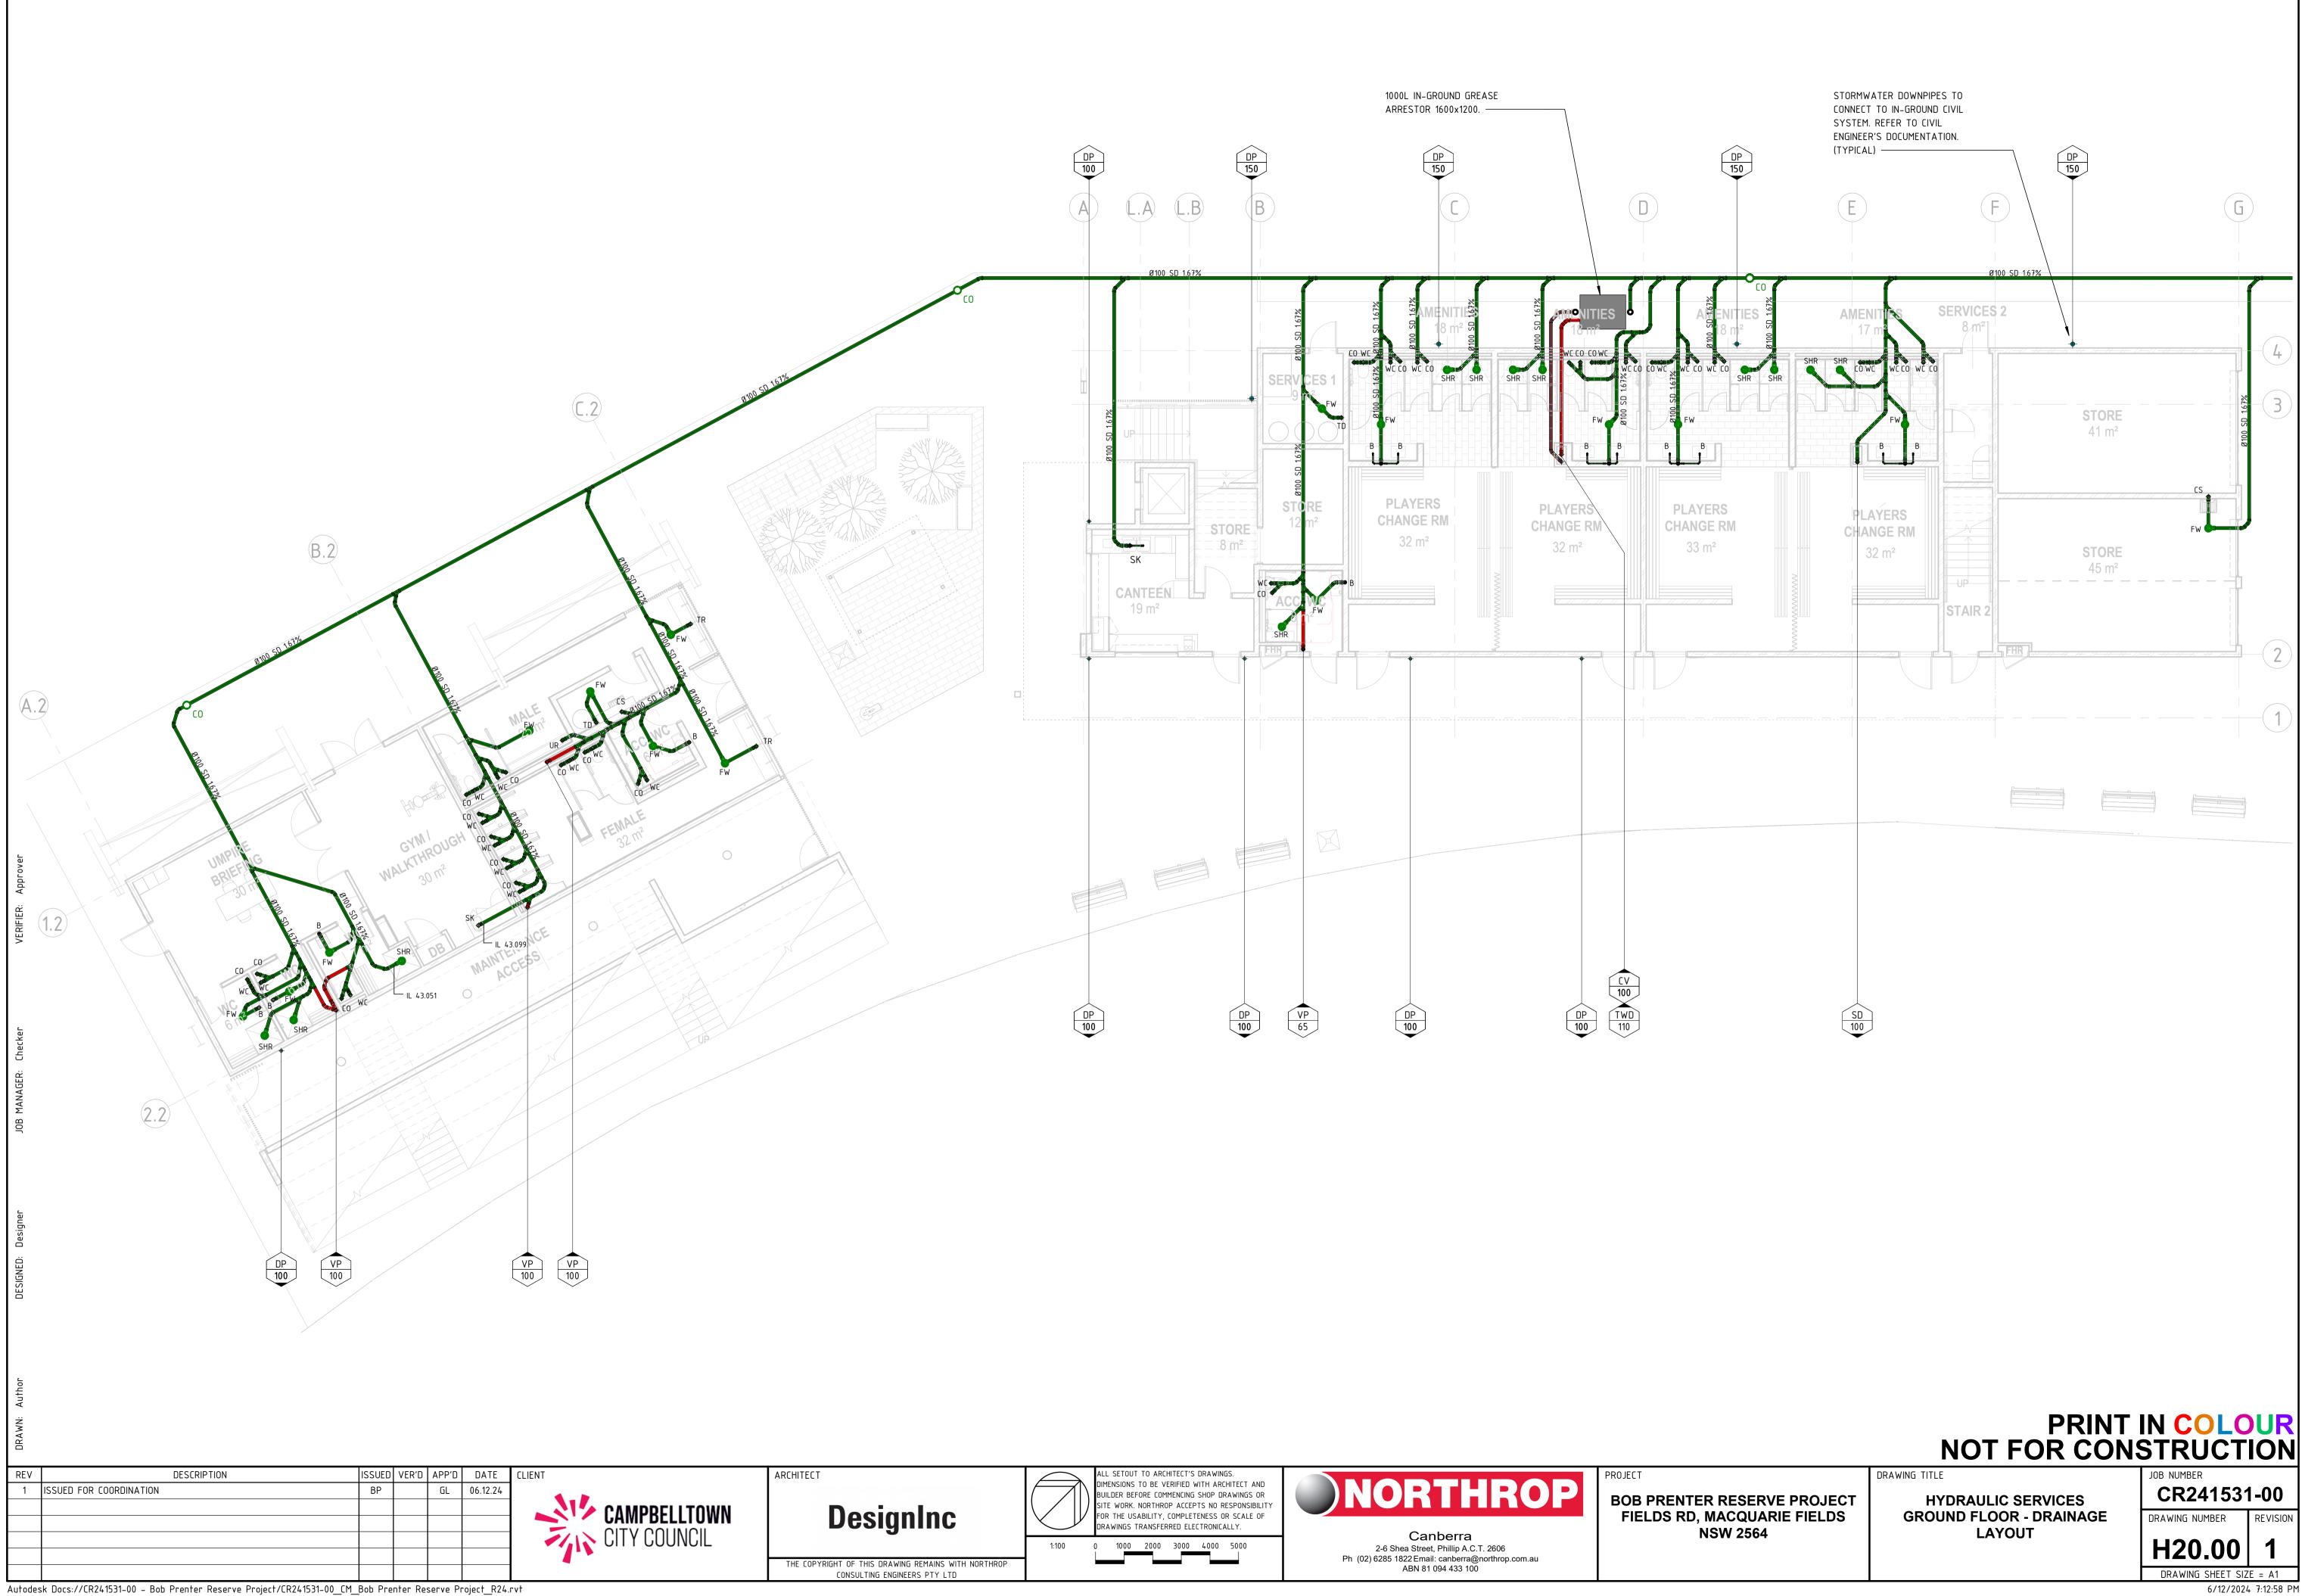
#### AUTHORITY SEWER SEWER DRAINAGE SANITARY PLUMBING TRADEWASTE STORMWATER DRAINAGE SUBSOIL DRAINAGE SANITARY VENT RAINWATER RISING SEWER MAIN RISING STORMWATER MAIN COLD WATER SERVICES HOT WATER SERVICE HOT WATER RETURN warm water NON POTABLE WATER GAS SERVICE 8 FIRE HYDRANT SERVICE FIRE HOSE REEL SERVICE - 9 - 3 FIRE SPRINKLER SERVICE - 9 SYPHONIC \_\_\_\_\_ TEST DRAIN EXISTING SERVICES

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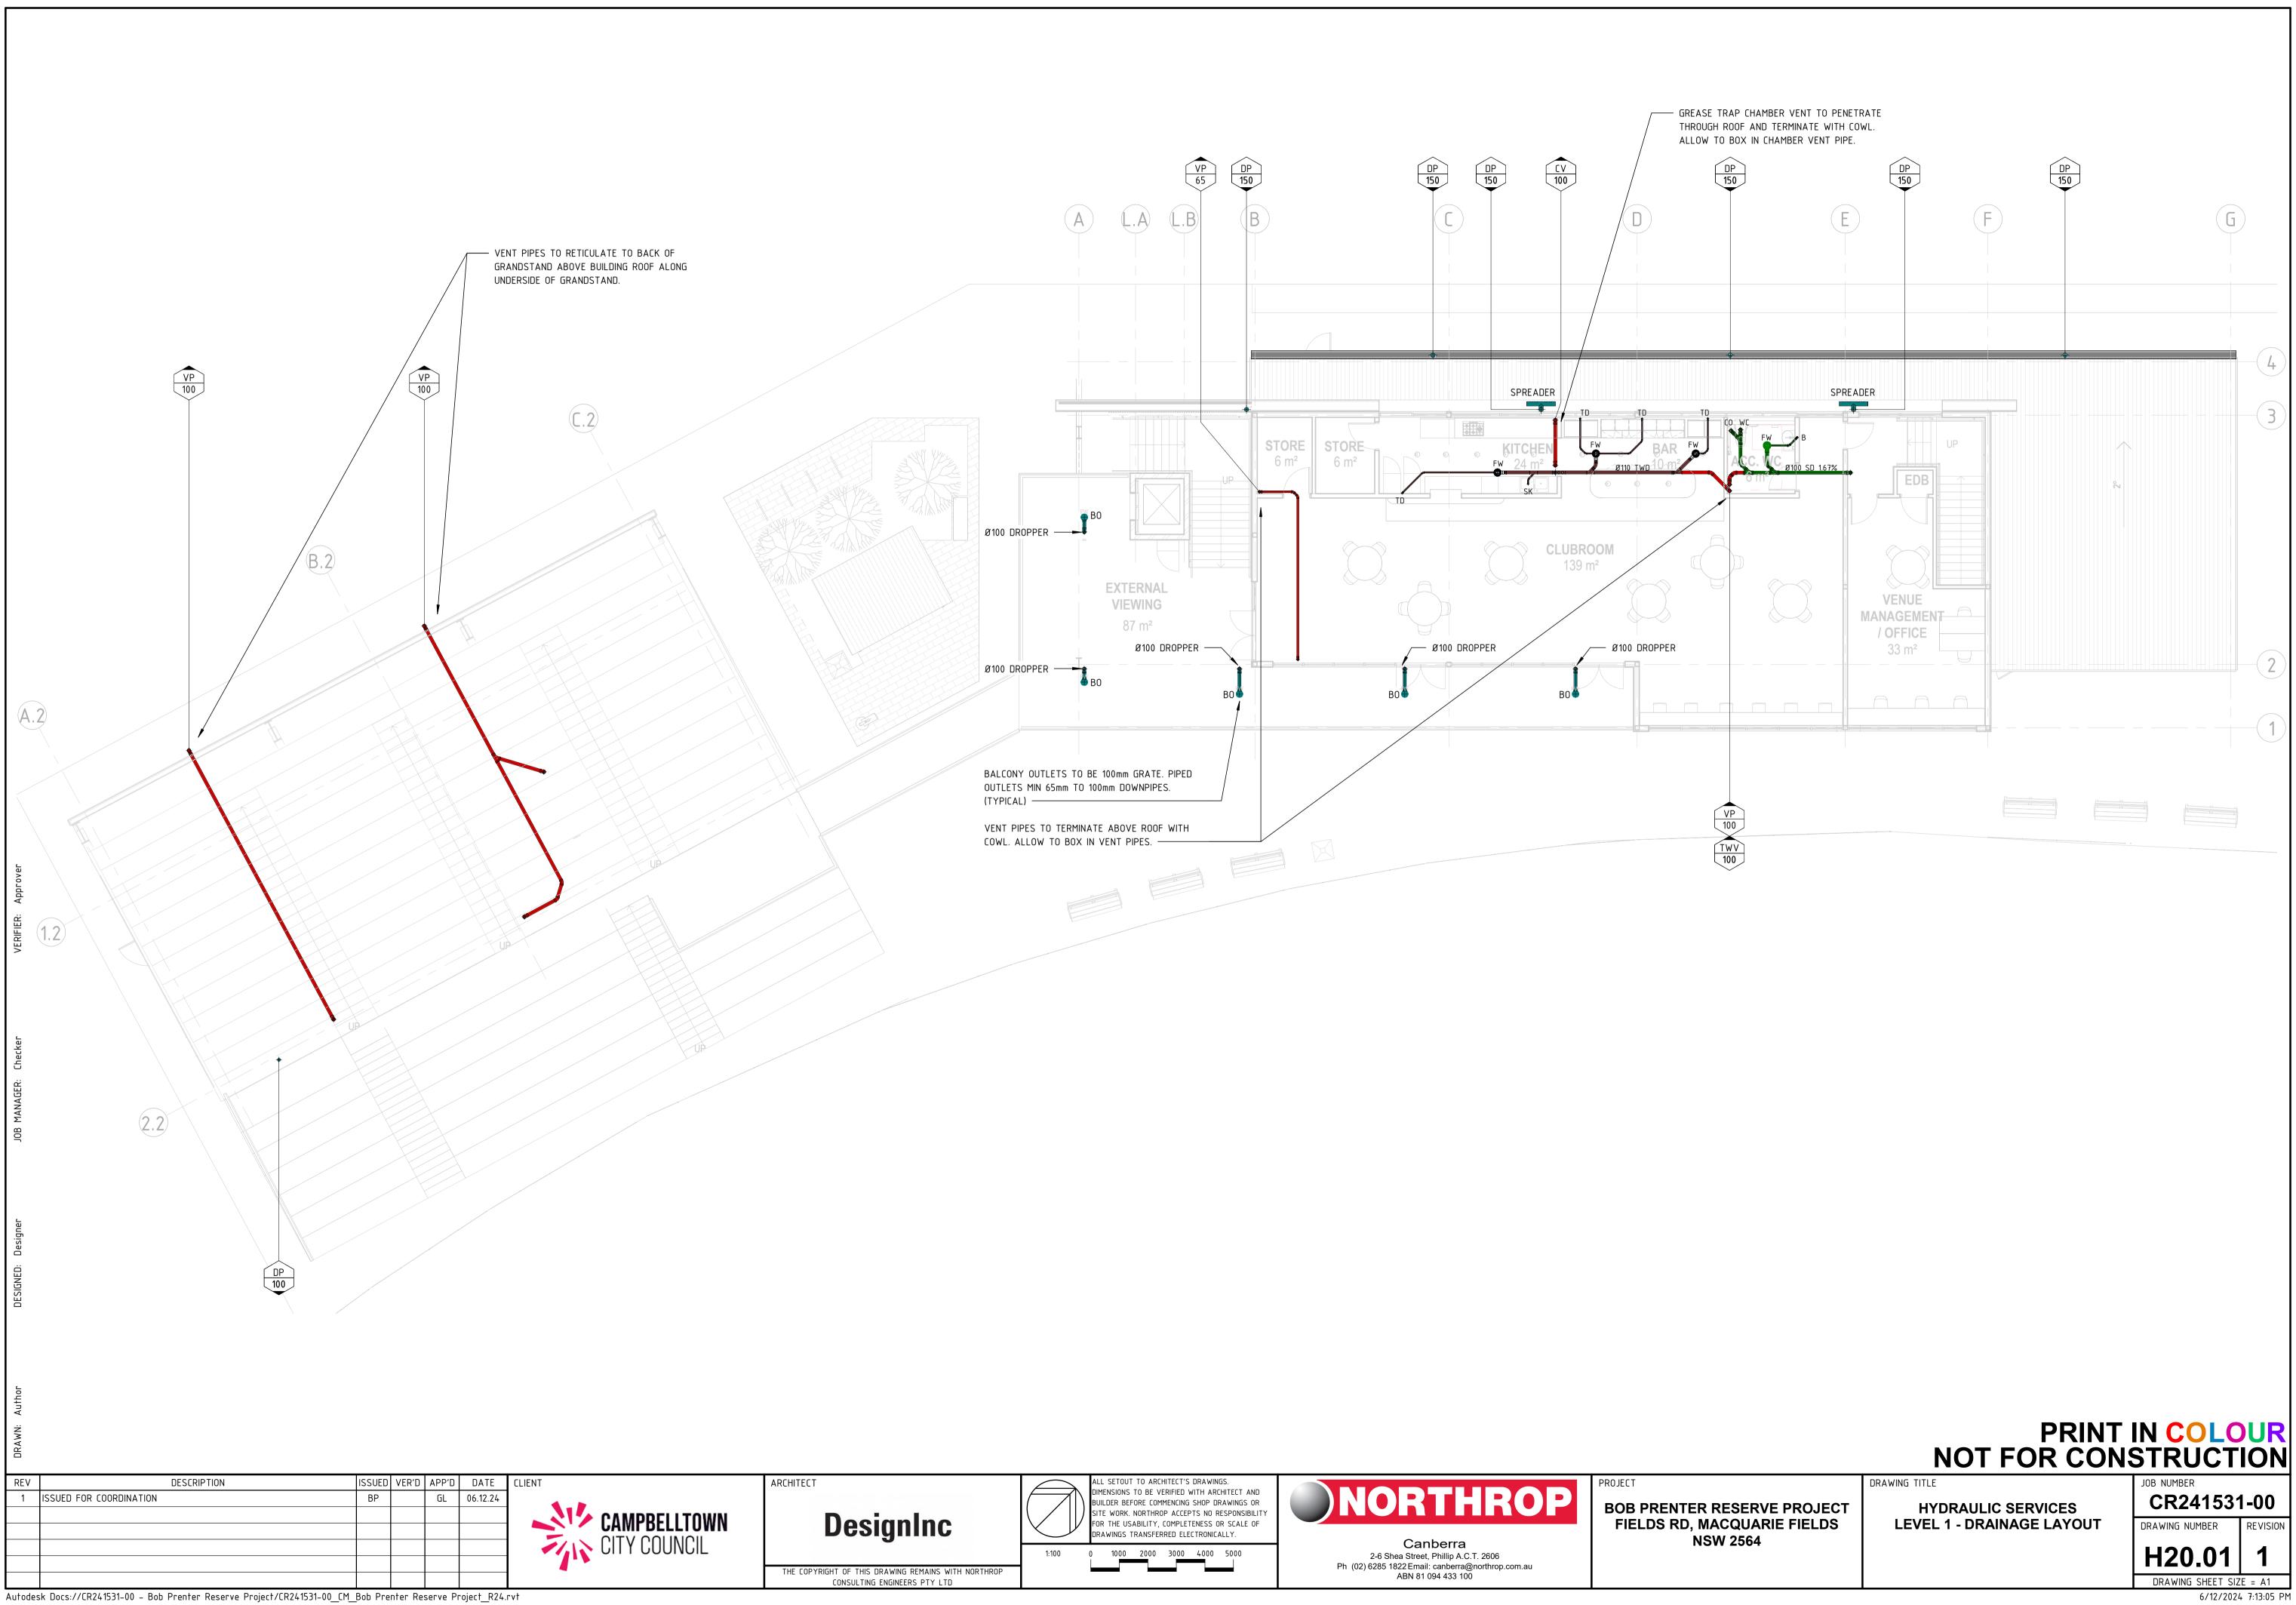
HYDRAULIC SERVICES LEGEND OF SYMBOLS AND NOTES






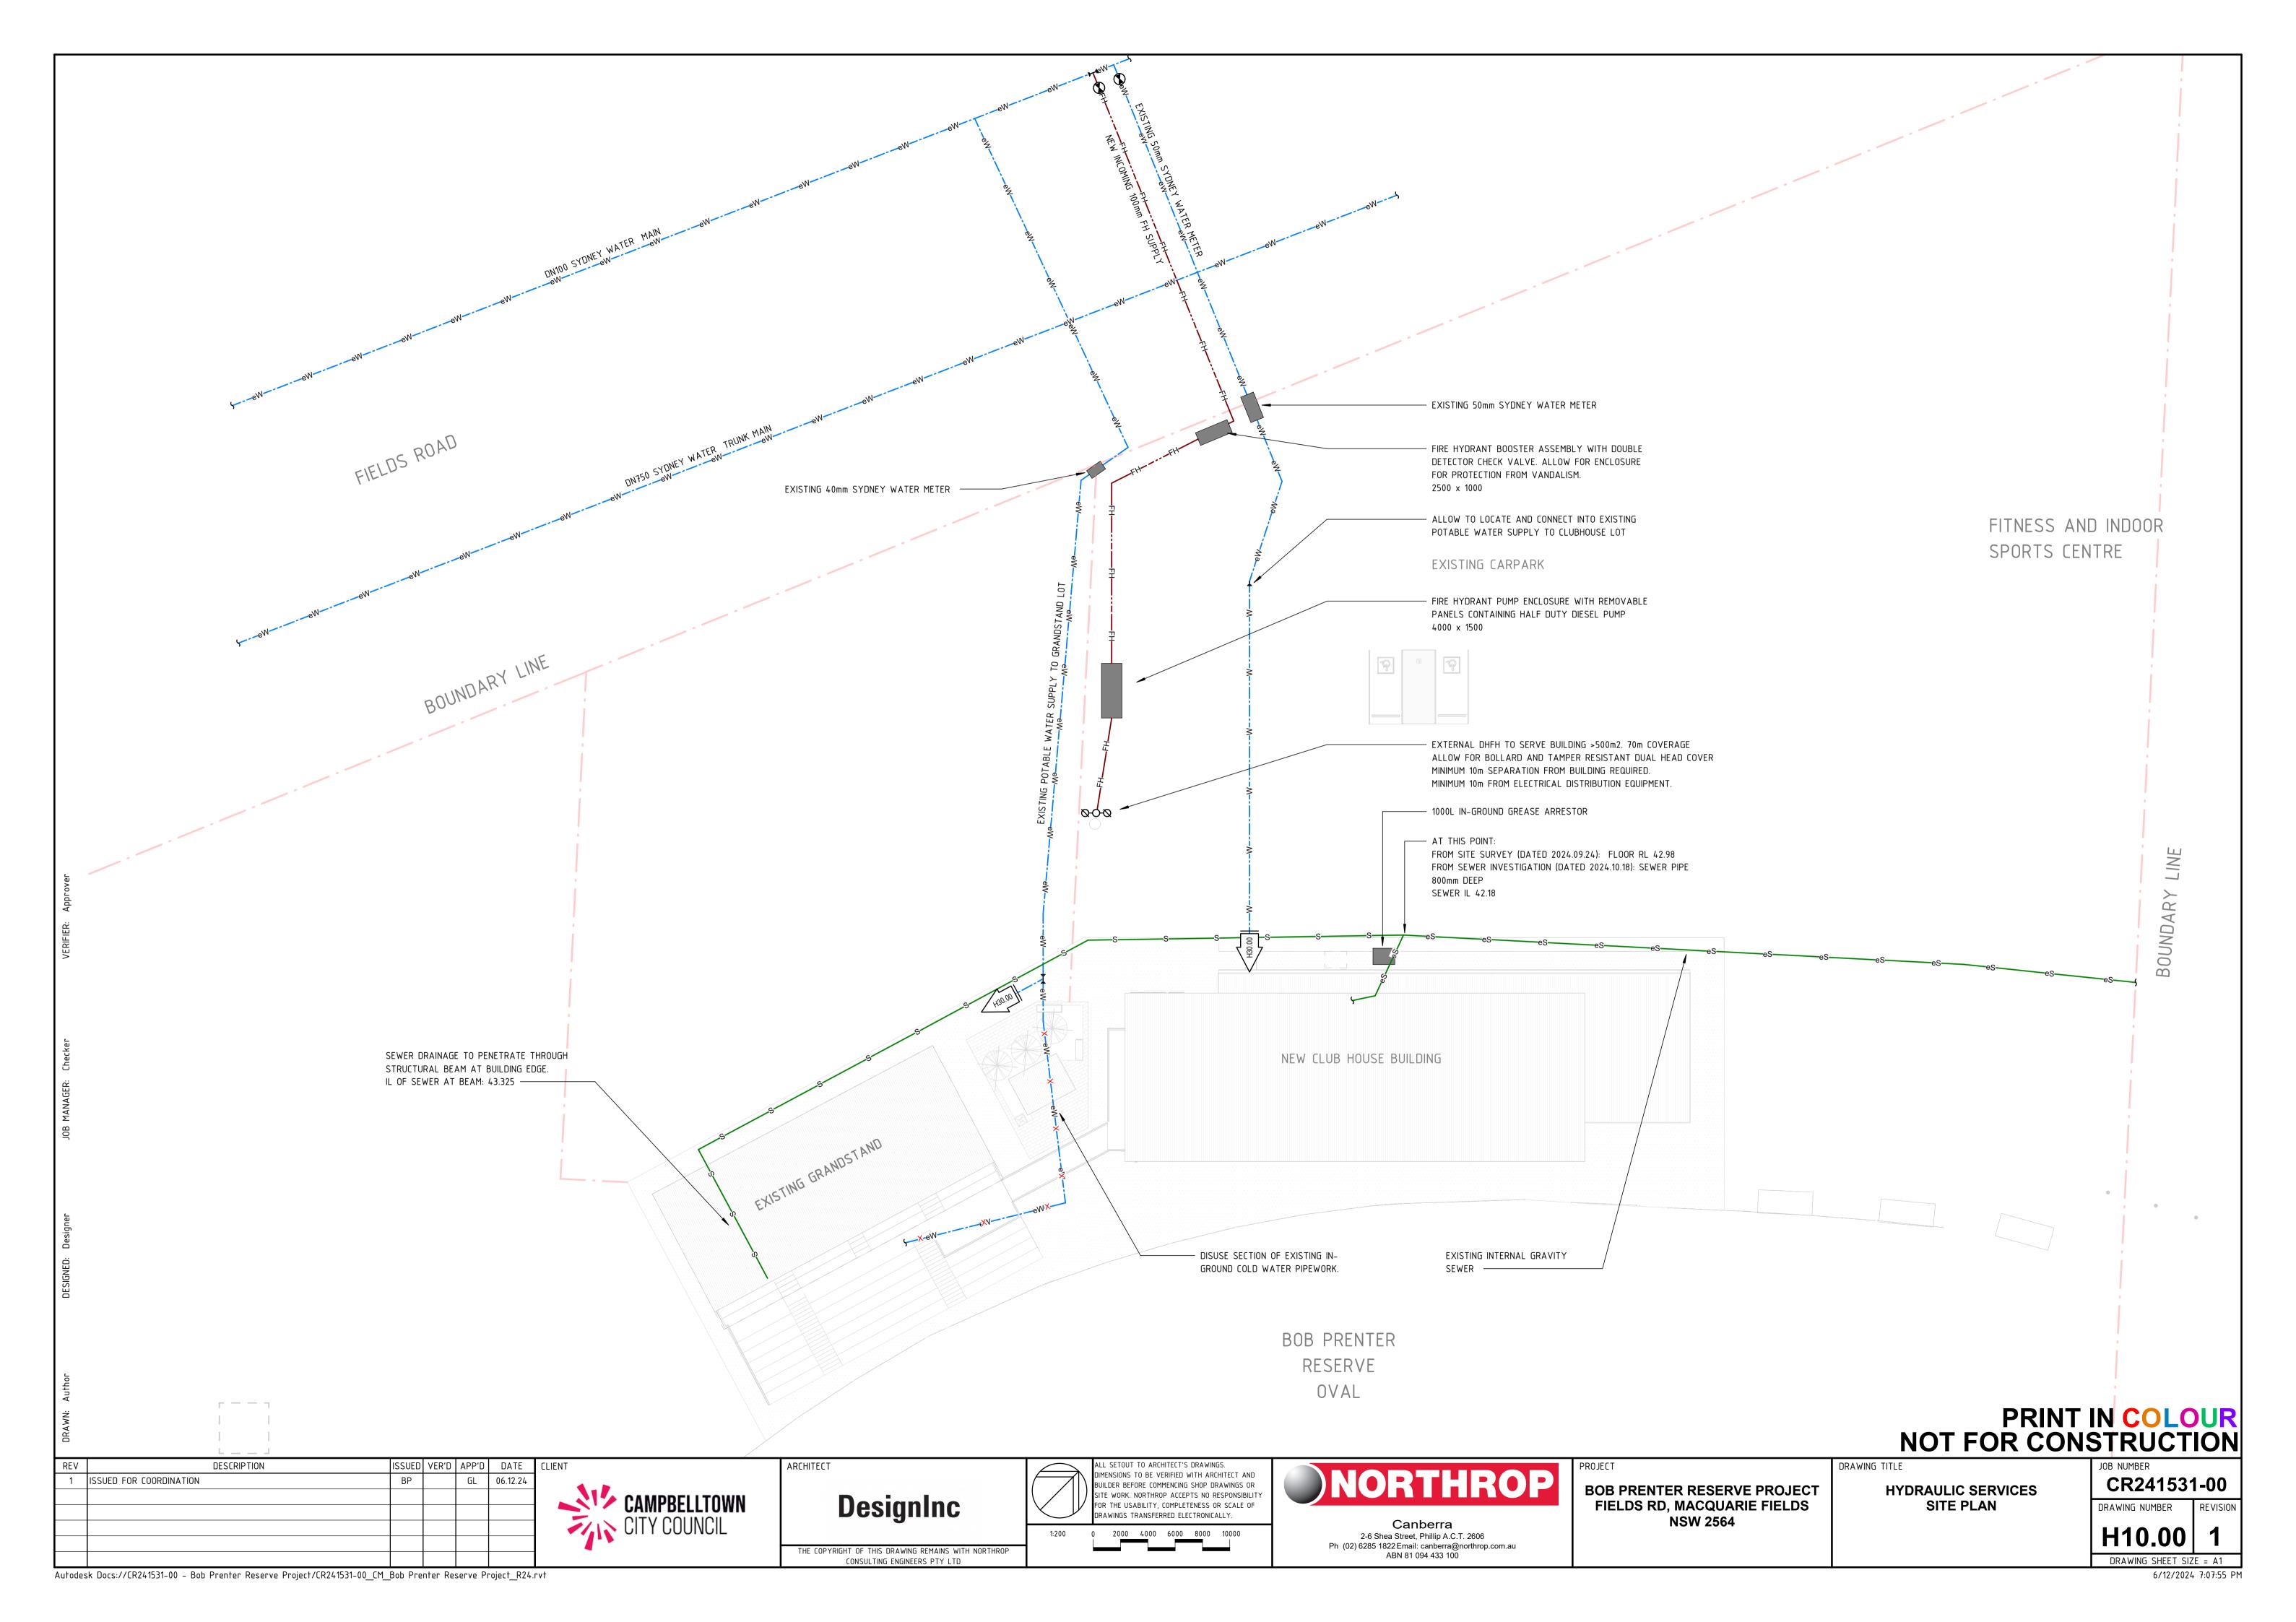


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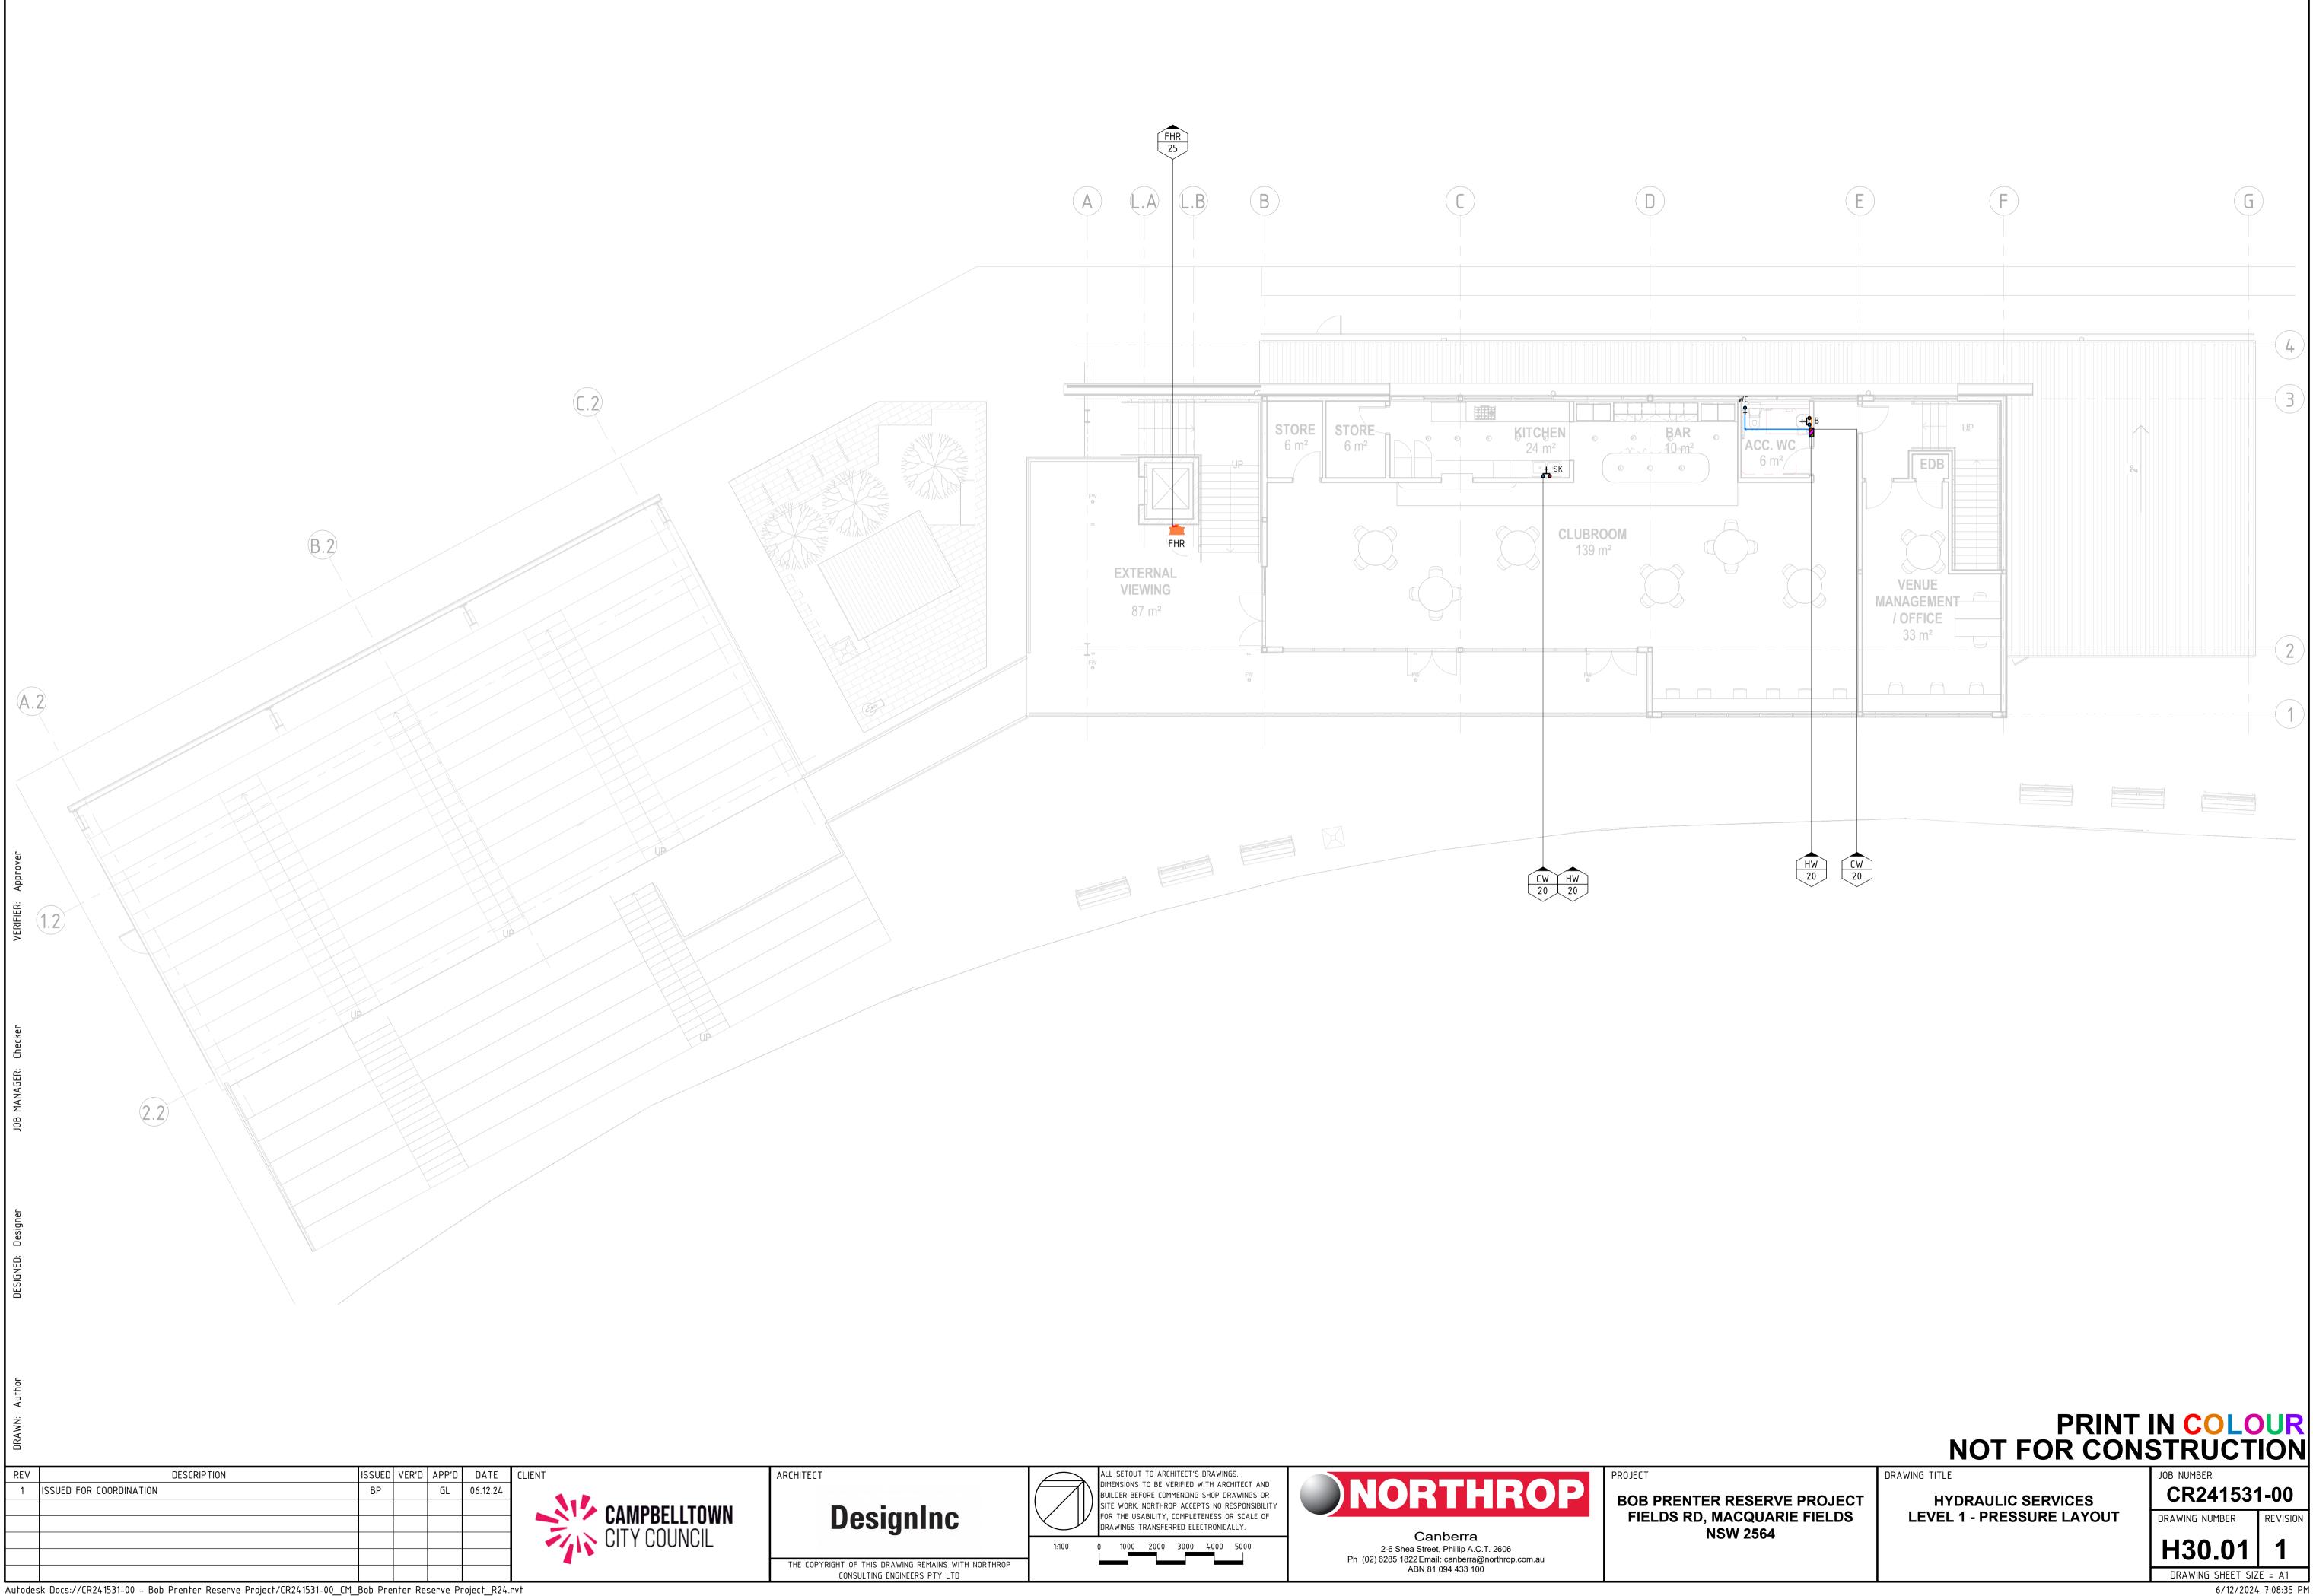
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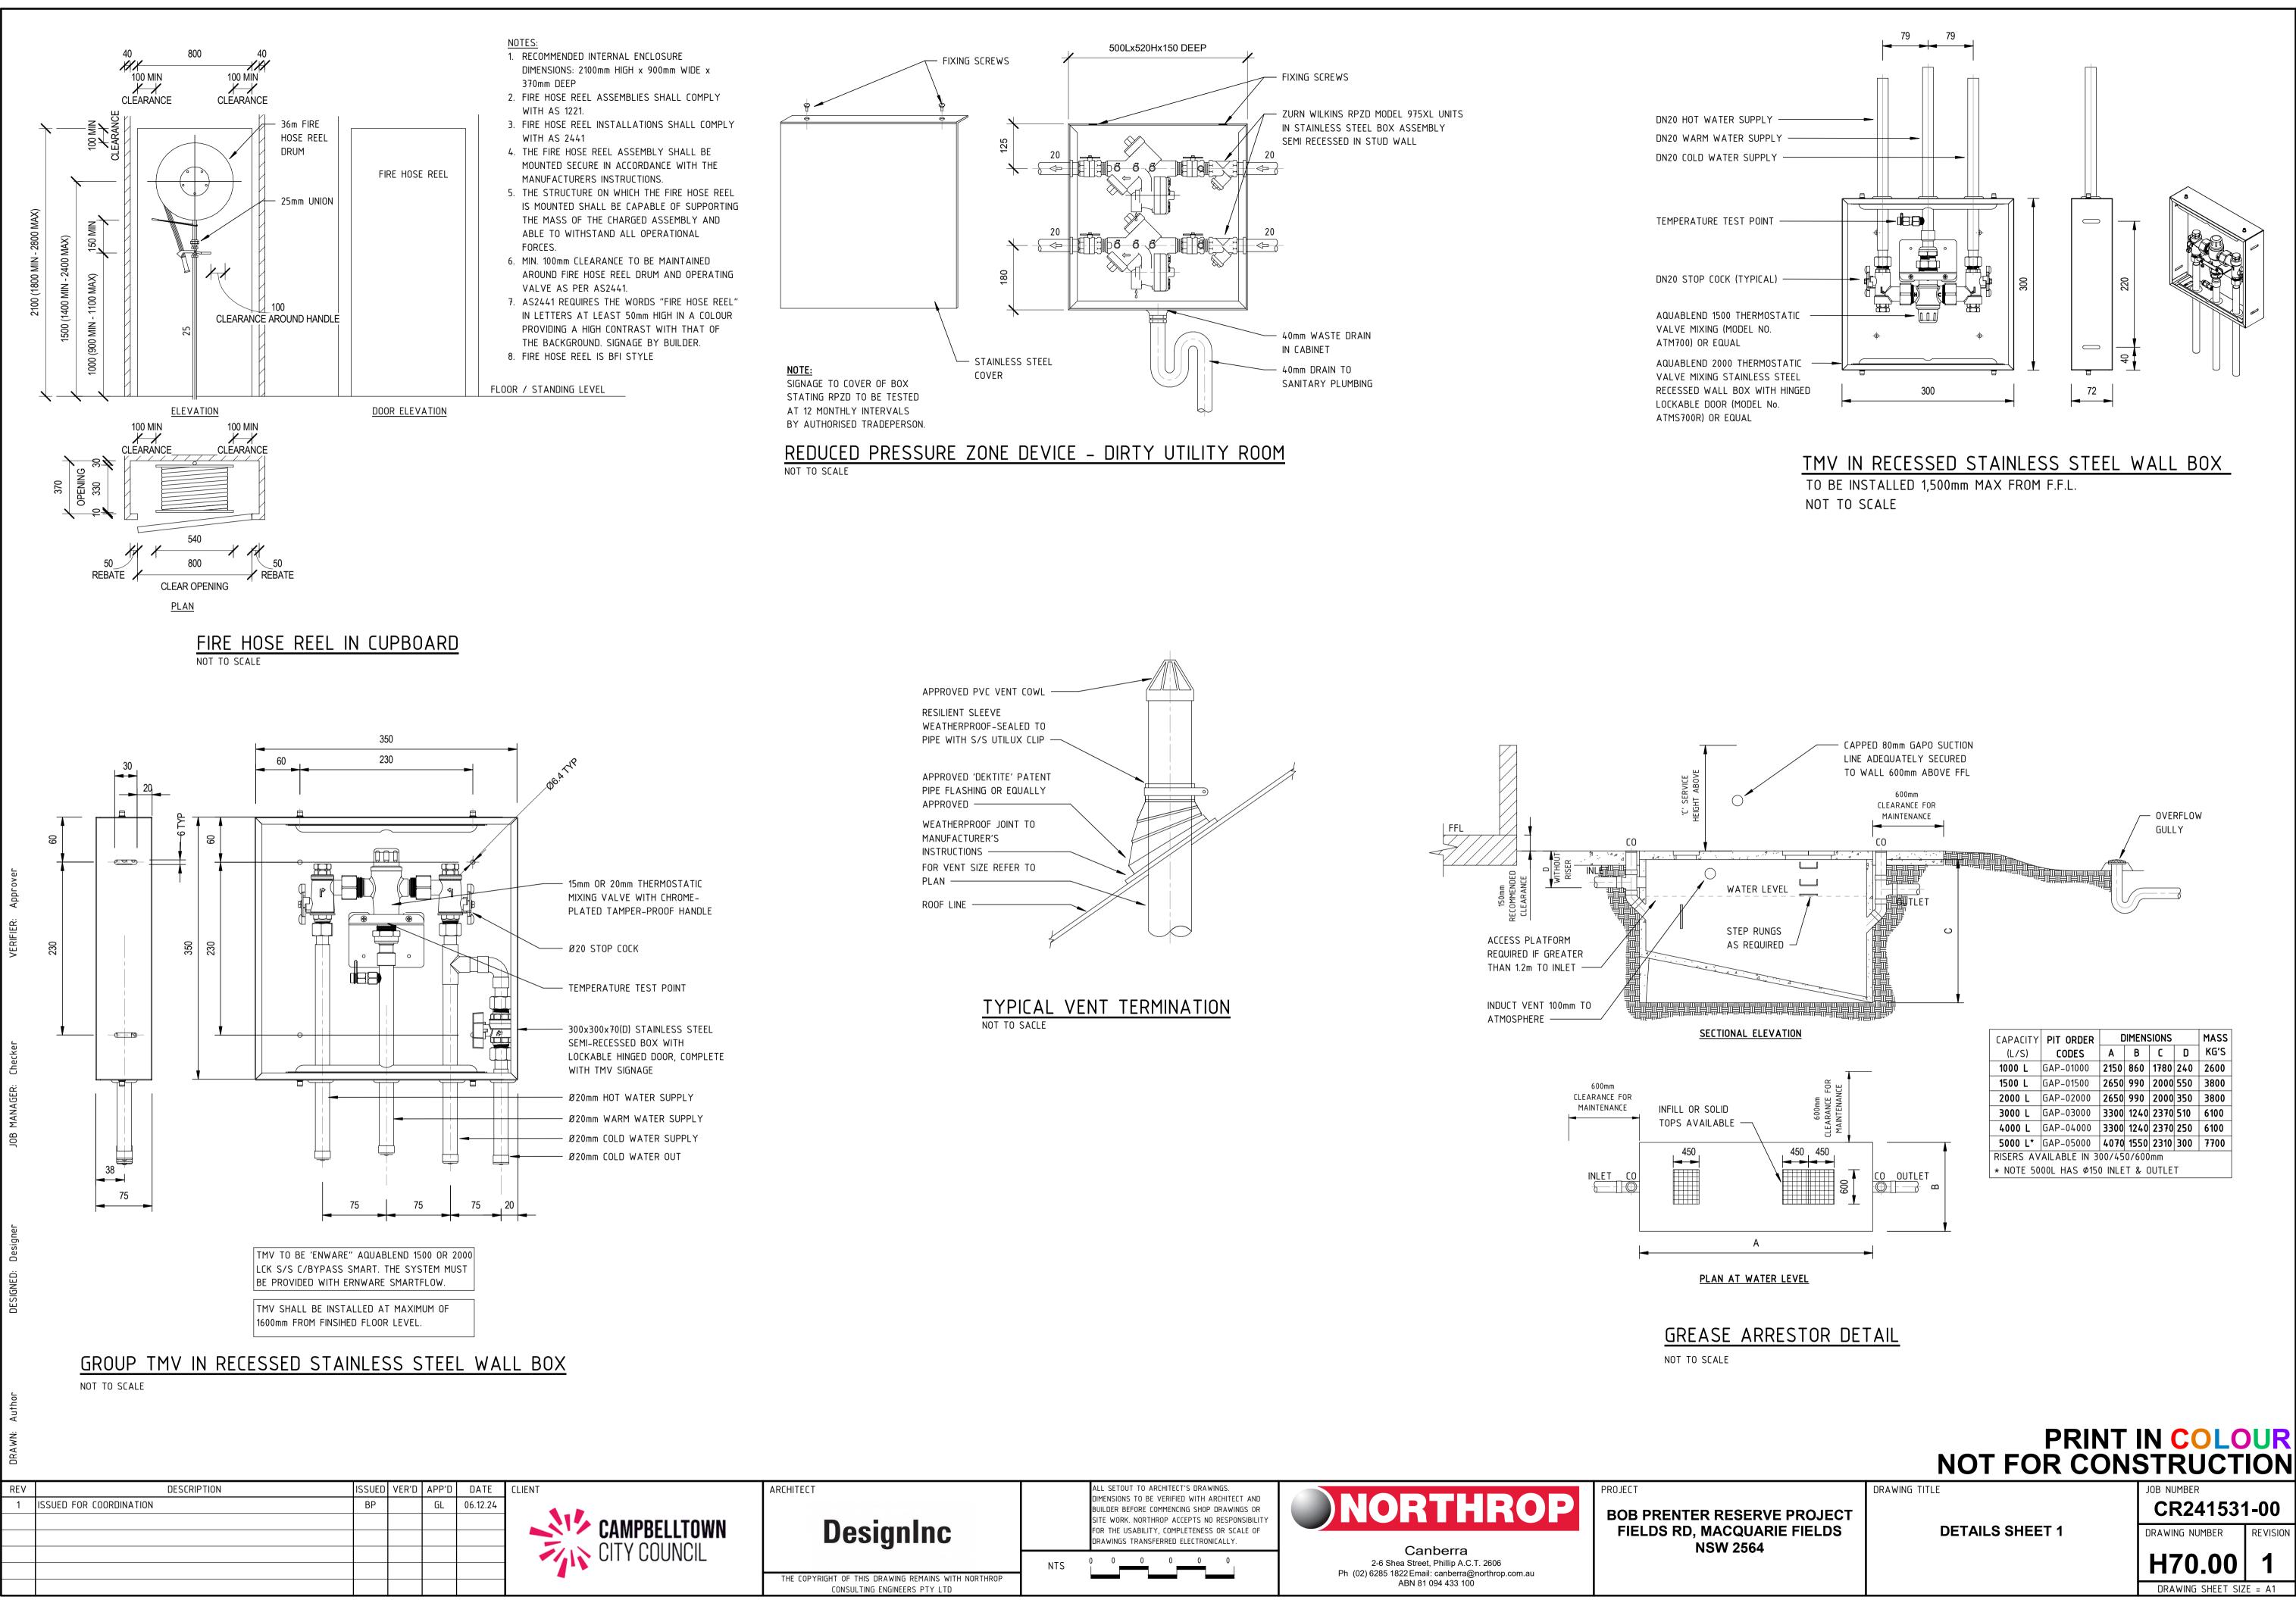
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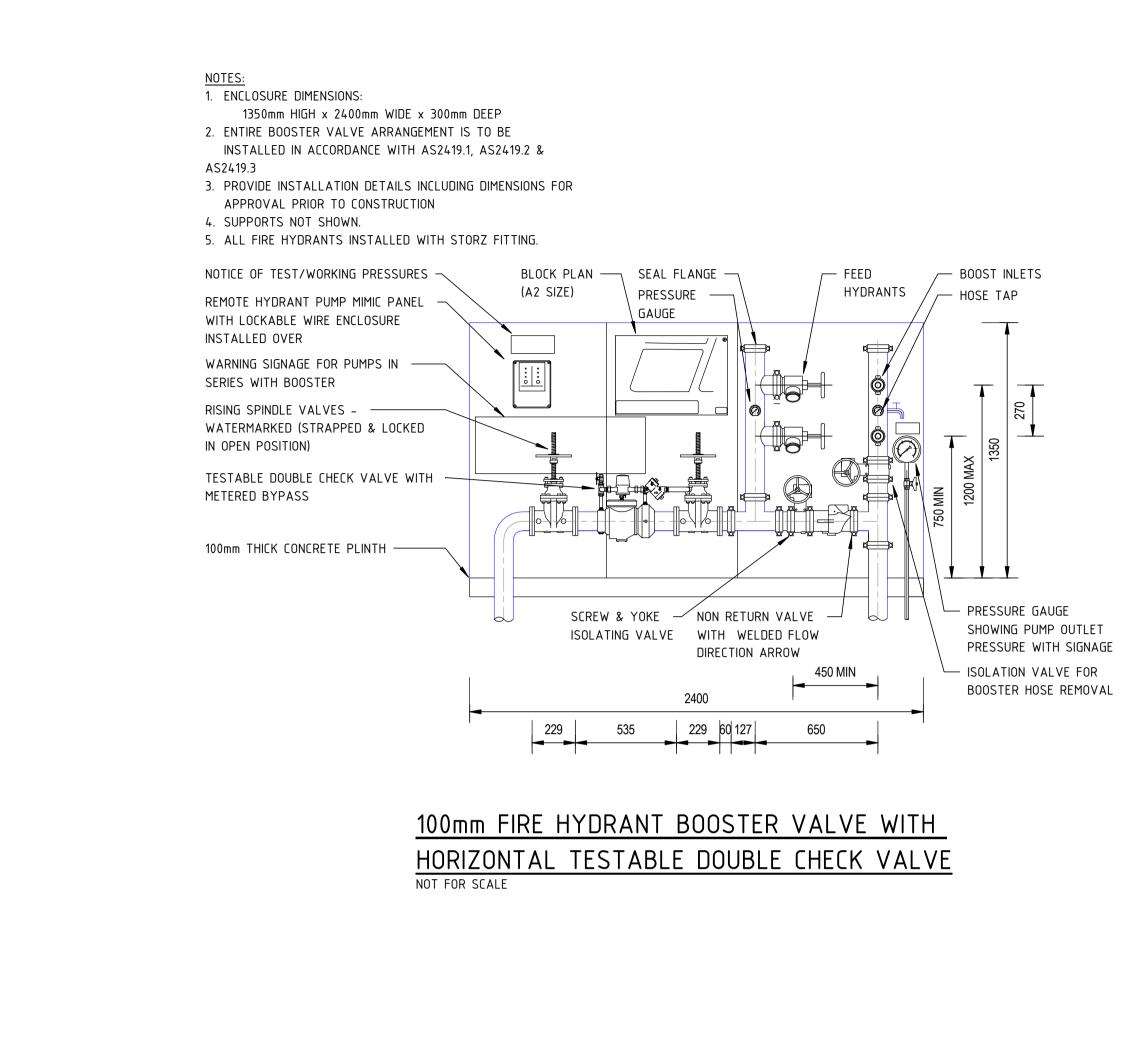
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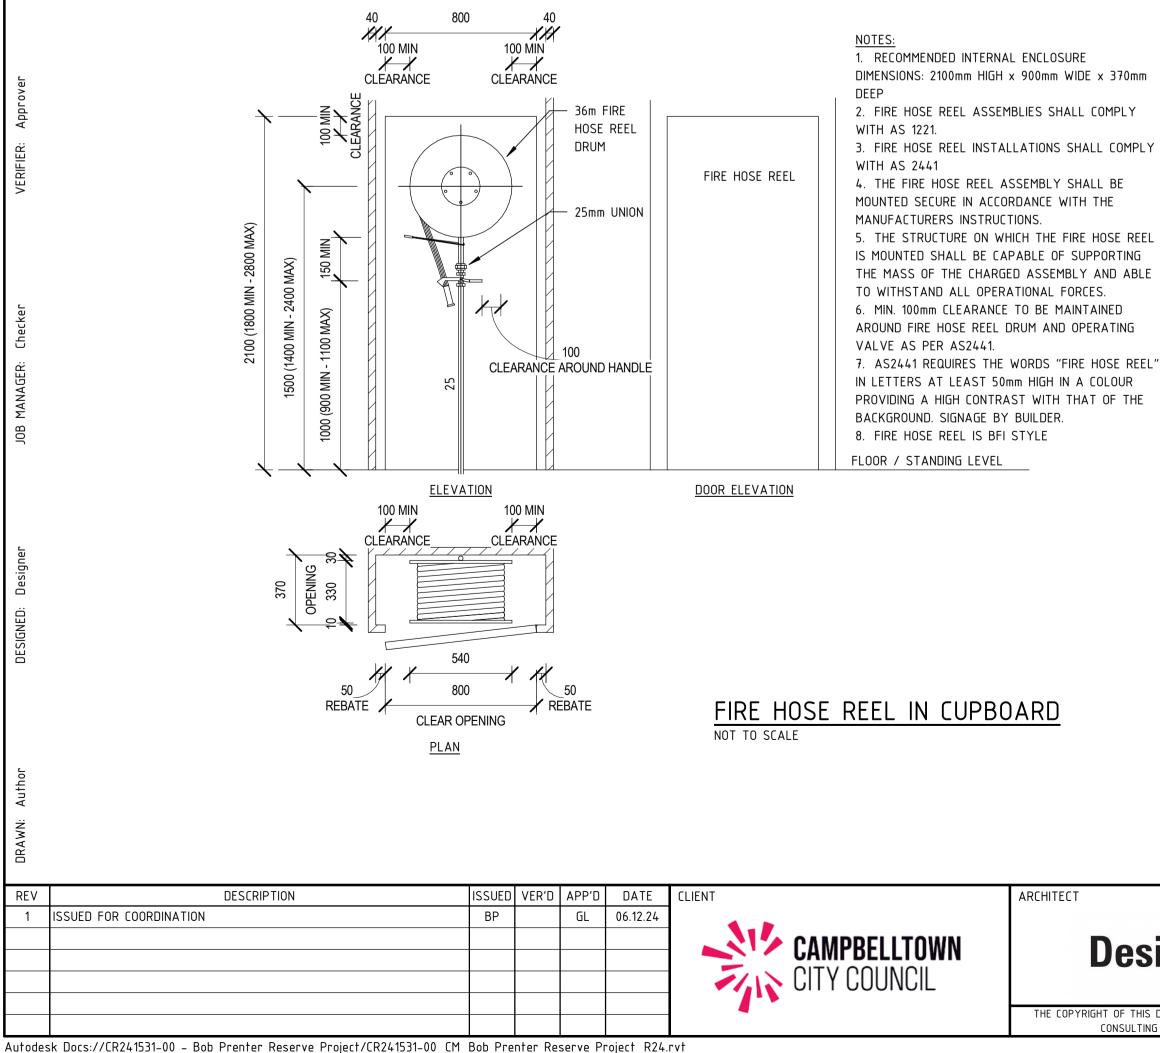



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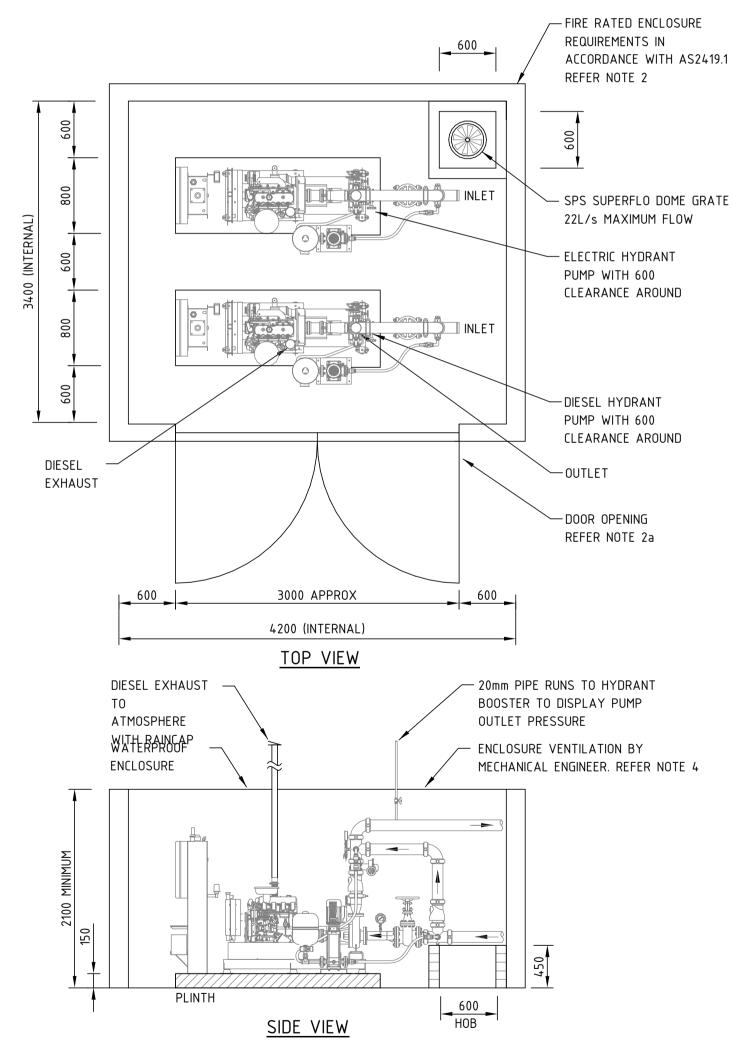
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	NTS 0 0 0 0 0 0	Canberra 2-6 Shea Street, Phillip A.C.T. 2606 Ph (02) 6285 1822 Email: canberra@northrop.com.au ABN 81 094 433 100	



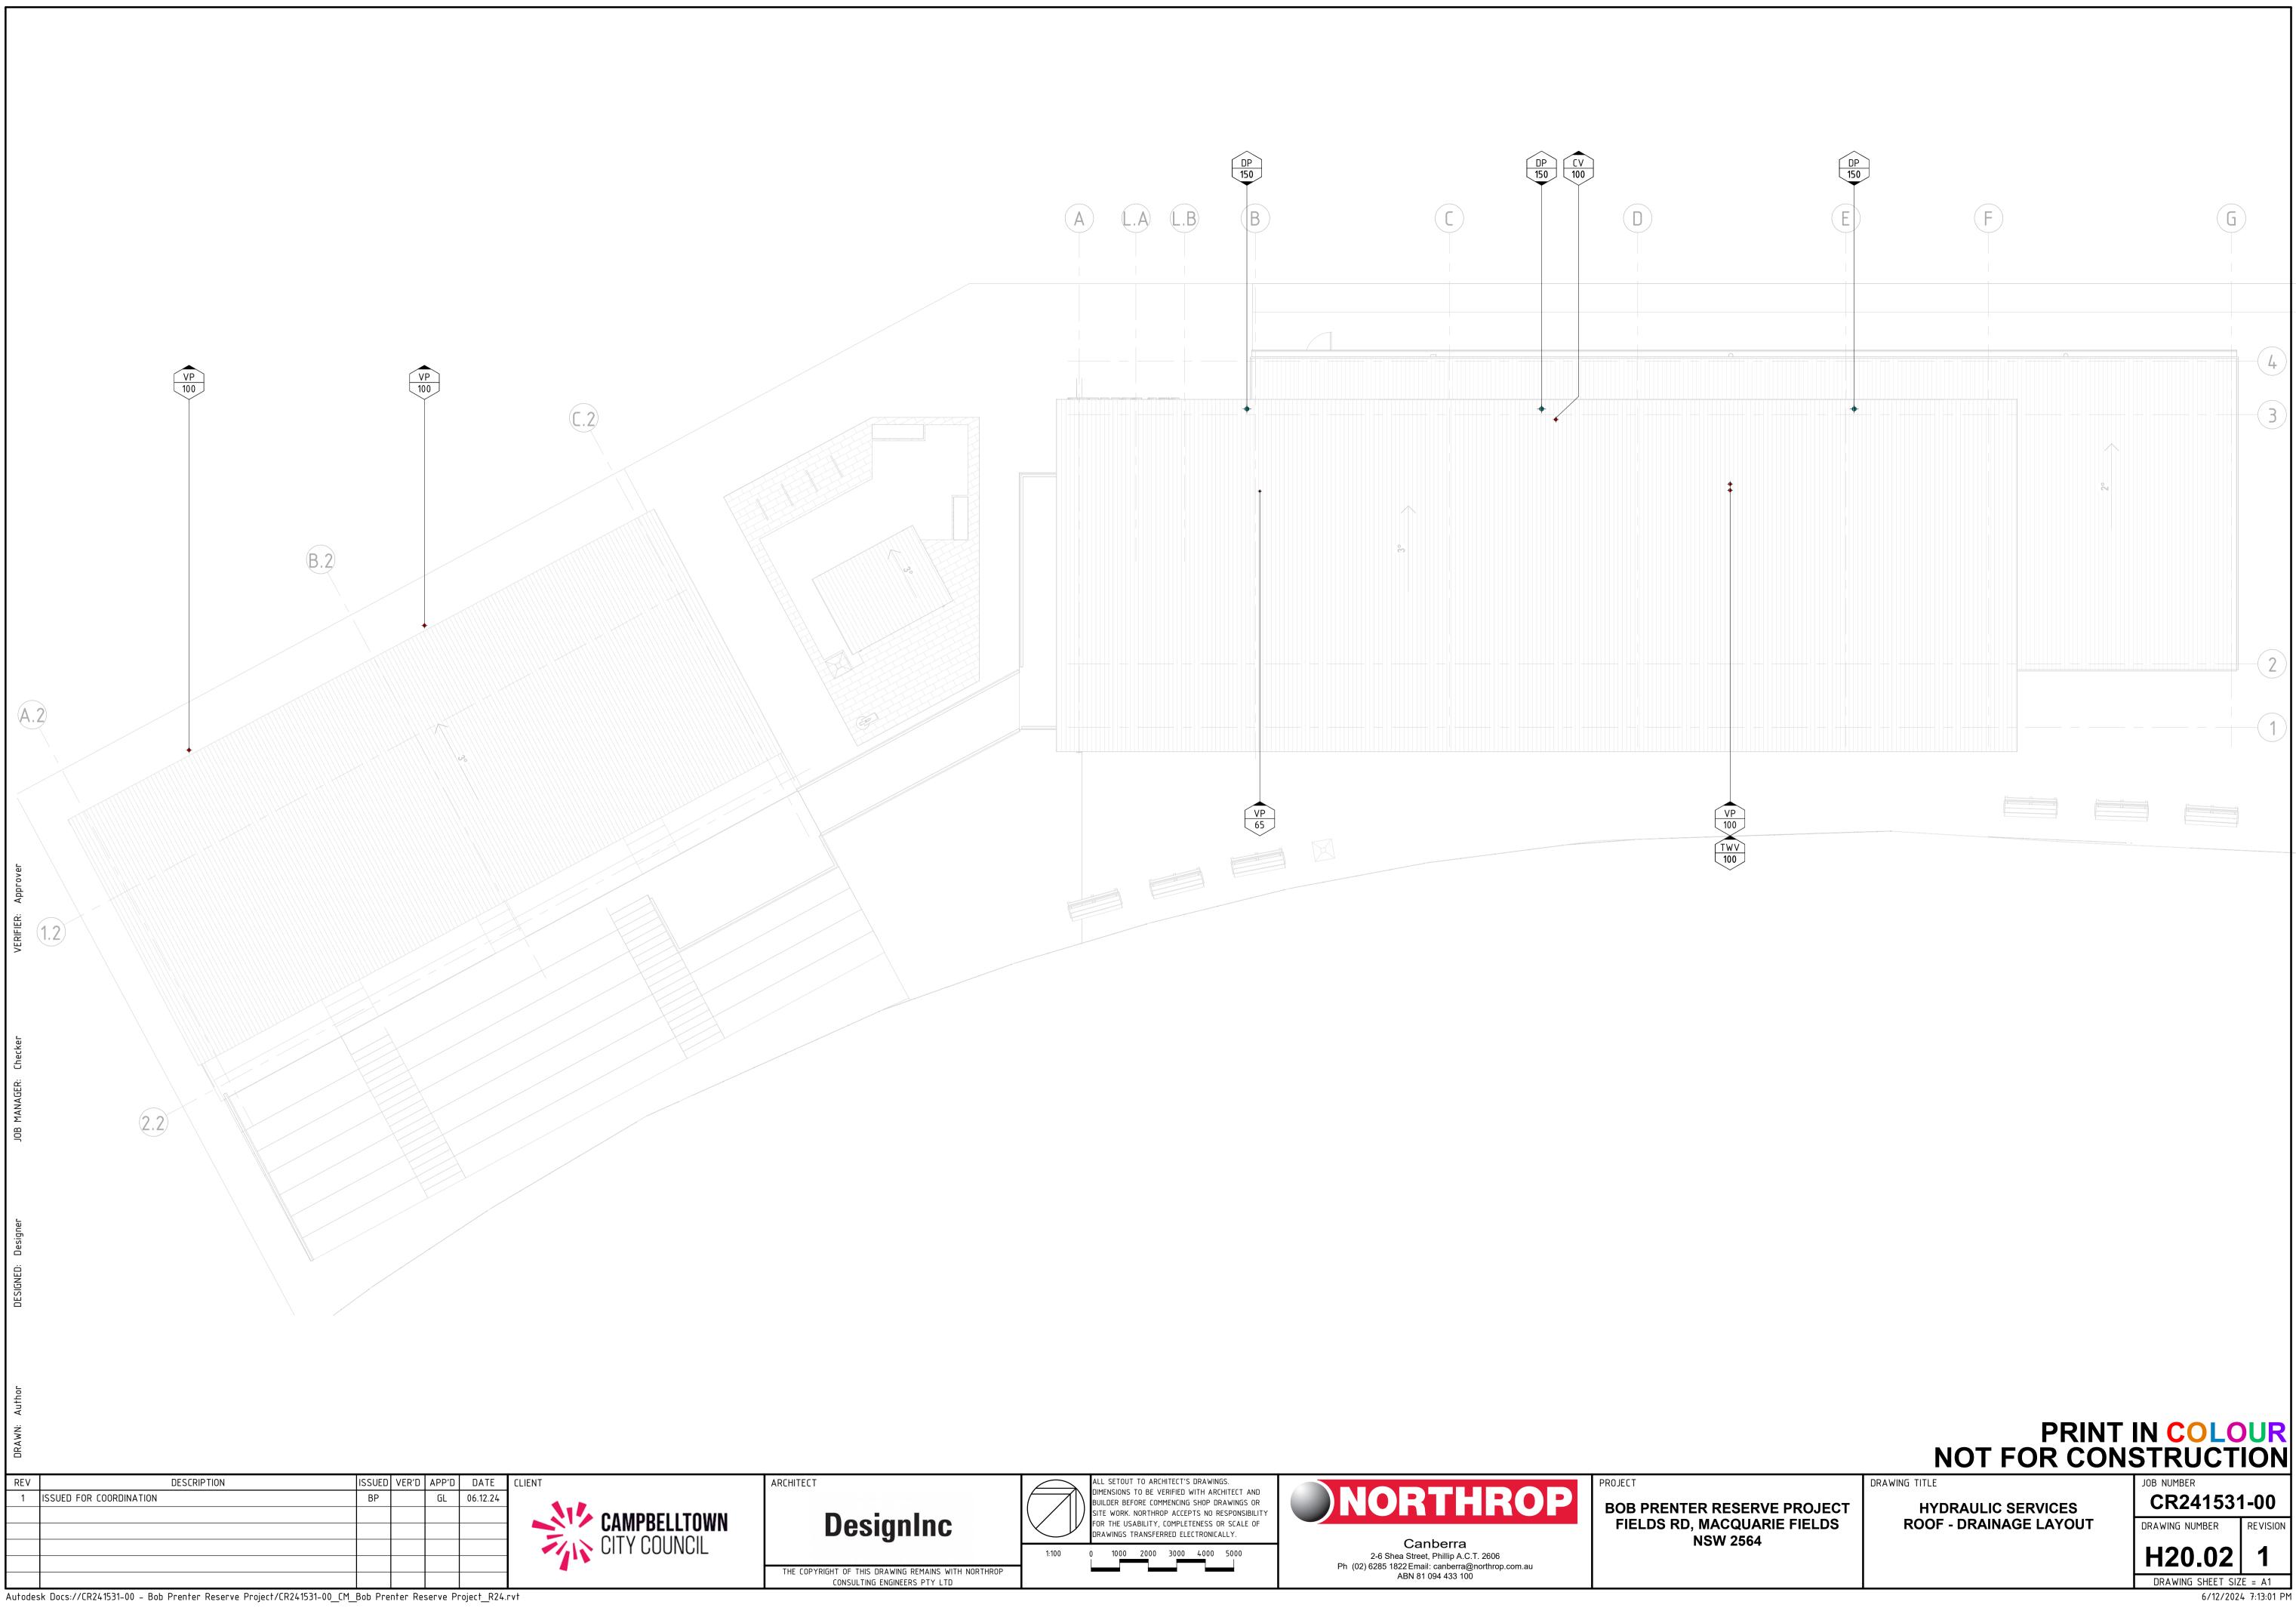

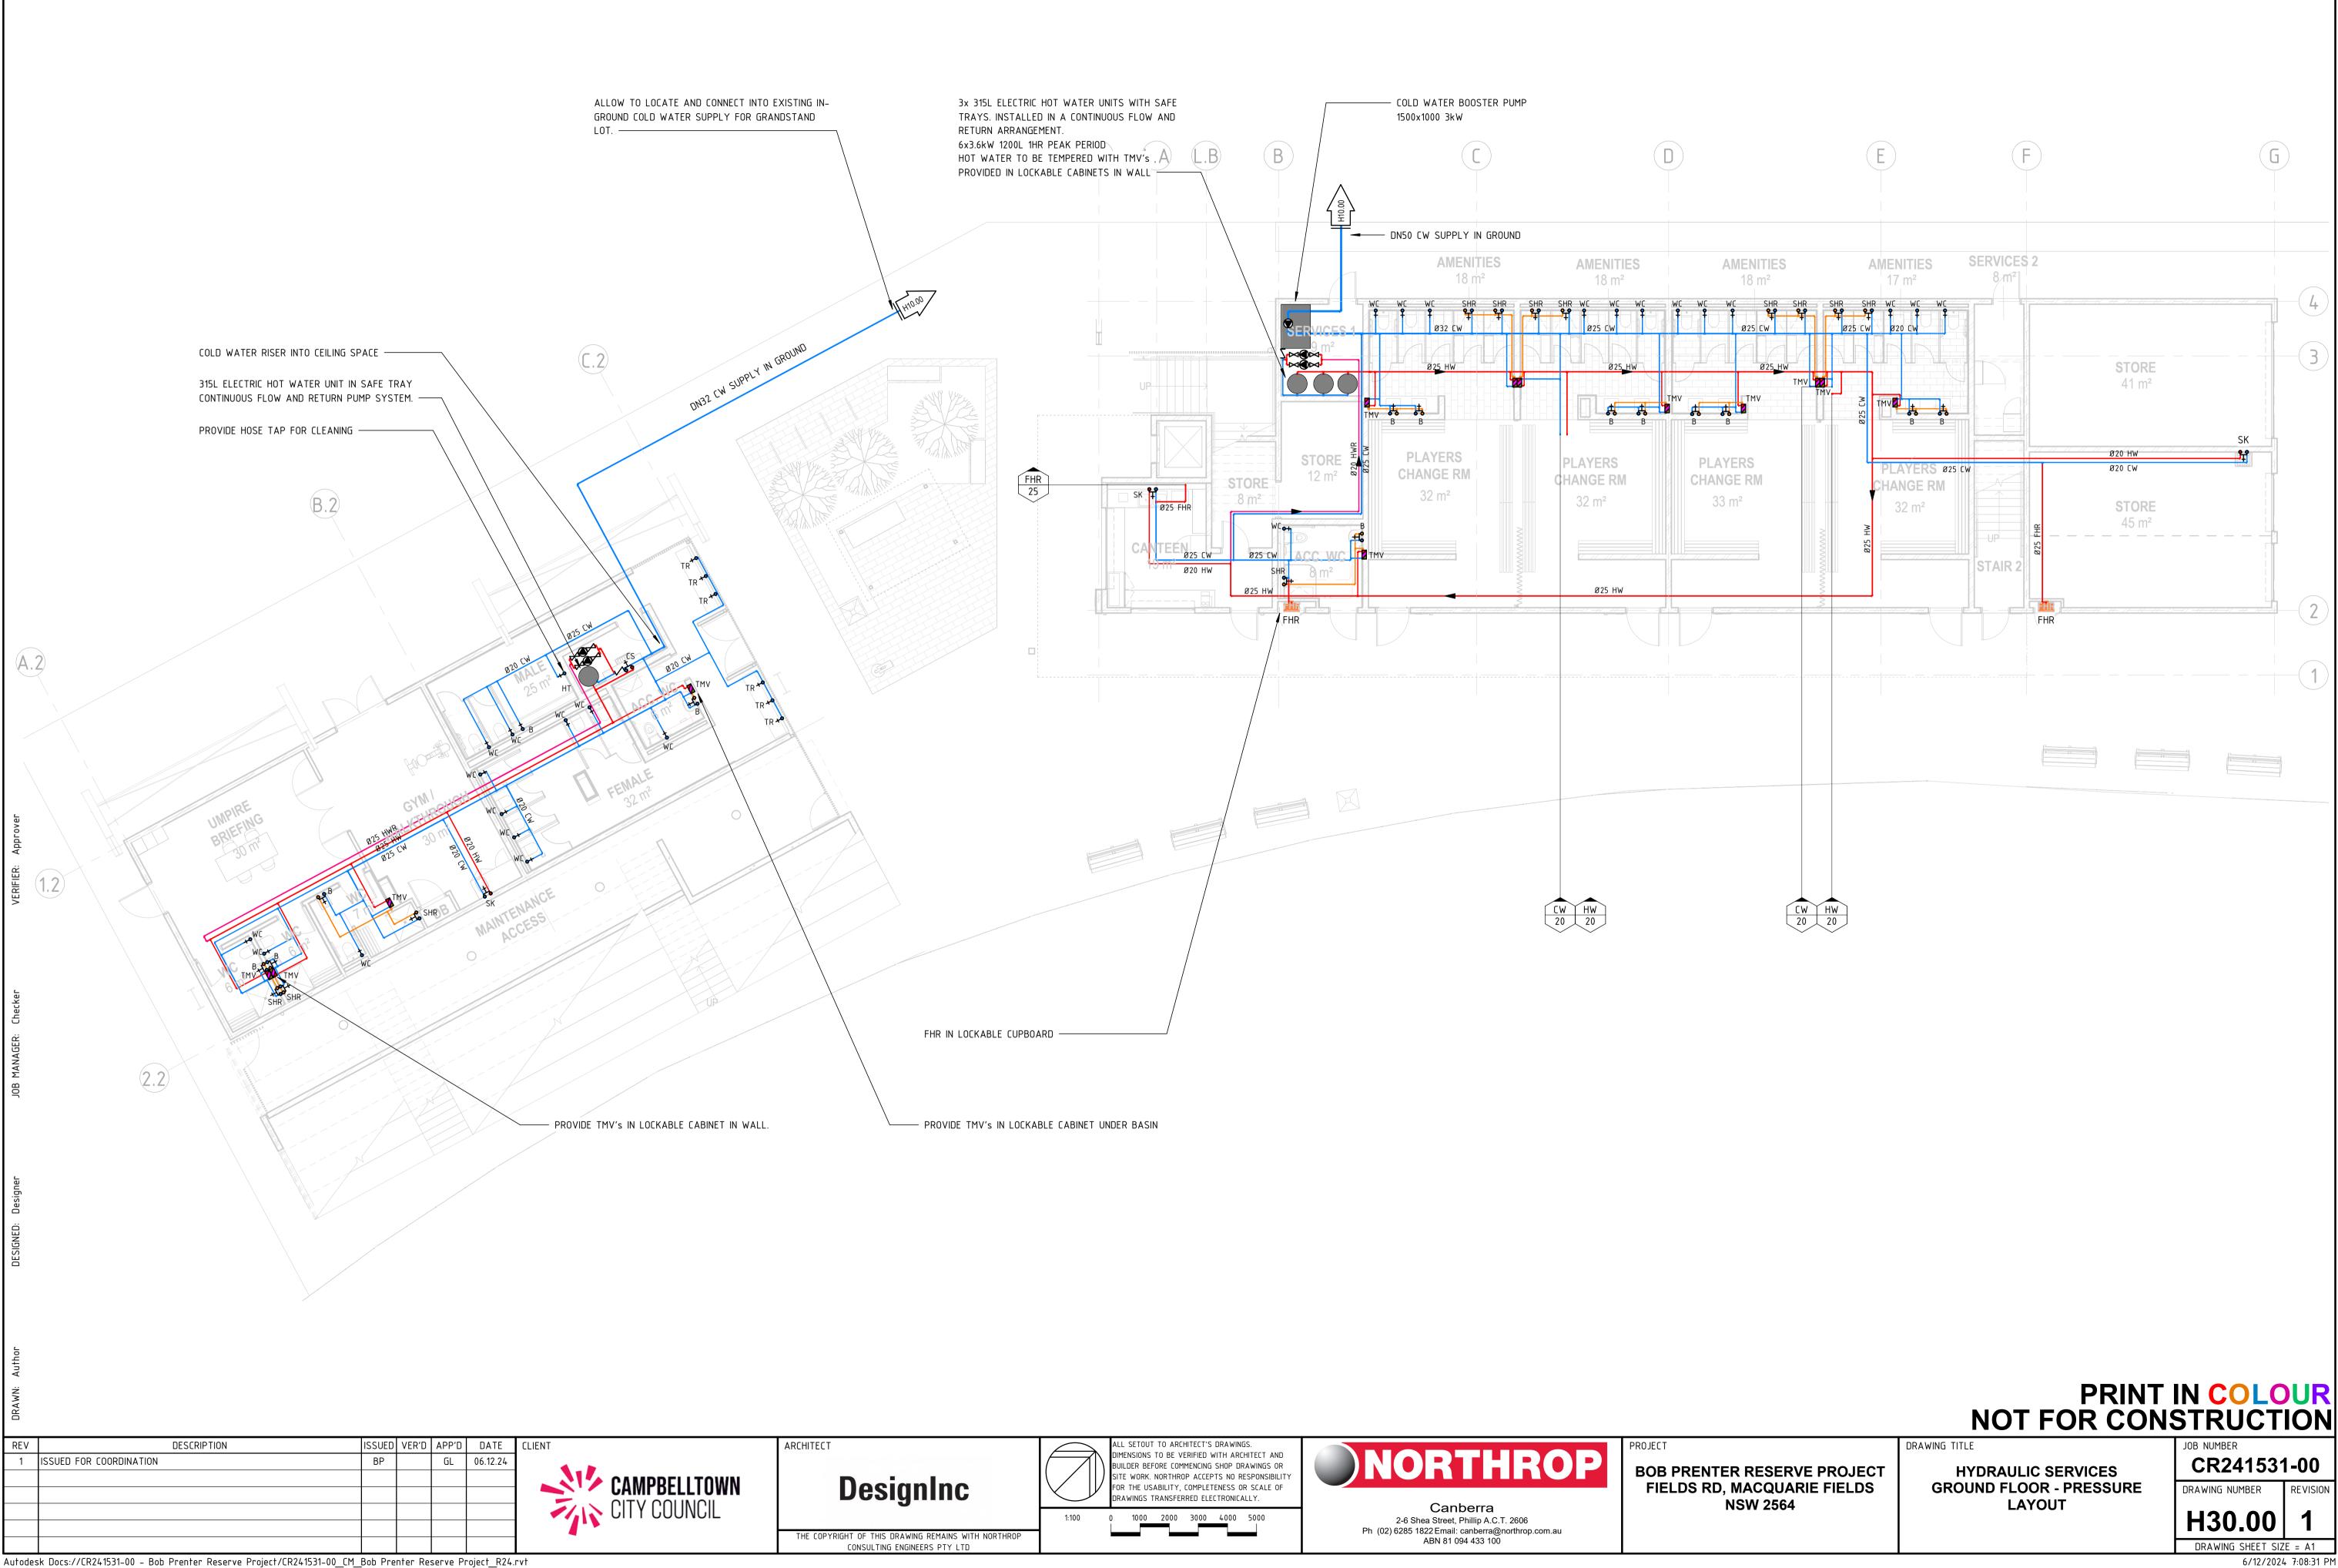

#### EXTERNAL DOUBLE HEADED FIRE HYDRANT NOT TO SCALE

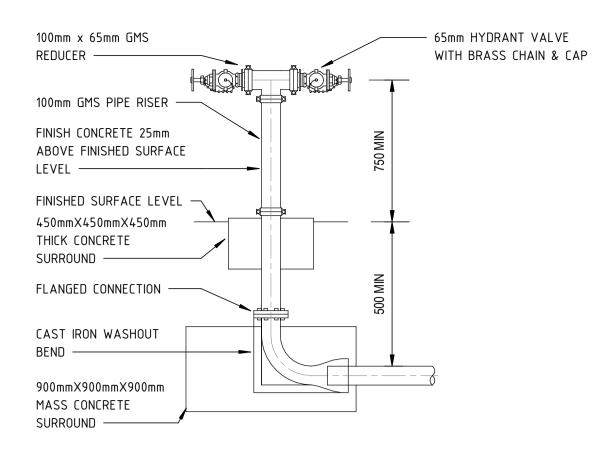

#### PUMP ROOM

- 1. GENERAL FIXED ON-SITE PUMPSETS & ASSOCIATED EQUIPMENT SHALL BE CONTAINED IN A WEATHERPROOF ROOM & BE--
- a. SECURE TO PREVENT THE ENTRY OF UNAUTHORIZED PERSONS;
- b. ADEQUATELY VENTILATED FOR THE ASPIRATION & COOLING OF PUMP DRIVERS;
- c. HEATED, WHERE NECESSARY, TO PREVENT FREEZING & FACILITATE THE COLD START OF COMPRESSION IGNITION DRIVERS;
- FIRE BRIGADE; &
- ADEQUATE SPACE FOR PUMP MAINTENANCE & REPLACEMENT. 2. INTERNAL PUMPROOMS
- PUMPROOMS LOCATED WITHIN A BUILDING SHALL HAVE--
- SERVED BY THE FIRE HYDRANT SYSTEM.
- 3. DIESEL EXHAUST SYSTEM THE EXHAUST SYSTEM SHALL BE GAS TIGHT THROUGHOUT THE OPERATING RANGE OF EXHAUST TEMPERATURES & PRESSURES. VERTICAL EXHAUST STACKS SHALL BE PROVIDED WITH A MEANS FOR RAIN EXCLUSION. THE EXHAUST SYSTEM SHALL BE FROM THE DRIVER TO THE EXHAUST SYSTEM. PREVENT FIRE HAZARDS & INJURY TO OPERATORS. THE EXHAUST SYSTEM SHALL BE FITTED WITH A SUITABLE SILENCER, & THE TOTAL BACK PRESSURE SHALL NOT EXCEED THE ENGINE MAKERS RECOMMENDATION.
- 4. VENTILATION OF ENCLOSURE THE PUMP ENCLOSURE SHALL BE VENTILATED IN ACCORDANCE WITH PUMP MANUFACTURERS REQUIREMENTS. eg. COOLED) 340L/s

#### DUAL INTERNAL PUMP ENCLOSURE - DIESEL HYDRANT NOT TO SCALE

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# PRINT IN COLOUR NOT FOR CONSTRUCTION DRAWING TITLE

VE	PROJECT
	FIELDS

**DETAILS SHEET 2** 

15kw (WATER

JOB NUMBER	
CR24153 <sup>2</sup>	1-00
DRAWING NUMBER	REVISION
H70.01	1
DRAWING SHEET SIZ	'E = A1
6/12/2024	7:07:45 PM

THE MECHANICAL ENGINEER IS TO PROVIDE VENTILATION REQUIREMENTS.

DESIGNED TO DISCHARGE EXHAUST GASES OUTSIDE THE PUMP ROOM, SHALL BE FITTED WITH A FLEXIBLE CONNECTION TO PREVENT TRANSMISSION OF VIBRATION THE SYSTEM SHALL BE SUITABLE GUARDED, LAGGED, SHIELDED OR COOLED TO

15kw (AIR COOLED) 800L/s

a. A DOOR OPENING TO A ROAD OR OPEN SPACE, OR A DOOR OPENING TO FIRE-ISOLATED PASSAGE OR STAIR WHICH LEADS TO A ROAD OR OPEN SPACE; & b. EXCEPT WHERE THE BUILDING IS SPRINKLER PROTECTED IN ACCORDANCE WITH AS 2118.1, ENCLOSING WALLS WITH AN FRL NOT LESS THAN THAT PRESCRIBED BY THE BCA FOR A FIREWALL FOR THE PARTICULAR BUILDING CLASSIFICATION

e. CONSTRUCTED WITH A MINIMUM 2.1 M HIGH INTERNAL CLEARANCE WITH

d. IDENTIFIED BY APPROPRIATE SIGNS & OTHER VISUAL AND AUDIBLE AIDS, SO THAT THE ROOM AND ITS ENTRANCE CAN BE READILY LOCATED BY THE ATTENDING

# CAMPBELLTOWN CITY COUNCIL BOB PRENTER RESERVE AMENITY BUILDING ISSUED FOR COORDINATION

# DesignInc





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DRAWING LIST - LANDSCAPE			
DRAWING NUMBER	DRAWING NAME		
0000 - GENERAL & SITE IN	FORMATION		
BPR-DIS-LA-DRG-10001	COVER SHEET AND DRAWING LIST		
BPR-DIS-LA-DRG-10002	GENERAL NOTES - SHEET 1		
BPR-DIS-LA-DRG-10003	GENERAL NOTES - SHEET 2		
BPR-DIS-LA-DRG-10005	LANDSCAPE SITE PLAN		
1000 - GENERAL ARRANGE	EMENT PLANS		
BPR-DIS-LA-DRG-11200	GENERAL ARRANGEMENT PLAN - GROUND FLOOR		
BPR-DIS-LA-DRG-11300	LANDSCAPE SETOUT PLAN - GROUND PLAN		
BPR-DIS-LA-DRG-11400	LANDSCAPE PLANTING PLAN - GROUND PLAN		
BPR-DIS-LA-DRG-13100	LANDSCAPE SECTIONS & ELEVATIONS		
8000 - EXTERIOR DETAILS			
BPR-DIS-LA-DRG-18100	LANDSCAPE DETAILS - SOFTWORKS		
BPR-DIS-LA-DRG-18200	LANDSCAPE DETAILS - HARDWORKS		
BPR-DIS-LA-DRG-18300	LANDSCAPE DETAILS - FURNITURES AND FIXTURES		
9000 -SCHEDULES			
BPR-DIS-LA-DRG-19100	LANDSCAPE PLANTING SCHEDULE		

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#### PROJECT BOB PRENTER RESERVE AMENITY BUILDING

PROJECT ADDRESS Fields Rd, Macquarie Fields NSW 2564

#### WORK-IN-PROGRESS

A9.12.24ISSUED FOR COORDIINATIONNoDATEREVISIONS

DRAWN BY KF Checked by MD Approved by MW STATUS DETAILED DESIGN SCALES NTS

DRAWING NO. BPR-DIS-LA-DRG-10001



TITLE COVER SHEET AND DRAWING LIST

#### GENERAL NOTES

#### DOCUMENTS:

THESE ARCHITECTURAL DRAWINGS ARE TO BE READ IN CONJUNCTION WITH THE ARCHITECTURAL REPORTS, SCHEDULES AND SPECIFICATIONS. THE ARCHITECTURAL DOCUMENTS DESCRIBE THE DESIGN INTENT AND PERFORMANCE REQUIREMENTS FOR THE PROJECT.

THESE ARCHITECTURAL DRAWINGS ARE TO BE READ IN CONJUNCTION WITH ALL OTHER CONSULTANT'S DRAWINGS. SPECIFICATIONS, AND WRITTEN INSTRUCTIONS AS MAY BE ISSUED AT ANY TIME DURING THE CONTRACT REFER TO THE FOLLOWING DRAWINGS, SPECIFICATIONS AND REPORTS WHICH ARE TO TAKE PRECEDENCE OVER ANY STRUCTURAL, SERVICES, TECHNICAL OR LANDSCAPE INFORMATION SHOWN ON THE ARCHITECTURAL DRAWINGS. SCHEDULES AND SPECIFICATIONS:

- THE GEOTECHNICAL ENGINEER'S REPORT, RECOMMENDATIONS AND SPECIFICATION WHERE PROVIDED.
- THE STRUCTURAL ENGINEER'S DRAWINGS AND SPECIFICATIONS FOR ALL STRUCTURAL REQUIREMENTS AND DETAILS. THE HYDRAULIC ENGINEER'S DRAWINGS AND SPECIFICATIONS FOR ALL HYDRAULIC REQUIREMENTS, REDUCED LEVELS (RL) GRADIENTS/FALLS & DRAINAGE REQUIREMENTS.
- THE SERVICES ENGINEER'S DRAWINGS AND SPECIFICATIONS FOR ALL DRY FIRE SERVICES, ELECTRIC AND MECHANICAL REQUIREMENTS AND DETAILS. LOCATIONS AND POSITIONS TO COORDINATE WITH ARCHITECTURAL REQUIREMENTS.
- THE CIVIL ENGINEER'S DRAWINGS AND SPECIFICATIONS FOR ALL REINFORCED CONCRETE PAVING, ROADS, PATHS, ACCESSWAYS OR PARKING HARDSTAND DETAILS, INCLUDING REDUCED LEVELS (RL), SUB-GRADE, AND CONCRETE KERBING.

THE CONTRACTOR SHALL REPORT ANY DISCREPANCY, ERRORS, OMISSIONS, INCONSISTENCIES OR OTHER FAULTS FOUND IN THE ARCHITECTURAL DOCUMENTATION TO THE CLIENT FOR REVIEW BEFORE PROCEEDING WITH THE WORKS UNLESS NOTED OTHERWISE, ANY WORKS SHOWN ON ONE DRAWING BUT NOT ON ANOTHER, OR SHOWN ON A CONSULTANT'S DRAWING BUT NOT ON THE ARCHITECTURAL DRAWINGS (OR VICE VERSA) ARE DEEMED TO BE INCLUDED IN THE CONTRACT WORKS.

THE CONTRACTOR IS TO ENSURE THAT SUFFICIENT TOLERANCES ARE ALLOWED FOR THE CONSTRUCTION WORKS.

THE CONTRACTOR IS TO ALLOW FOR ALL MATERIAL, EQUIPMENT, ACCESSORIES, LABOUR, ADDITIONAL DESIGN INPUT, PERMITS, APPROVALS AND THE LIKE TO COMPLETE THE WORKS IN ACCORDANCE WITH THIS INTENT AND SCOPE AND FOR THESE WORKS TO BE FIT FOR THEIR INTENDED PURPOSE.

PRIOR TO COMMENCEMENT OF ANY WORKS, THE CONTRACTOR IS TO IDENTIFY ALL EXISTING SERVICES. EXISTING SERVICES IF SHOWN ON ANY DRAWING ARE INDICATIVE ONLY AND ARE TO BE CHECKED AND LOCATED ON SITE. ANY DAMAGE TO EXISTING SERVICES IS TO BE RECTIFIED AT THE CONTRACTOR'S EXPENSE.

NO VARIATIONS WILL BE CONSIDERED UNLESS IT IS A CLEAR CHANGE TO THE INTENT AND SCOPE OF THE WORKS INITIATED IN WRITING BY THE CLIENT.

THESE DRAWINGS ARE COPYRIGHT AND THE PROPERTY OF THE CLIENT, AND MUST NOT BE RETAINED, REPRODUCED, COPIED OR USED, IN WHOLE OR IN PART BY ANY MEDIUM WITHOUT THE WRITTEN AUTHORITY OF THE CLIENT

#### **AUTHORITIES:**

ALL WORKS (INCLUDING BUT NOT LIMITED TO DEMOLITION, CONSERVATION, EXCAVATION & CONSTRUCTION WORKS) ARE TO BE CARRIED OUT IN ACCORDANCE WITH THE PROVISIONS OF THE BUILDING CODE OF AUSTRALIA (BCA), CLAUSE 98 OF THE ENVIRONMENTAL PLANNING & ASSESSMENT REGULATION 2000, THE NSW WORK HEALTH AND SAFETY ACT 2011 AND THE NSW WORK HEALTH AND SAFETY REGULATION 2011.

ALL WORKS (INCLUDING BUT NOT LIMITED TO DEMOLITION, CONSERVATION, EXCAVATION & CONSTRUCTION WORKS) ARE TO BE CARRIED OUT IN ACCORDANCE WITH THE NOTICE OF DETERMINATION OF THE APPLICABLE DEVELOPMENT APPROVAL. CONSTRUCTION SHALL NOT COMMENCE BEFORE THE RELEVANT CONSTRUCTION CERTIFICATE IS ISSUED BY THE PRINCIPAL CERTIFYING AUTHORITY.

THE ARCHITECT IS NOT RESPONSIBLE FOR ANY CHANGES REQUESTED BY ANY AUTHORITIES.

#### **ABORIGINAL ARTEFACTS:**

IF ANY ABORIGINAL OBJECTS ARE FOUND ON THE SITE, STOP WORK AND NOTIFY THE LOCAL COUNCIL, THE NSW OFFICE OF ENVIRONMENT AND HERITAGE, AND THE LOCAL ABORIGINAL LAND COUNCIL

#### **REFERENCE LEVELS:**

ALL SERVICES IMPACTING THE SITE, AND ALL LEVELS REFERRED TO IN THE ARCHITECTURAL DOCUMENTATION, ARE REFERENCED FROM THE SURVEY INFORMATION PROVIDED TO DESIGNINC. AND ARE TO BE CHECKED ON SITE PRIOR TO CONSTRUCTION OR MANUFACTURING. REPORT ANY DISCREPANCIES TO THE CLIENT IMMEDIATELY. ALL LEVELS AND RL'S IN THE DOCUMENTS ARE TO THE AUSTRALIAN HEIGHT DATUM (AHD). A BENCHMARK LEVEL IS TO BE ESTABLISHED ON THE SITE (TO AUSTRALIAN HEIGHT DATUM) TO ENABLE COMPARISON WITH THE FLOOD STANDARD.

#### SETTING OUT:

THE CONTRACTOR IS TO CHECK AND VERIFY ALL SETOUT DIMENSIONS AND LEVELS ON SITE PRIOR TO THE COMMENCEMENT OF ANY RELEVANT PART OF THE WORKS.

ALL SET OUT DIMENSIONS AND LEVELS ARE TO BE CHECKED BY A LICENSED SURVEYOR ON SITE. AND ALL OVERALL AND CRITICAL DIMENSIONS ARE TO BE SET OUT FOR APPROVAL BY THE CLIENT PRIOR TO THE COMMENCEMENT OF ANY CONSTRUCTION OR EXCAVATION.

#### SAMPLES AND SCHEDULES:

PRIOR TO INSTALLATION OR CONSTRUCTION, THE CONTRACTOR IS TO PROVIDE A SAMPLE OF EACH SPECIFIED ELEMENT, COMPLETE WITH THE MANUFACTURER'S CERTIFICATES SHOWING COMPLIANCE WITH THE RELEVANT PERFORMANCE CRITERIA. PLEASE REFER TO ARCHITECTURAL PERFORMANCE SPECIFICATION AND SUBMITTALS SCHEDULE FOR COMPLETE LIST OF SAMPLES AND PROTOTYPES FOR DESIGNER'S REVIEW AND APPROVALS PRIOR TO ORDERING AND INSTALLING DOORS, WINDOWS, DOOR HARDWARE AND OTHER SPECIALIST ELEMENTS SCHEDULED IN THE DOCUMENTS. THE RELEVANT SUB-CONTRACTOR IS TO PROVIDE A RETURN SCHEDULE FOR APPROVAL OF THE CLIENT

#### VesignInc Gadigal Country

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9/12/2024 3:31:36 PM

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BY DAMPNESS OR WATER OVERFLOW SURVEY:

# TRENCHING SITE CLEARING:

EXTENT • REQUIREMENT: CLEAR ONLY AREAS TO BE OCCUPIED BY WORKS SUCH AS STRUCTURES, PAVING, EXCAVATION, REGRADING AND LANDSCAPING OR OTHER AREAS DESIGNATED TO BE CLEARED. CONTRACTOR'S SITE AREAS: IF NOT INCLUDED WITHIN THE AREAS DOCUMENTED ABOVE. CLEAR GENERALLY ONLY TO THE EXTENT NECESSARY FOR THE PERFORMANCE OF THE WORKS. CLEARING AND GRUBBING CLEARING: REMOVE EVERYTHING ON OR ABOVE THE SITE SURFACE. INCLUDING RUBBISH. SCRAP. GRASS. VEGETABLE MATTER AND ORGANIC DEBRIS, SCRUB, TREES, TIMBER, STUMPS, BOULDERS AND RUBBLE. GRUBBING: GRUB OUT STUMPS AND ROOTS OVER 75mm DIAMETER TO A MINIMUM DEPTH OF 500mm BELOW SUBGRADE UNDER BUILDINGS, EMBANKMENTS OR PAVING, OR 300mm BELOW FINISHED SURFACE IN UNPAVED AREAS. BACKFILL HOLES REMAINING AFTER GRUBBING WITH SAND MATERIAL TO PREVENT PONDING OF WATER. COMPACT THE MATERIAL TO THE RELATIVE DENSITY OF THE EXISTING ADJACENT GROUND MATERIAL.CLEARING AND GRUBBING WILL APPLY TO MOST AREAS. CONSIDER RE-USING LAND CLEARING DEBRIS SUCH AS MULCHING TREES, STUMPS AND OTHER WOODY VEGETATION FOR RE-USE ON-SITE TO MINIMISE WASTE. BATTERS

#### **DEMOLITION:**

ALL DEMOLITION WORK AND CONSTRUCTION WORK METHODS TO COMPLY WITH THE NSW WORK HEALTH AND SAFETY ACT 2011, OH&S ACT2000, OH&S REGULATION 2001 AND ALL OTHER OH&S REQUIREMENTS

ALL PRACTICES TO BE COMPLIANT WITH LEGISLATION AND CODES ADMINISTERED BY SAFEWORK NSW. ALL WORKS UNDERTAKEN TO COMPLY WITH AS2601: THE DEMOLITION OF STRUCTURES AND OTHER RELEVANT AUSTRALIAN STANDARDS, AND THE LOCAL AUTHORITY'S STATUTORY REQUIREMENTS AND THE CONDITIONS OF DEVELOPMENT CONSENT UNDERTAKE ALL WORKS TO MINIMISE DISRUPTION, DUST AND NOISE TO THE SITE. READ DEMOLITION DRAWINGS IN CONJUNCTION WITH PROPOSED NEW WORKS DOCUMENTS PREPARED BY THE ARCHITECT AND ALL OTHER CONSULTANTS. INCLUDING STRUCTURAL AND SERVICES ENGINEERS.

UNLESS REQUIRED OTHERWISE IN THE CONTRACT PRELIMINARIES, PROVIDE SOLID, PAINTED HOARDINGS TO PERIMETER OF WORKS ZONE, COMPLETE WITH STATUTORY SIGNAGE, TO LOCAL AUTHORITIES' SATISFACTION, AGREE HOARDING LOCATIONS WITH CLIENT PRIOR TO ORDERING OR PLACEMENT OF HOARDINGS.

CO-ORDINATE AND CONFIRM TIMING OF ALL DEMOLITION WITH CLIENT PRIOR TO COMMENCEMENT.

#### **DAMP & WEATHERPROOFING:**

THE WORKS ARE TO COMPLY WITH BCA VOLUME 1, PART F1 FOR DAMP AND WEATHERPROOFING.

WEATHERPROOFING OF EXTERNAL AREAS AND EXTERNAL ENVELOPE AND EXTERNAL ABOVE GROUND MEMBRANES MUST TO COMPLY TO AS 4564 PARTS 1 AND 2.

THE BUILDING AND ANY ASSOCIATED SITE WORK IS TO BE CONSTRUCTED IN A WAY THAT

· PROTECTS PEOPLE AND OTHER PROPERTY FROM THE ADVERSE EFFECTS OF REDIRECTED SURFACE WATER; · PROVIDES RESISTANCE TO MOISTURE PENETRATING FROM THE OUTSIDE INCLUDING RISING FROM THE GROUND; AND · AVOIDS THE CREATION OF UNHEALTHY OR DANGEROUS CONDITIONS: AND DAMAGE TO BUILDING ELEMENTS. CAUSED

 THE CONTRACTOR IS REQUIRED TO NOTIFY THE CLIENT IMMEDIATELY UPON DISCOVERY OF ANY VARIANCES TO THE SURVEY DATA.

THE TOPOGRAPHICAL SURVEY INFORMATION SHOWN ON DRAWINGS HAS BEEN PROVIDED TO

DESIGNINC SYDNEY. THE ARCHITECT DOES NOT GUARANTEE THAT THE SURVEY INFORMATION IS

ACCURATE AND ACCEPTS NO LIABILITY FOR INACCURACIES.

 THE SURVEY HAS BEEN COMPILED BASED ON A GROUND SURVEY DATA OBTAINED DURING THE DESIGN PROCESS. THE LEVEL DATUM REFERRED TO IN THESE DRAWINGS IS AUSTRALIAN HEIGHT DATUM (AHD)

THE SURVEY COORDINATE SYSTEM IS MAP GRID OF AUSTRALIA (MGA).

#### **BEFORE COMMENCING EARTHWORKS:**

**REQUIREMENT**: BEFORE COMMENCING EARTHWORKS, LOCATE AND MARK EXISTING UNDERGROUND SERVICES IN THE AREAS WHICH WILL BE AFFECTED BY THE EARTHWORKS OPERATIONS INCLUDING CLEARING, EXCAVATING AND

 UTILITY SERVICES: CONTACT DIAL BEFORE YOU DIG TO IDENTIFY LOCATION OF UNDERGROUND UTILITY SERVICES PIPES AND CABLES.

DIAL BEFORE YOU DIG IS A FREE SERVICE, FROM ANYWHERE IN AUSTRALIA, FOR IDENTIFYING UNDERGROUND PIPE AND CABLES (POSSIBLE WITHIN TWO WORKING DAYS). SEE WWW.1100.COM.AU. IT ONLY PROVIDES INFORMATION ON UTILITY SERVICES (POWER, WATER, GAS AND TELECOMMUNICATIONS) AND NOT ALL UTILITY SERVICE OPERATORS ARE PART OF THE SCHEME. THE PLANS PROVIDE INFORMATION ABOUT THE PRESENCE OF A SERVICE, NOT THE EXACT LOCATION. **EXCAVATION:** DO NOT MACHINE EXCAVATE WITHIN 1m OF EXISTING UNDERGROUND SERVICES.

EXISTING SERVICE LINES: IF REQUIRED, DIVERT SERVICES DETECTED DURING EXCAVATION TO NEW ROUTES, CLEAR OF THE BUILDING. AND RECONNECT TO THE NETWORK UTILITY OPERATOR'S REQUIREMENTS.

PRE CLEARING SURVEYS AND INSPECTIONS FOR ENDANGERED AND THREATENED FLORA AND FAUNA SPECIES WOULD BE UNDERTAKEN BY QUALIFIED ECOLOGISTS PRIOR TO ANY CLEARING OCCURRING. THE SURVEYS AND INSPECTIONS, AND ANY SUBSEQUENT RELOCATION OF SPECIES, WOULD BE UNDERTAKEN IN ACCORDANCE WITH THE MEASURES PROVIDED IN THE BIODIVERSITY ASSESSMENT REPORT.

 A TRAINED ECOLOGIST SHOULD BE PRESENT DURING THE CLEARING OF NATIVE VEGETATION OR REMOVAL OF POTENTIAL FAUNA HABITAT TO AVOID IMPACTS ON RESIDENT FAUNA AND TO SALVAGE HABITAT RESOURCES AS FAR AS IS PRACTICABLE

TEMPORARY PROTECTION: WHERE CHANGE IN LEVEL BETWEEN CREST AND TOE IS MORE THAN 1.5m, PROTECT FROM EROSION WITH GEOFABRIC, A HESSIAN AND TAR OR HEAVY-DUTY BLACK POLYTHENE SHEET WATERPROOF COVER. SEAL JOINTS AND SECURELY FIX DOWN AT CREST AND TOE.

#### SURPLUS MATERIAL

COORDINATE WITH NATSPEC 0222 EARTHWORK FOR STRIPPING. REMOVAL. STOCKPILING AND DISPOSAL OF TOPSOIL TOPSOIL AND EXCAVATED MATERIAL: CONTINUALLY REMOVE UNWANTED STRIPPED SOIL AND OTHER MATERIAL FROM THE SITE AS THE WORK PROCEEDS. INCLUDING ANY MATERIAL DROPPED ON FOOTPATHS OR ROADWAYS

#### CLIENT



#### **BOB PRENTER RESERVE** AMENITY BUILDING

PROJECT ADDRESS Fields Rd, Macquarie Fields NSW 2564

#### SUB-SOIL: RIPPING

•

- AND COMPACTION.
- COMPACTED SUBSOIL: 300mm

#### PLANTING BEDS

- OF 100mm.
- TO 75mm BELOW FINISHED DESIGN LEVELS. CULTIVATION
- MINIMUM DEPTH: 150mm.
- BY HAND.

#### **TOPSOIL & SOIL REPORT:**

- TOPSOIL MANAGEMENT
- CONFIRMS WITH AS4419.
- PLACING TOPSOIL

  - ALLOWANCES TO PERMIT THE FOLLOWING:
  - MOWING STRIPS.
  - OF BATTER DISTURBANCE.
- CONSOLIDATION

GENERAL: COMPACT LIGHTLY AND UNIFORMLY IN 150mm LAYERS. AVOID DIFFERENTIAL SUBSIDENCE AND EXCESS COMPACTION AND PRODUCE A FINISHED TOPSOIL SURFACE WHICH HAS THE FOLLOWING CHARACTERISTICS: FINISHED TO DESIGN LEVELS.

- - READY FOR PLANTING.
  - TOPSOIL DEPTHS
  - EXCAVATED MASS PLANTING AREAS (400mm) • TREE PITS (800mm)
- SURPLUS TOPSOIL
- SUB-SOIL
- TREE PITS (800mm)

#### WORK-IN-PROGRESS

A 9.12.24 ISSUED FOR COORDIINATION DATE BEVISIONS

DRAWN BY KF CHECKED BY MD APPROVED BY MW

 TOPSOIL SPREAD OVER SUBSOIL NEEDS TO BE LOCKED TOGETHER TO MINIMISE TOPSOIL EROSION. CONSIDER RIPPING AFTER THE SPREADING OF TOPSOIL IF APPROPRIATE TO THE SITE CONDITIONS REGARDING ACCESS

• GENERAL: RIP PARALLEL TO THE FINAL CONTOURS. DO NOT RIP WHEN THE SUBSOIL IS WET OR PLASTIC. DO NOT RIP WITHIN THE DRIPLINE OF TREES AND SHRUBS TO BE RETAINED. RIPPING DEPTHS: RIP THE SUBSOIL TO THE FOLLOWING TYPICAL DEPTHS:

HEAVILY COMPACTED CLAY SUBSOIL: 450mm

• EXCAVATED: EXCAVATE TO BRING THE SUBSOIL TO AT LEAST 300mm BELOW FINISHED DESIGN LEVELS. SHAPE THE SUBSOIL TO FALL TO SUBSOIL DRAINS WHERE REQUIRED. BREAK UP THE SUBSOIL TO A FURTHER DEPTH

UNEXCAVATED: REMOVE WEEDS, ROOTS, BUILDER'S RUBBISH AND OTHER DEBRIS. BRING THE PLANTING BED

THE 150mm MINIMUM DEPTH ASSUMES THAT THE SUBSOIL IS OF SUFFICIENTLY GOOD QUALITY AND IT THEREFORE IS NOT NECESSARY TO EXCAVATE AND TO IMPORT TOPSOIL. THIS DEPTH MAY NOT BE ACHIEVABLE ON ROCKY OR STEEP AREAS. VARY IF REQUIRED. SERVICES AND ROOTS: DO NOT DISTURB SERVICES OR TREE ROOTS. IF REQUIRED CULTIVATE THESE AREAS

CULTIVATION: MIX IN MATERIALS REQUIRED TO BE INCORPORATED INTO THE SUBSOIL. CULTIVATE MANUALLY WITHIN 300mm OF PATHS OR STRUCTURES. REMOVE STONES EXCEEDING 25mm, CLODS OF EARTH EXCEEDING 50mm, AND WEEDS, RUBBISH OR OTHER DELETERIOUS MATERIAL BROUGHT TO THE SURFACE DURING CULTIVATION. TRIM THE SURFACE TO DESIGN LEVELS AFTER CULTIVATION.

 GENERAL: IF THE TOPSOIL OF DOCUMENTED QUALITY CANNOT BE PROVIDED FROM MATERIAL RECOVERED FROM THE SITE, PROVIDE IMPORTED TOPSOIL. REFER TO SOILS REPORT PREPARED BY NOMINATED SOIL SCIENTIST TO DETERMINE SOIL REQUIREMENTS FOR LANDSCAPE AREAS. WHERE THE REPORT INDICATES THAT SOILS IS NOT TO BE RE-USED, NEW IMPORTED TOPSOIL MUST BE USED WITHIN NEW PLANTING AREAS. TOPSOIL MANAGEMENT IMPORTED ORGANIC TOPSOIL MUST BE 'WEED-FREE' AND ORGANIC SOIL MIX THAT

• AREAS TO RECEIVE TOPSOIL AND THE TOPSOIL DEPTHS MUST BE PROVIDED AS PER DETAILS. TYPICALLY, THE AREAS WOULD BE THOSE REQUIRED TO BE GRASSED, TURFED, TREE PITS OR MASS PLANTED. GENERAL: SPREAD THE TOPSOIL ON THE PREPARED SUBSOIL AND GRADE EVENLY, MAKING THE NECESSARY

REQUIRED FINISHED LEVELS AND CONTOURS MAY BE ACHIEVED AFTER LIGHT COMPACTION. GRASSED AREAS MAY BE FINISHED FLUSH WITH ADJACENT HARD SURFACES SUCH AS KERBS, PATHS AND

WHEN SPREADING TOPSOIL ON STEEP BATTERS, IF USING A CHAIN DRAG, MAKE SURE THERE IS NO DANGER

FINISHING: FEATHER EDGES INTO ADJOINING UNDISTURBED GROUND.

SMOOTH AND FREE FROM STONES OR LUMPS OF SOIL.

GRADED TO DRAIN FREELY, WITHOUT PENDING, TO CATCHMENT POINTS.

GRADED EVENLY INTO ADJOINING GROUND SURFACES.

GENERAL: SPREAD TOPSOIL TO THE FOLLOWING TYPICAL DEPTHS:

GENERAL: SPREAD SURPLUS TOPSOIL ON DESIGNATED AREAS ON SITE OR DISPOSE OFF-SITE.

GENERAL: RIP PARALLEL TO FINAL CONTOURS. DO NOT RIP WHEN THE SUBSOIL IS WE OR PLASTIC. DO NOT RIP WITHIN THE DRIPLINE OF TREES AND SHRUBS TO BE RETAINED. RIP THE SUBSOIL TO THE FOLLOWING DEPTHS: GARDEN BEDS AND MASS PLANTING AREAS (300mm)

#### NOT FOR CONSTRUCTION DRAWING TO BE PRINTED IN COLOUR

**GENERAL NOTES - SHEET 1** 

STATUS DETAILED DESIGN SCALES

DRAWING NO. **BPR-DIS-LA-DRG-10002** 



#### **GENERAL NOTES CONTINUED**

#### PLANTING:

#### GENERAL

PROVIDE PLANT MATERIAL AS DETAILED ON THE PLANTING PLANS AND IN THE PLANT SCHEDULE. ALL PLANTS TO BE TRUE TO SPECIES OR CULTIVARS AS NAMED. PLANTS MUST BE WELL GROWN, HEALTHY, OF GOOD FORM AND NOT FORCED GROWN. SIZE MUST BE PROPORTIONATE TO CONTAINER SIZE WITH WELL ESTABLISHED ROOTBALL, BUT **NOT** ROOT BOUND. PLANTS MUST BE FREE FROM DAMAGE, PEST AND DISEASES. SUPPLY TREES THAT HAVE BEEN GROWN IN ACCORDANCE WITH AS2303-2015

#### CULTIVATION

- MINIMUM DEPTH: 200mm.
- THE 200mm MINIMUM DEPTH ASSUMES THAT THE SUBSOIL IS OF SUFFICIENTLY GOOD QUALITY AND IT THEREFORE IS NOT NECESSARY TO EXCAVATE AND TO IMPORT TOPSOIL. THIS DEPTH MAY NOT BE ACHIEVABLE ON ROCKY OR STEEP AREAS. VARY IF REQUIRED
- SERVICES AND ROOTS: DO NOT DISTURB SERVICES OR TREE ROOTS. IF REQUIRED CULTIVATE THESE AREAS BY HAND.
- CULTIVATION: MIX IN MATERIALS REQUIRED TO BE INCORPORATED INTO THE SUBSOIL. CULTIVATE MANUALLY WITHIN 300mm OF PATHS OR STRUCTURES. REMOVE STONES EXCEEDING 25mm, CLODS OF EARTH EXCEEDING 50mm, AND WEEDS, RUBBISH OR OTHER DELETERIOUS MATERIAL BROUGHT TO THE SURFACE DURING CULTIVATION. TRIM THE SURFACE TO DESIGN LEVELS AFTER CULTIVATION.

#### PREPARATION OF PLANTING

- EXCAVATE TO 150mm BELOW FINISHED LEVELS OF PLANTING BEDS. CULTIVATE SUBGRADE TO MINIMUM 200mm AT THE BASE OF THE PLANTING BEDS. FILL WITH AMELIORATED SITE SOIL OR IMPORTED SOIL MIX, AS SPECIFIED. OVERFILL AND CONSOLIDATE PLANTING BEDS WITH SOIL AND COMPACT TO 85% MMDD. ALLOW FOR FUTURE SETTLEMENT
- NO WORK TO BE CARRIED OUT ON PLANTED AREAS WHILST SOIL IS WET, TO AVOID COMPACTION OF THESE AREAS. RAKE UP ALL LARGE STONES, PIECES OF TIMBER AND OTHER DEBRIS FROM PROPOSED PLANTED AND TURF AREAS. REMOVE DEBRIS FROM SITE. ALLOW PREPARED SOIL TIME TO CURE PRIOR TO INSTALLING PLANTS. ENSURE THAT ALL PLANTED AREAS DRAIN SATISFACTORILY. IF DRAINAGE PROBLEMS EXIST WITH REGARD TO EXISTING SUBGRADE CONDITIONS, ADVISE SUPERINTENDENT AND AWAIT FURTHER INSTRUCTIONS.
- COMPLETE SOIL PREPARATIONS TO THE APPROVAL OF THE LANDSCAPE ARCHITECT. PROVIDE CUBIC METRE RATES FOR SUPPLY AND INSTALLATION (INCLUDING CULTIVATION) OF SOIL CONDITIONER AND ORGANIC SOIL MIX SHOULD ADDITIONAL QUANTITIES OF THESE MATERIALS BE REQUIRED. TRIM SURFACE TO FINAL DESIGN LEVELS ALLOWING FOR FINISHED SURFACE TREATMENTS.

#### INSTALLATION

- PREPARE PLANTING HOLES TO SAME DEPTH AS ROOTBALL AND THRICE THE WIDTH OF THE ROOTBALL WHICH THEY ARE TO RECEIVE. LOOSEN THE BASE OF THE PLANTING HOLE TO 150mm DEPTH. BREAKUP ANY SMOOTH SIDES TO THE HOLE.
- INSTALL PLANTS PLUMB AND SO THAT TOP OF ROOTBALL IS FLUSH WITH FINISHED SURFACE LEVEL OF PLANTING BED. BACKFILL WITH FRIABLE SOIL
- FORM A DISH AT THE BASE OF EACH PLANT TO AID WATER COLLECTION AND ABSORPTION. THOROUGHLY WATER THE PLANTS BEFORE PLANTING, IMMEDIATELY AFTER PLANTING, AND AS REQUIRED TO MAINTAIN GROWTH RATES FREE OF STRESS, ENSURE PLANTS ARE KEPT WELL WATERED UNTIL THE END OF THE MAINTENANCE PERIOD.

#### PLACING

REMOVE THE PLANT FROM THE CONTAINER WITH MINIMUM DISTURBANCE TO THE ROOT BALL. MAKE SURE THAT THE ROOT BALL IS MOIST AND PLACE IT IN ITS FINAL POSITION, IN THE CENTRE OF THE HOLE AND PLUMB, AND WITH THE TOP SOIL LEVEL OF THE PLANT ROOT BALL LEVEL WITH THE FINISHED SURFACE OF THE SURROUNDING SOIL.

#### BACKFILLING

WHERE REQUIRED BACKFILL WITH TOPSOIL MIXTURE AS SPECIFIED ON DRAWINGS AND MATERIALS SCHEDULE. TAMP LIGHTLY AND WATER TO ELIMINATE AIR POCKETS. MAKE SURE THAT TOPSOIL IS NOT PLACED OVER THE TOP OF THE ROOT BALL. SO THE PLANT STEM REMAINS THE SAME HEIGHT ABOVE GROUND AS IT WAS IN THE CONTAINER.

#### ADJUSTMENTS & SUBSTITUTIONS

- IF IT APPEARS NECESSARY TO VARY PLANT LOCATIONS AND SPACINGS TO AVOID SERVICE LINES, OR TO COVER THE AREA UNIFORMLY. OR FOR OTHER REASONS. GIVE NOTICE & AWAIT INSTRUCTIONS.
- IF A NOMINATED SPECIES IS COMPLETELY OR PARTIALLY UNAVAILABLE IN THE QUANTITIES REQUIRED, NOTIFY AND AWAIT INSTRUCTIONS. SIMILAR SUBSTITUTE SPECIES MAY BE SUGGESTED BY CONTRACTOR FOR CONSIDERATION.

#### REPLACEMENTS

REPLACE FAILED, DEAD AND/OR DAMAGED PLANTS AT MAXIMUM 3 WEEK INTERVALS AS NECESSARY THROUGHOUT THE FULL PLANT ESTABLISHMENT PERIOD.

#### INDIVIDUAL PLANTINGS IN PLANTED AREAS

EXCAVATE A HOLE TWICE THE DIAMETER OF THE ROOT BALL AND AT LEAST 100mm DEEPER THAN THE ROOT BALL. BREAK UP THE BASE OF THE HOLE TO A FURTHER DEPTH OF 100mm. AND LOOSEN COMPACTED SIDES OF THE HOLE TO PREVENT CONFINEMENT OF ROOT GROWTH.

#### RIPLINE PLANTING

- RIP THE ROW AND EXCAVATE A PLANT HOLE FOR EACH PLANT LARGE ENOUGH TO ACCEPT THE ROOT BALL PLUS 0.1m<sup>3</sup> OF BACKFILLING WITH TOPSOIL. CLEAR WEEDS AND OTHER VEGETATIVE MATERIAL WITHIN 300mm RADIUS OF THE PLANTS. IF PLANTING HOLES ARE EXCAVATED BY MECHANICAL MEANS INCREASE THE HOLE SIZE BY 100mm AND LOOSEN COMPACTED SIDES TO PREVENT CONFINEMENT OF ROOT GROWTH.
- DEVELOPMENTS IN TUBESTOCK PLANTING USING PURPOSE-MADE MACHINERY SHOWS TO BE AN ECONOMICALLY VIABLE TOOL FOR BROAD SCALE REVEGETATION. SPECIFICATION WILL DEPEND ON MACHINERY AND SITE CONDITIONS. BACKFILLING WITH TOPSOIL MAY NOT BE NECESSARY.

#### PLANTING CONDITIONS

- WEATHER: DO NOT PLANT IN UNSUITABLE WEATHER CONDITIONS SUCH AS EXTREME HEAT, COLD, WIND OR RAIN. IN OTHER THAN SANDY SOILS. SUSPEND EXCAVATION WHEN THE SOIL IS WET. OR DURING FROST PERIODS.
- WATERING
- GENERAL: MANUALLY WATER ALL PLANTING AREAS IN THE ABSENCE OF AN IRRIGATION SYSTEM OR UNTIL THE PROPOSED IRRIGATION SYSTEM IS FULLY OPERATIONAL
- BEFORE PLANTING: THOROUGHLY WATER THE PLANTS BEFORE PLANTING, IMMEDIATELY AFTER PLANTING, AND AS **REQUIRED TO MAINTAIN GROWTH RATES FREE OF STRESS**
- AFTER PLANTING: ENSURE SUFFICIENT WATERING TO JUVENILE PLANTING IN INITIAL MONTH OF PLANTING AND GRADUALLY REDUCE WATER REGIME TO HARDEN PLANTS TO ON-SITE CONDITIONS. WATER 3 TIME PER WEEK DURING FIRST MONTH OF PLANTING.
- APPLICATION RATES: SOAK TO A DEPTH OF 300mm FOR PLANTING. AVOID FREQUENT DAMPENING OF THE SURFACE. ALLOW THE SURFACE OF THE SOIL TO PARTIALLY DRY OUT BETWEEN WATERINGS. CONFIRM SOAKED DEPTH AND RECORD IN THE LOG BOOK.

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- STAKES STAKE SIZES: •
- FOR TREES INSTALLED AT 25L T0 45L: TWO (2) 38x38x1800mm STAKES PER TREE.
- FOR TREES INSTALLED AT 75L TO 100L: THREE (3) 50x50x2400mm STAKES PER TREE

 TIMING: WATER AT TIMES OF DAY TO MINIMISE WATER EVAPORATION LOSS. DO NOT WATER DURING THE HOTTEST PERIOD OF SUMMER DAYS.

 WATER RESTRICTIONS: COORDINATE THE WATER SUPPLY AND CONFIRM THE WATERING REGIME AGAINST LEGISLATION AND RESTRICTIONS APPLYING AT THE TIME

FERTILISING

 DESCRIPTION: PROPRIETARY FERTILISERS, DELIVERED TO THE SITE IN SEALED BAGS MARKED TO SHOW MANUFACTURER OR VENDOR, WEIGHT, FERTILISER TYPE, N:P:K RATIO. RECOMMENDED USES AND APPLICATION RATES. BASED THE PROGRAM ON SOIL TESTING REPORT

 IF USING IN NATIVE SHRUB / TREE GARDENBEDS, ENSURE FERTILIZER IS SUITABLE FOR AUSTRALIAN NATIVE PLANTS AND DOES NOT CONTAIN PHOSPHORUS. APPLY A 12 MONTH SLOW RELEASE FERTILISER. IN TWO ROWS AND CULTIVATED INTO SOIL TO A DEPTH OF 100mm.

#### MULCHING: SUPPLY & INSPECTION OF ORGANIC MULCH

 APPLICABLE STANDARD • AS4454 AND RMS R179, M321, M322

#### ACCEPTANCE CRITERIA

ORGANIC MULCH MUST, TO THE EXTENT POSSIBLE, BE DERIVED FROM TREES, SHRUBS AND ANY OTHER VEGETATIVE MATERIAL THAT IS ACCEPTABLE TO THE SOIL SCIENTIST FOR USE AS MULCH, REMOVED DURING THE SITE CLEARING AND GRUBBING WORKS ON THE SITE. IF THE MULCH PRODUCED IS INSUFFICIENT, MAKE UP THE SHORTFALL BY USING IMPORTED HARDWOOD CHIP THAT COMPLIES WITH AS4454, OR WITH WRITTEN APPROVAL FROM RMS, TUB GROUND MULCH MAY BE USED. HARDWOOD CHIP MUST COMPLY WITH THE FOLLOWING REQUIREMENTS:

- HARDWOOD CHIP MUST ONLY BE DERIVED FROM WASTE HARDWOOD TIMBER
- 2 THE SOURCE OF HARDWOOD CHIPS MUST BE PROVIDED
- THE MATERIAL MUST COMPRISE OF HARDWOOD CHIPS WITH NOT MORE THAN 5% FINES BY VOLUME AND 3 MUST NOT CONTAIN ANY BARK
- 4. THE AVERAGE SIZE OF THE WOODCHIP MUST BE APPROXIMATELY 30mmX 20mmX 5mmAND THE MAXIMUM LENGTH OF CHIP MUST NOT EXCEED 50mm
- 5. HARDWOOD CHIP MUST BE FREE OF FOREIGN MATERIAL
- SURVEILLANCE, VERIFICATION RECORD AND COMMENTS CONTRACTOR MUST OBTAIN A CERTIFICATE OF CONFORMITY FOR THE SUPPLY AND INSPECTION OF ORGANIC
  - MULCH PRIOR TO PROCUREMENT.
  - CONTRACTOR TO PROVIDE A PHYSICAL REPRESENTATIVE SAMPLE ALONG WITH CERTIFICATE OF
  - CONFORMITY TO LANDSCAPE ARCHITECT FOR APPROVAL PRIOR TO PROCUREMENT.
- CONTRACTOR TO CONDUCT A VISUAL INSPECTION:
  - DURING UNLOADING AND APPLICATION OF MULCH
  - DOCUMENT VISUAL INSPECTION INCLUDING AS A MINIMUM: 2
  - LOCATION
  - DATE AND TIME OF VISUAL INSPECTION
  - 5 NAME OF INSPECTOR
  - PRODUCT AND MULCH GENERATOR NAME
  - VOLUME OF MATERIAL
  - PHOTOGRAPHIC RECORD OF THE INSPECTION 8.

#### PLACING MULCH

• GENERAL: PLACE MULCH TO THE REQUIRED DEPTH, CLEAR OF PLANT STEMS, AND RAKE TO AN EVEN SURFACE FLUSH WITH THE SURROUNDING FINISHED LEVELS. SPREAD AND ROLL MULCH SO THAT AFTER SETTLING. OR AFTER ROLLING, IT IS SMOOTH AND EVENLY GRADED BETWEEN DESIGN SURFACE LEVELS SLOPED TOWARDS THE BASE OF PLANT STEMS IN PLANTATION BEDS. AND NOT CLOSER TO THE STEM THAN 50mm IN THE CASE OF GRAVEL MULCHES.

 IN MASS PLANTED AREAS: PLACE AFTER THE PREPARATION OF THE PLANTING BED BUT BEFORE PLANTING AND OTHER WORK

• IN SMALLER AREAS (E.G. PLANTER BOXES): PLACE AFTER THE PREPARATION OF THE PLANTING BED, PLANTING AND OTHER WORK.

• MULCH ALL PLANTING BEDS TO A DEPTH OF 75mm WITH APPROVED ORGANIC MULCH AS SPECIFIED, OR APPROVED EQUIVALENT

 ON SLOPES THAT ARE 1:3 OR STEEPER. INSTALL JUTE EROSION CONTROL MESH BLANKET IN ACCORDANCE WITH THE MANUFACTURER'S RECOMMENDATION.

 PROVIDE MULCH WHICH IS FREE OF DELETERIOUS AND EXTRANEOUS MATTER SUCH AS SOIL, WEEDS, ROCKS AND TWIGS. DO NOT INCLUDE FINE MULCH

MULCH TO EXISTING VEGETATION

SUPPLEMENT EXISTING MULCH TO PROVIDE A CONSISTENT 75mm LAYER OF MULCH AROUND EXISTING PLANTS. ENSURE MULCH DOES NOT COVER PLANT STEM.

GENERAL: APPLY STAKES TO SECURE YOUNG PLANTS AND TREES FROM WIND DAMAGE. REFER DETAIL DRAWINGS. MATERIAL: HARDWOOD, STRAIGHT, FREE FROM KNOTS OR TWISTS, POINTED AT ONE END.

INSTALLATION: DRIVE STAKES INTO THE GROUND AT LEAST ONE THIRD OF THEIR LENGTH, AVOIDING DAMAGE TO THE ROOT SYSTEM

• TIES: PROVIDE TIES FIXED SECURELY TO THE STAKES, ONE TIE AT HALF THE HEIGHT OF THE MAIN STEM, OTHERS AS NECESSARY TO STABILISE THE PLANT. ATTACH TIES LOOSELY SO AS NOT TO RESTRICT PLANT GROWTH. TIE TYPE: FOR TREES: 50mm HESSIAN WEBBING STAPLED TO THE STAKE.

#### CLIENT



#### **BOB PRENTER RESERVE** AMENITY BUILDING

PROJECT ADDRESS Fields Rd, Macquarie Fields NSW 2564

#### LANDSCAPE MATERIALS AND/OR MATERIALS FOR SITE WORKS GENERAL

- **CRITERIA:**
- SUPPLIER OR LICENSED QUARRY.
- SUPPLIED BY A LICENSED SUPPLIER.
- COPIES OF LICENSES.

#### LANDSCAPE MAINTENANCE GENERAL

- MONTHLY MAINTENANCE REPORTS
- REMOVAL OF WASTE FROM MAINTENANCE WORK

  - REMOVAL OF WEED IN ALL PLANTING AREAS

  - PROPER WORKING ORDER.
  - SET OUT IN THE ARBORIST REPORT
- WITH SUPERINTENDENT.

#### INSTALLATION OF PROPRIETARY FURNITURE

- BENCHES AND SEATS

#### COMPLETION

PRIOR TO REQUESTING PRACTICAL COMPLETION. MAKE GOOD ANY DAMAGED AREAS DAMAGED BY CONSTRUCTION ACTIVITIES. LEAVE THE ENTIRE WORKS AREA IN A TIDY CONDITION AND TO THE SATISFACTION OF THE SUPERINTENDENT. REMOVE FROM SITE ALL UNWANTED MATERIAL AND DEBRIS RESULTING FROM THIS WORK.

#### AREAS DISTURBED BY CONTRACTOR

WHERE THE EXISTING VEGETATION AND LANDSCAPE IS DISTURBED BY THE CONTRACTORS ACTIVITIES, RESTORE THE VEGETATION AND LANDSCAPE TO A CONDITION EQUIVALENT TO THE CONDITION PRIOR TO THE COMMENCEMENT OF THE CONTRACTOR'S ACTIVITIES. RECORD ALL AREAS RESTORED AND REVEGETATED. MAINTAINING GOOD RECORDS OF AREAS TREATED. HOW AREAS WERE REVEGETATED. INCLUDING SOIL PREPARATION AND VEGETATION.

#### WORK-IN-PROGRESS

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ALL MATERIAL IMPORTED FOR LANDSCAPE WORKS OR ASSOCIATED SITE WORKS MUST MEET THE FOLLOWING

NATURAL MATERIALS (CLAY, GRAVEL, SAND, SOIL ROCK) TO BE SUPPLIED BY A LICENSED LANDSCAPE

RECYCLED MATERIALS (SUCH AS GLASS SAND, CRUSHED CONCRETE, SOIL MIXES AND MULCH) MUST BE

PROVIDE SUPERINTENDENT WITH CERTIFICATES VALIDATING THE QUALITY OF THE SUPPLIED MATERIALS AND

 MAINTAIN THE SITE FOR A PERIOD OF 12 MONTHS OR TO SYDNEY METRO OPERATIONS WHICHEVER OCCURS FIRST. STATE IN THE TENDER THE NUMBER OF DAYS THAT HAVE BEEN ALLOWED TO MAINTAIN THE SITE AND KEEP A LOG BOOK OF MAINTENANCE WORKS.CONTRACTOR MUST RECORD ALL MAINTENANCE WORKS AND PERSONNEL INVOLVED IN UNDERTAKING MAINTENANCE WORK. INCLUDING SITE HOURS. ENSURE PLANTING AREAS ARE MAINTAINED TO BE KEPT VISUALLY PLEASING AND HEALTHY. WITH VIGOROUS GROWTH. SUBMIT

 REVIEW THE SITE ON A WEEKLY BASIS FOR THE FIRST 3 MONTHS TO CARRYOUT MAINTENANCE WORKS, THEN REDUCE THE FREQUENCY TO ONCE A MONTH. EXECUTE THE FOLLOWING MAINTENANCE WORKS:

REMOVAL OF LEAF LITTER FORTNIGHTLY DURING LEAF FALL

ENSURE MULCH IS COVERING SOIL AND REPLENISH TO DESIGN LEVELS WHERE REQUIRED. INSPECT AND CLEAN ALL DRAINAGE STRUCTURES AND PIT COVERS AND MAKE SURE THEY ARE IN

PRUNE AS DIRECTED OF BRANCHES OR CANOPY AS NECESSARY IN ACCORDANCE WITH AS4373 OR AS

WATER, RE-INSTATE MULCH AS NECESSARY TO MAINTAIN SPECIFIED DEPTHS

REPLACE ANY FAILED PLANTS AT THE CONTRACTOR'S COST

REPLACE ANY FAULTY COMPONENTS TO THE AUTOMATIC IRRIGATION SYSTEM.

 ENSURE 85% OF PLANTED AREAS ARE IN PLACE AND HEALTHY AT ALL TIMES. NO AREA GREATER THAN 1000X1000 ARE TO BE LEFT UNPLANTED AT ANYTIME.USE ORIGINAL SPECIFIED PLANT MATERIAL FOR REPLACEMENTS, UNLESS OTHERWISE APPROVED BY THE LANDSCAPE ARCHITECT. ONE WEEK BEFORE THE END OF THE MAINTENANCE PERIOD, REMOVE ALL STAKES, ENSURE MULCH IS TOPPED UP TO DESIGN LEVELS, APPLY SPECIFIED SLOW RELEASE FERTILISER TO ALL PLANTING AREAS AND CARRY OUT FINAL INSPECTION

 DELIVER, UNLOAD AND STORE PRODUCTS AND ACCESSORIES IN SEALED MANUFACTURER'S PACKAGING AND SUBMIT THE MANUFACTURER'S PUBLISHED PRODUCT WARRANTIES.


 CUSTOM BUILT FURNITURE AND FIXTURES: SUBMIT SHOP DRAWINGS TO A SCALE THAT BEST DESCRIBES THE DETAILS, SHOWING METHODS OF CONSTRUCTION, ASSEMBLY AND INSTALLATION, WITH DIMENSIONS AND TOLERANCES ERECT FURNITURE ITEMS LEVEL, WHERE INSTALLED ON SLOPES, PROVIDE A LEVEL AREA AROUND

#### NOT FOR CONSTRUCTION DRAWING TO BE PRINTED IN COLOUR

**GENERAL NOTES - SHEET 2** 

DRAWING NO BPR-DIS-LA-DRG-10003



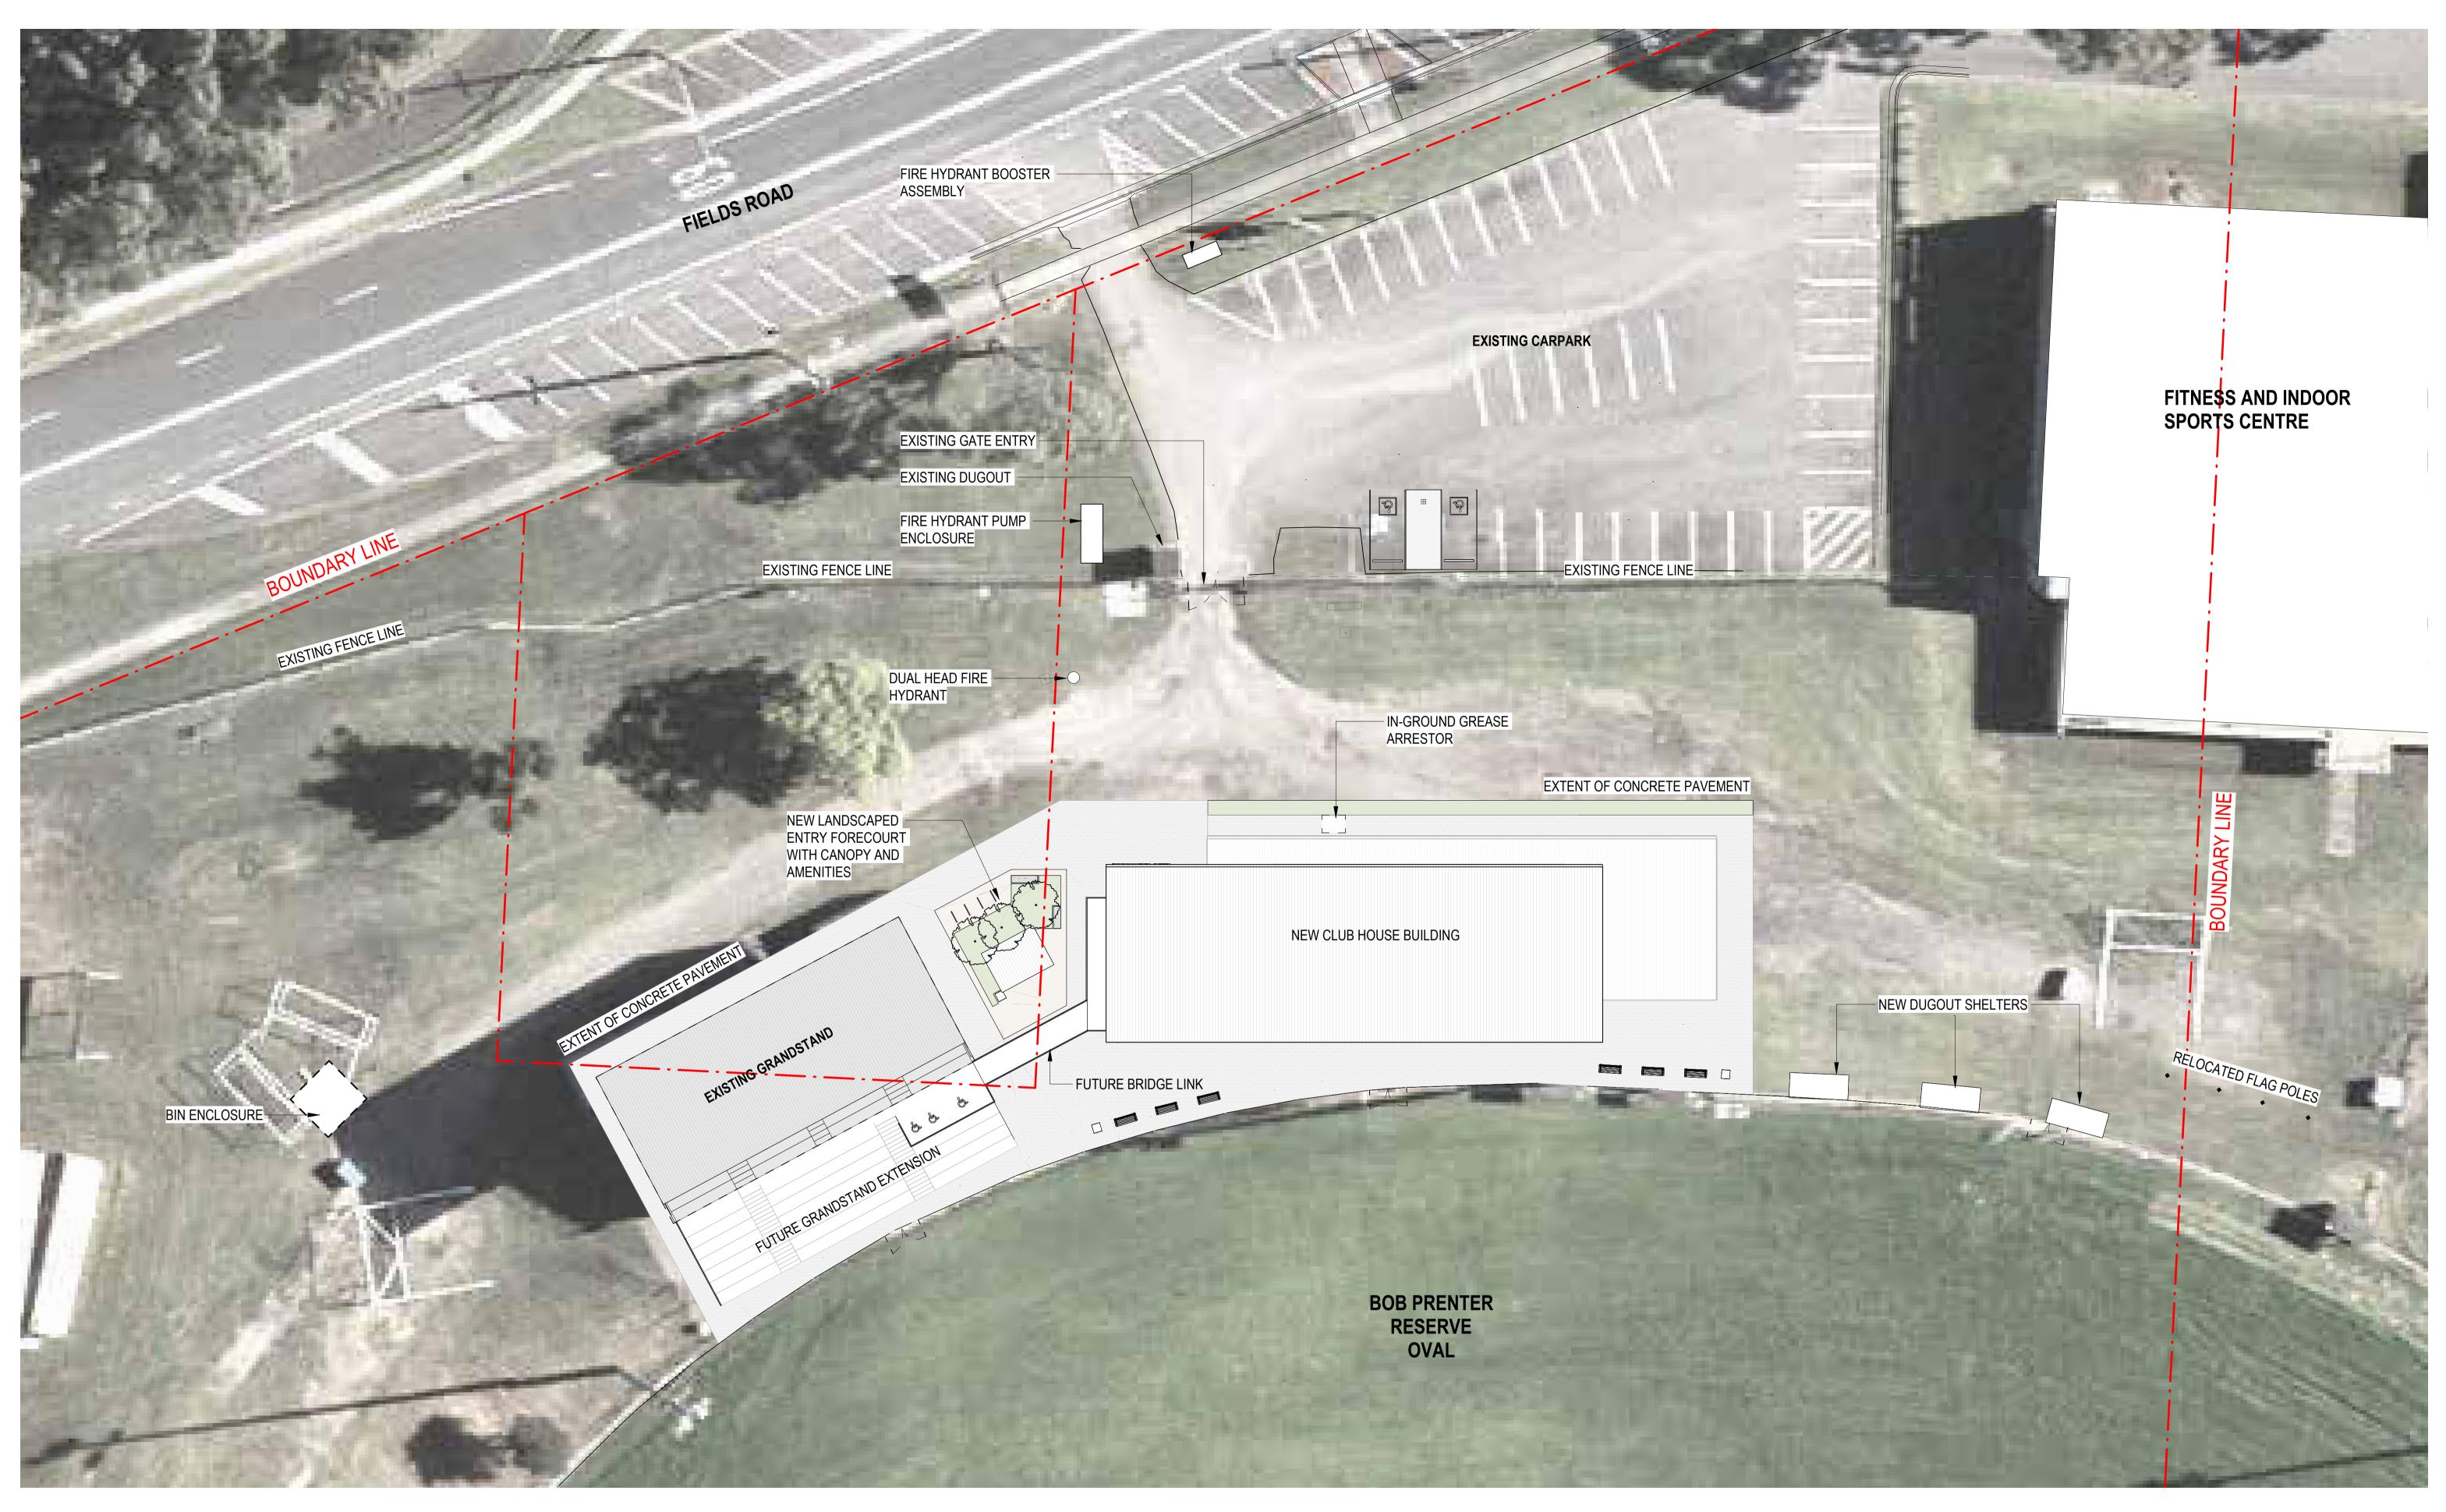

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DRAWN BY KF CHECKED BY MD APPROVED BY MW 0 2 4 6 8 10 **TITLE** SCALE BAR - 1:200

STATUS DETAILED DESIGN **SCALES** 1 : 200 @ A1


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LANDSCAPE SITE PLAN

BPR-DIS-LA-DRG-10005





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SCALE BAR - 1:75 STATUS DETAILED DESIGN SCALES 1 : 75 @ A1

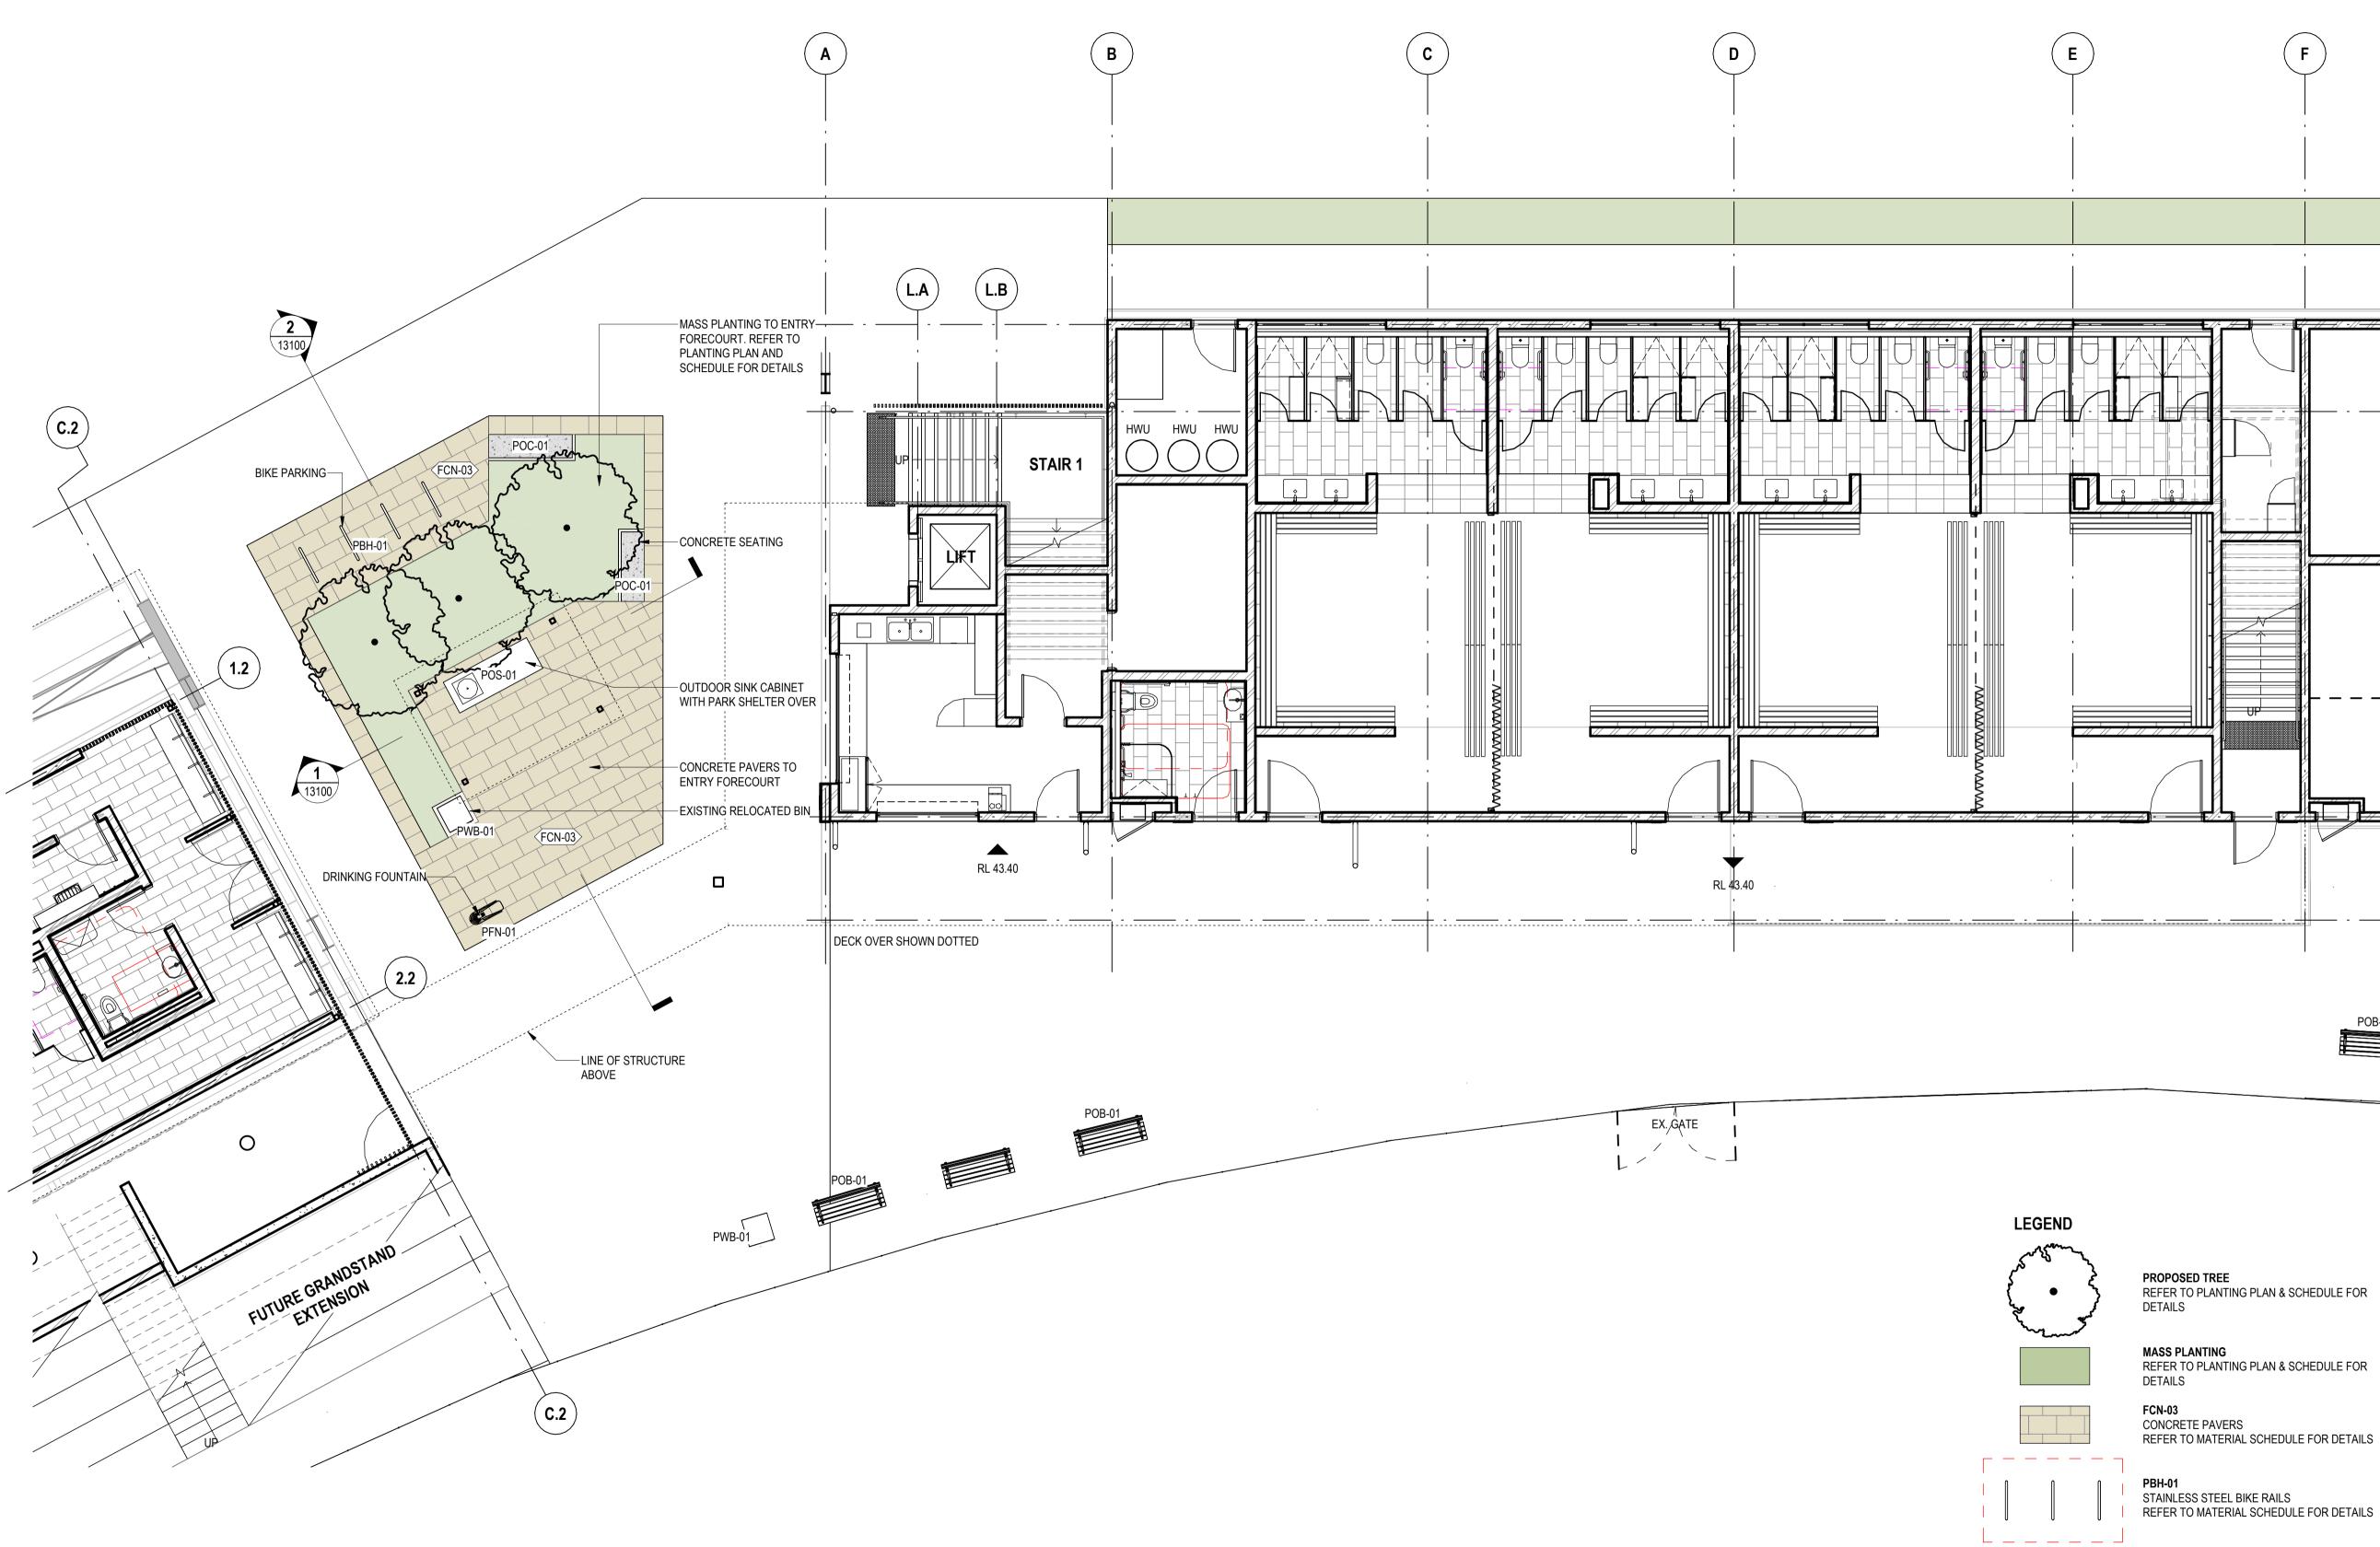0 750 1500 2250 3000 3750 **TITLE GENERAL ARRANGEMENT PLAN -GROUND FLOOR** DRAWING NO. REVISION

DRAWING TO BE PRINTED IN COLOUR

NOT FOR CONSTRUCTION

BPR-DIS-LA-DRG-11200

POB-01

NEW BENCH SEAT



PFN-01 STAINLESS STEEL DRINKING FOUNTAIN REFER TO MATERIAL SCHEDULE FOR DETAILS

REFER TO MATERIAL SCHEDULE FOR DETAILS

Α


POC-01 PRECAST CONCRETE BENCH SEAT REFER TO MATERIAL SCHEDULE FOR DETAILS

**PWB-01 BIN ENCLOSURE** REFER TO MATERIAL SCHEDULE FOR DETAILS

G

3 \_\_\_\_\_ 2 \_\_\_PWB-01

F

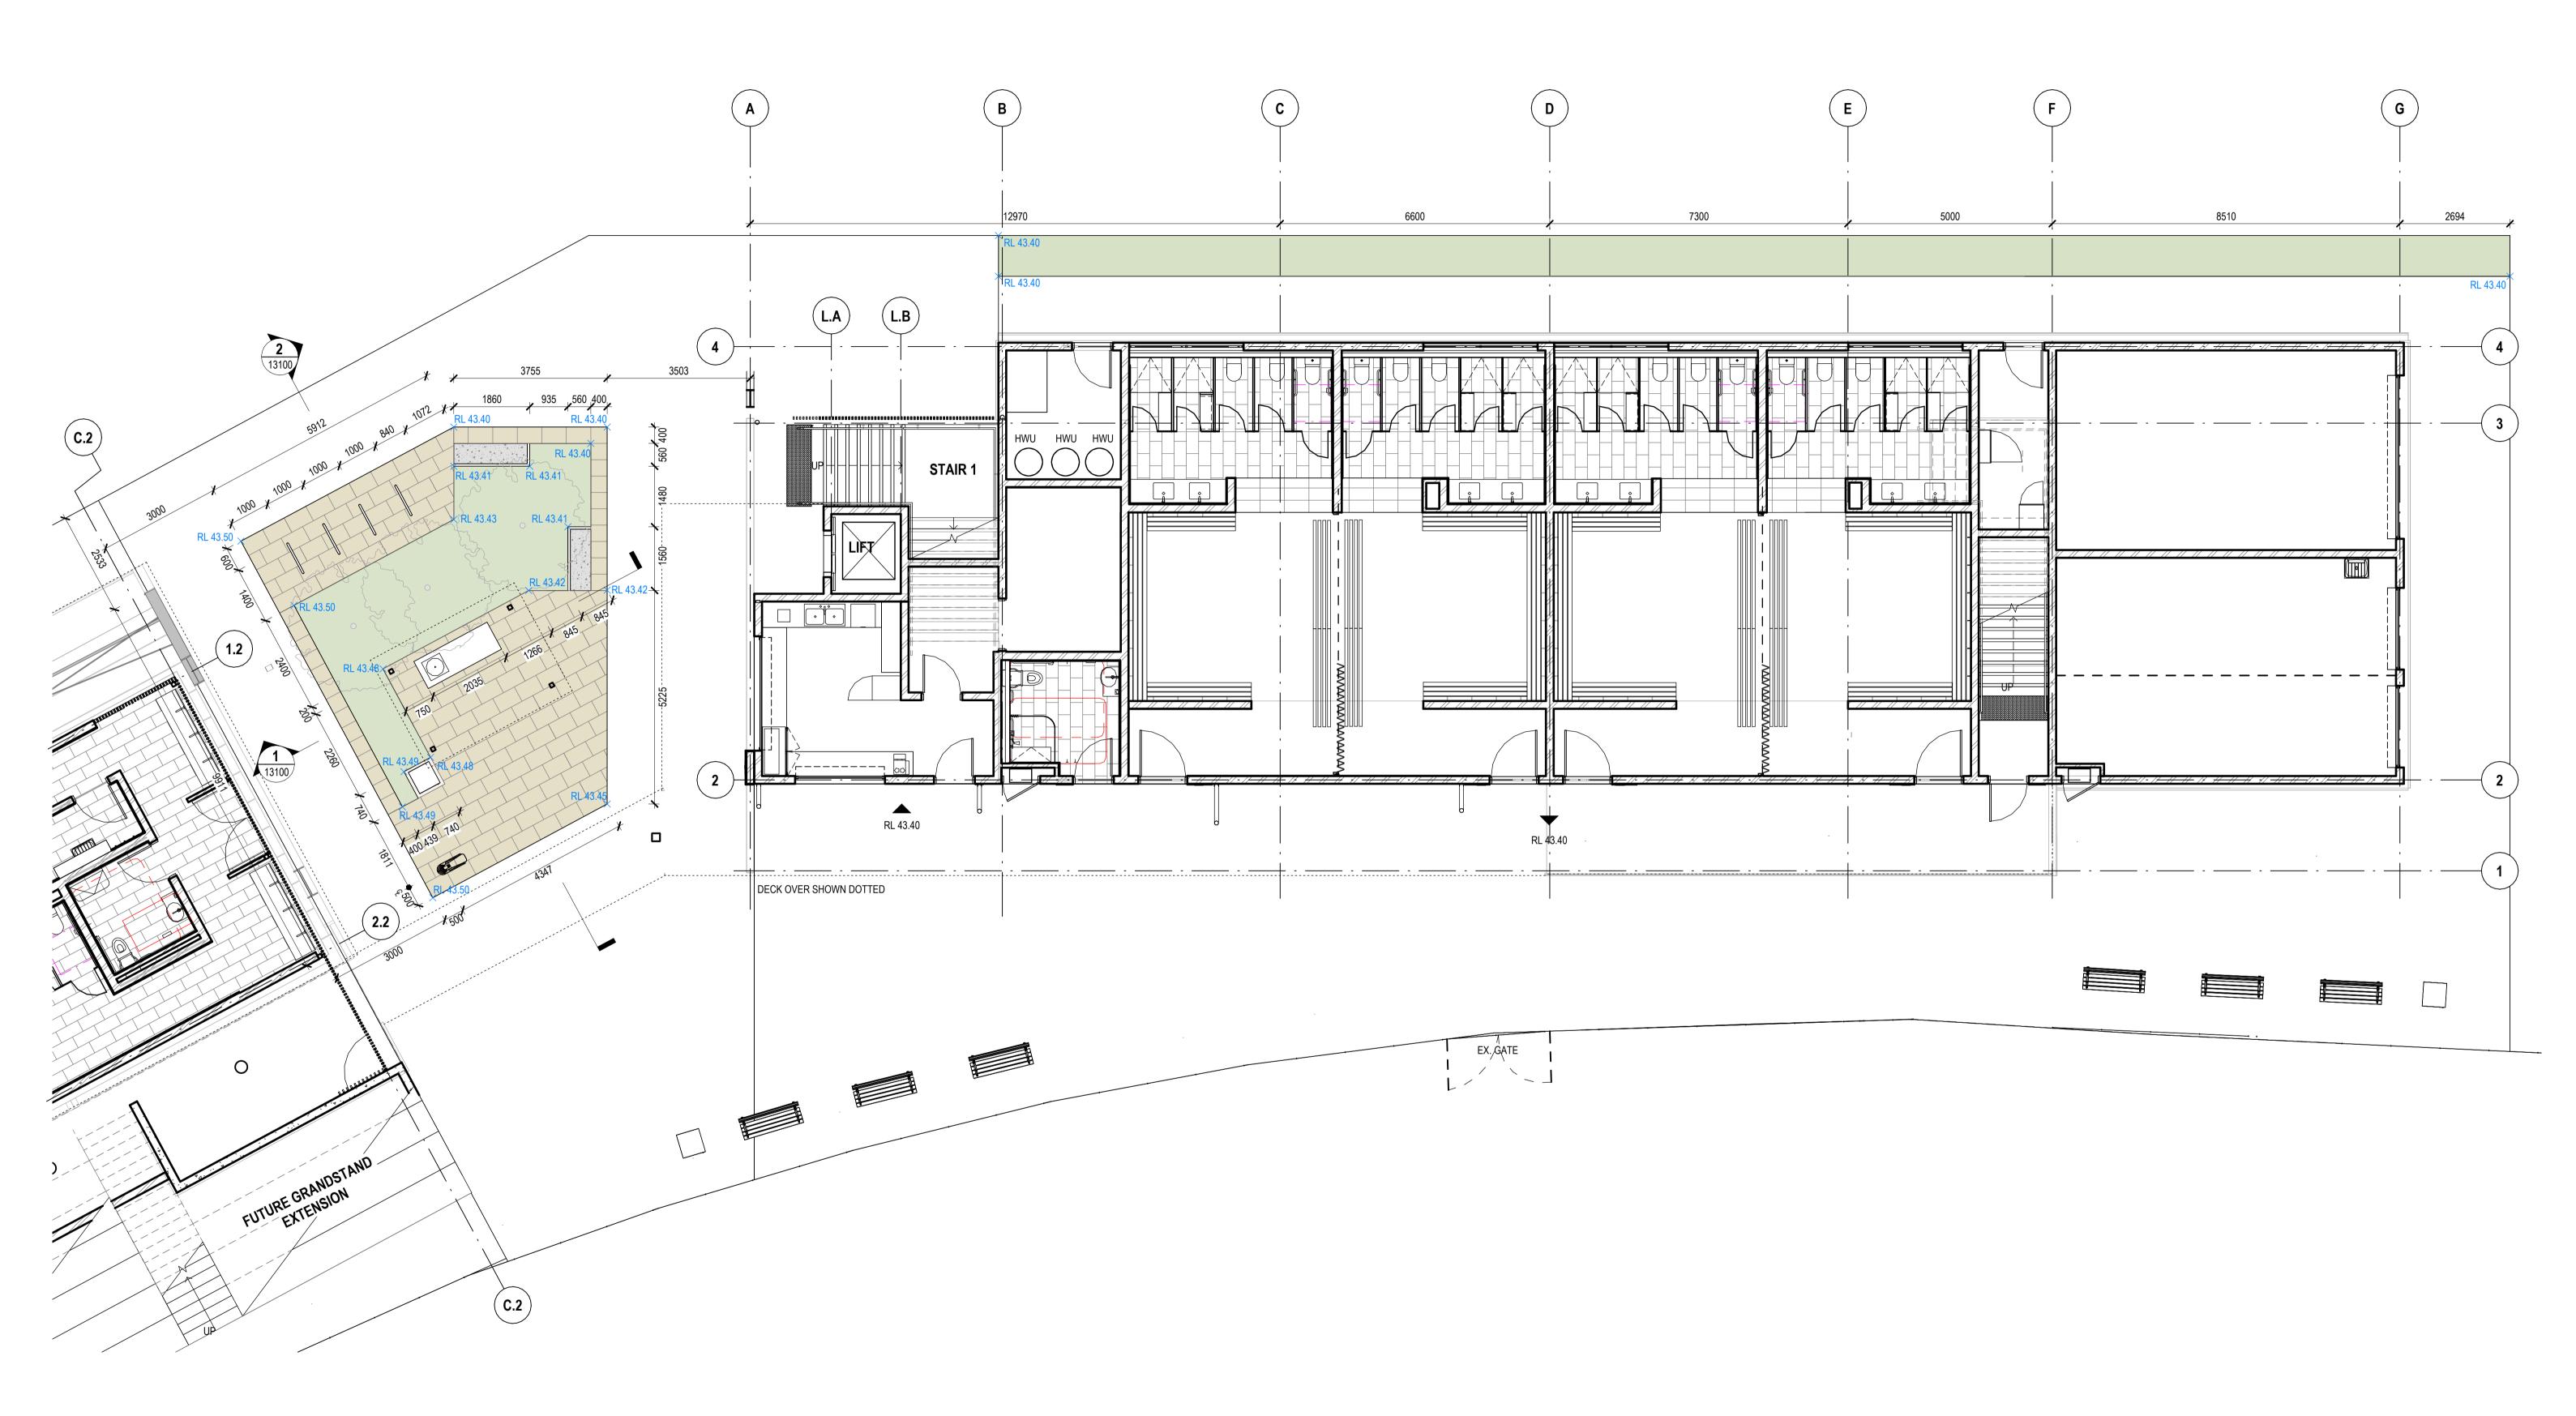

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Cameron Martin 9194 Mary Anne McGirr 10946

Nominated Architects

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lan Armstrong



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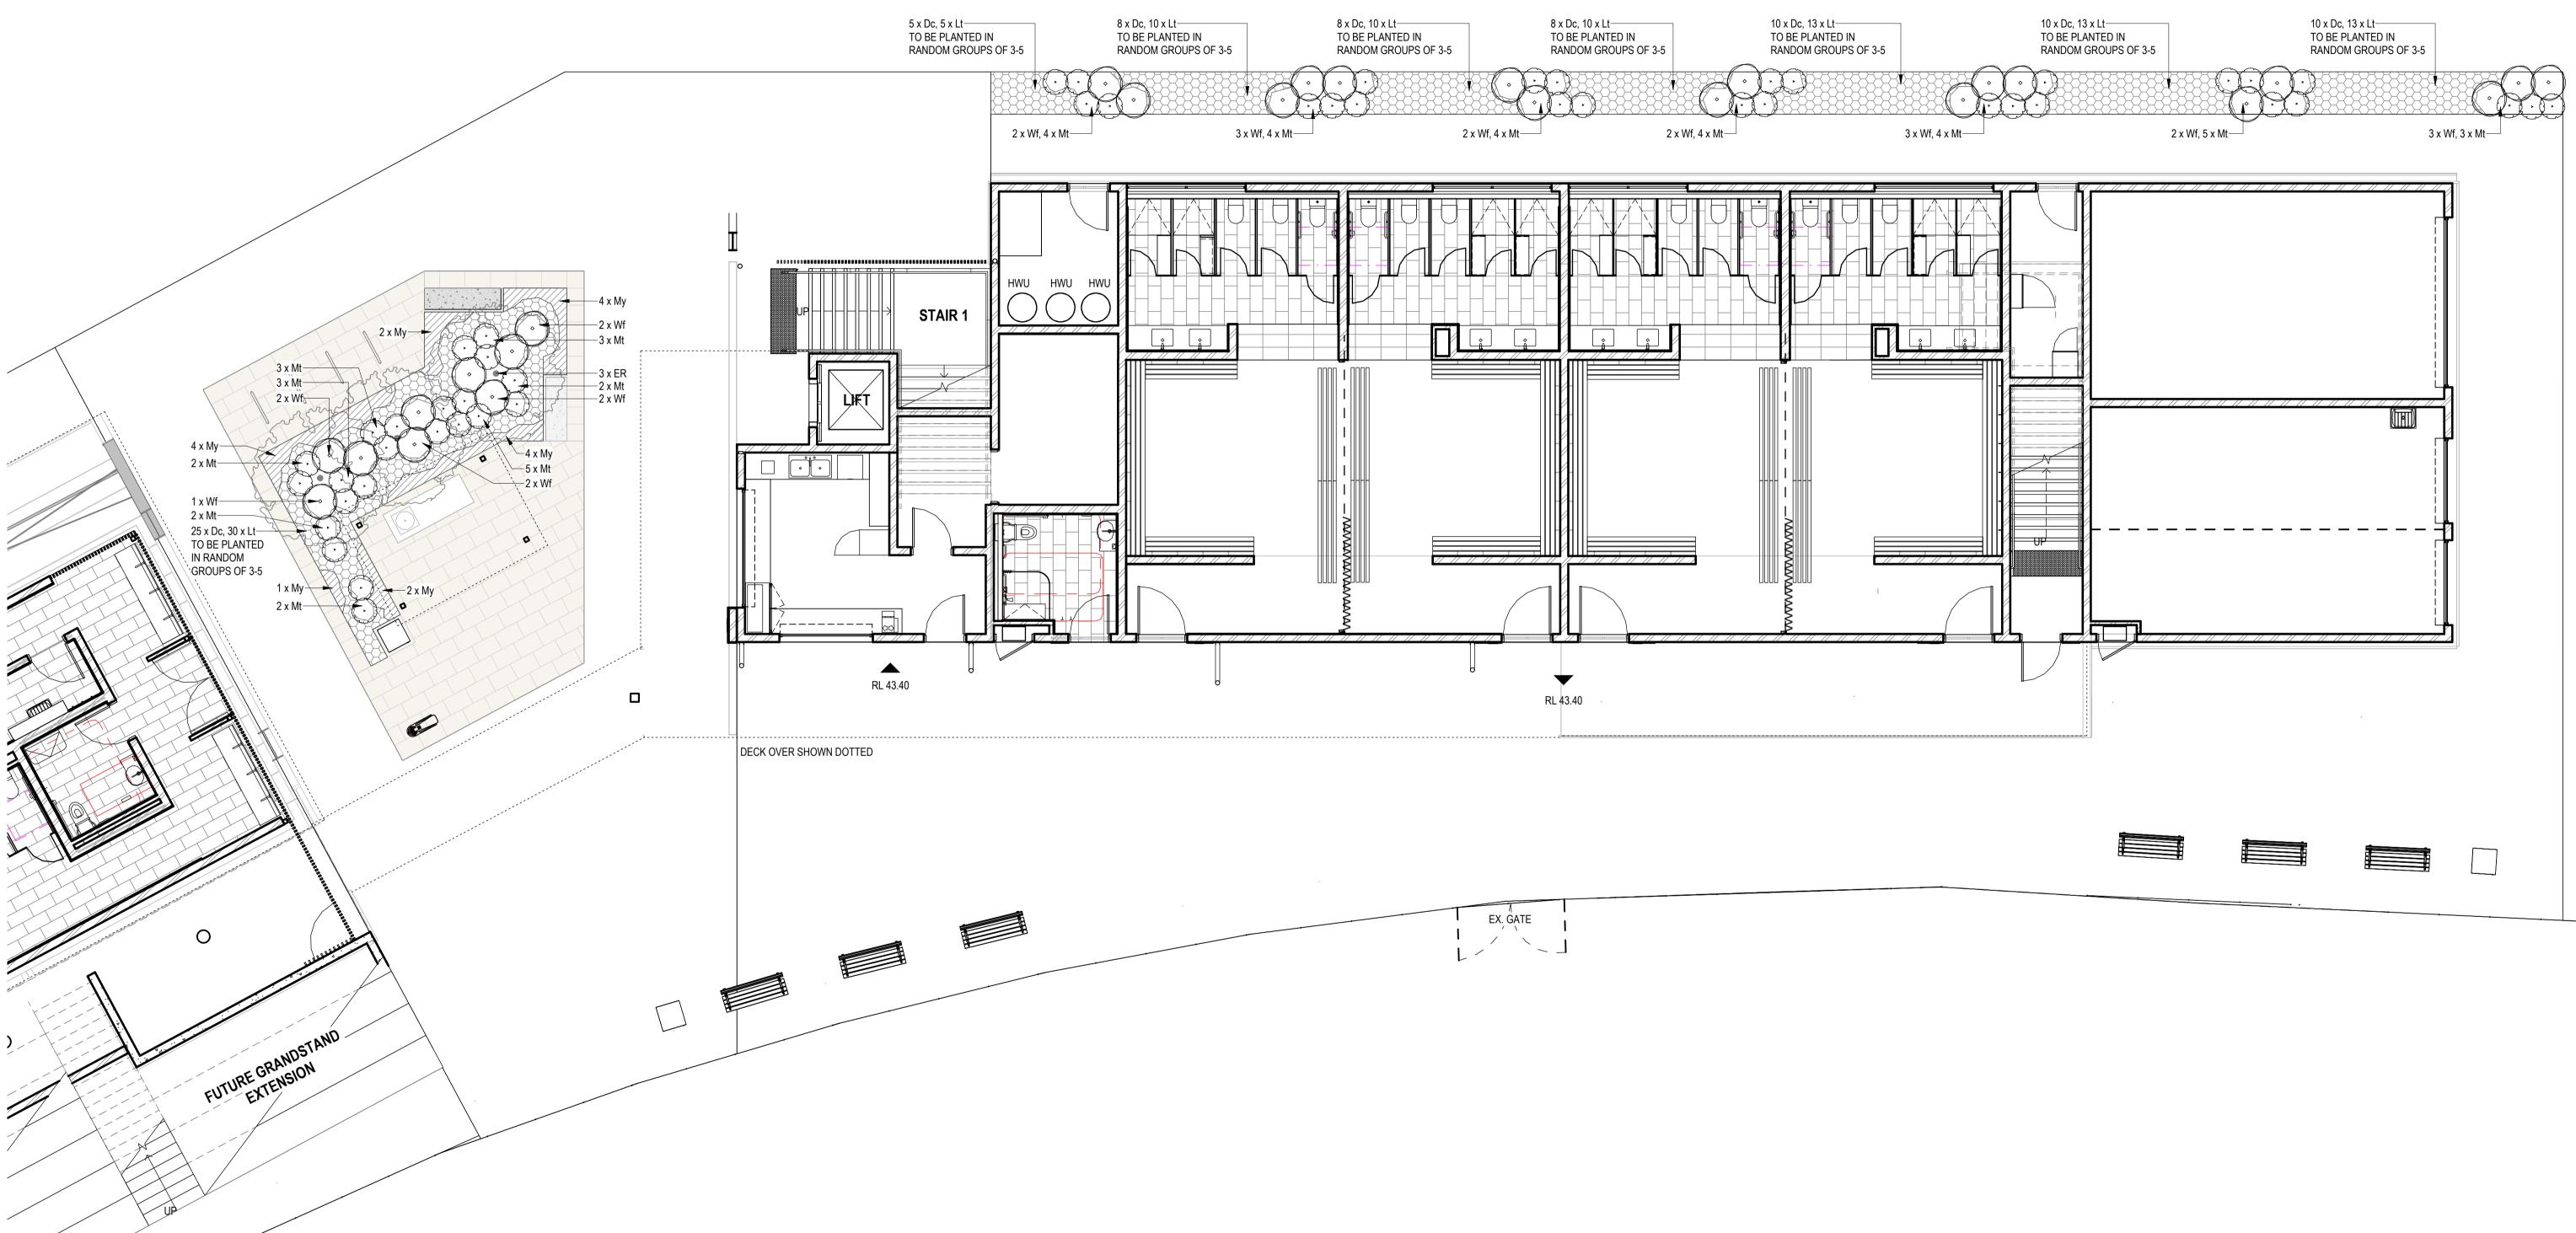
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STATUS DETAILED DESIGN SCALES 1 : 75 @ A1

LANDSCAPE SETOUT PLAN -**GROUND PLAN** DRAWING NO. BPR-DIS-LA-DRG-11300

REVISION Α

CHECKED BY MD







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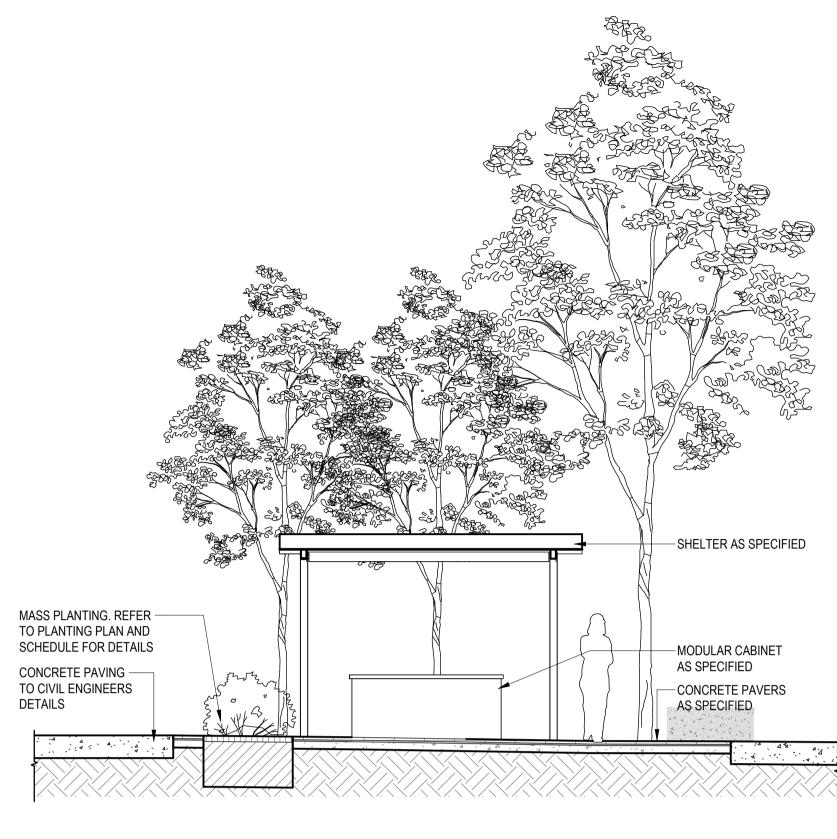
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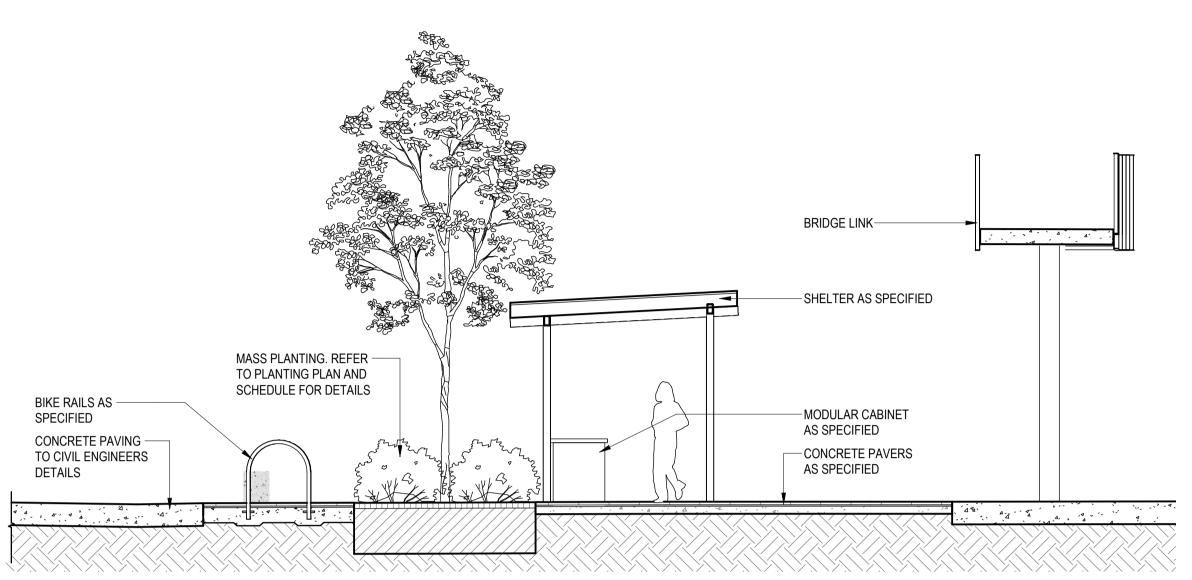
STATUS DETAILED DESIGN

LANDSCAPE PLANTING PLAN -**GROUND PLAN** DRAWING NO. REVISION BPR-DIS-LA-DRG-11400 Α

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SCALES 1 : 75 @ A1





1 ENTRY COURTYARD SECTION 9400 SCALE 1:50





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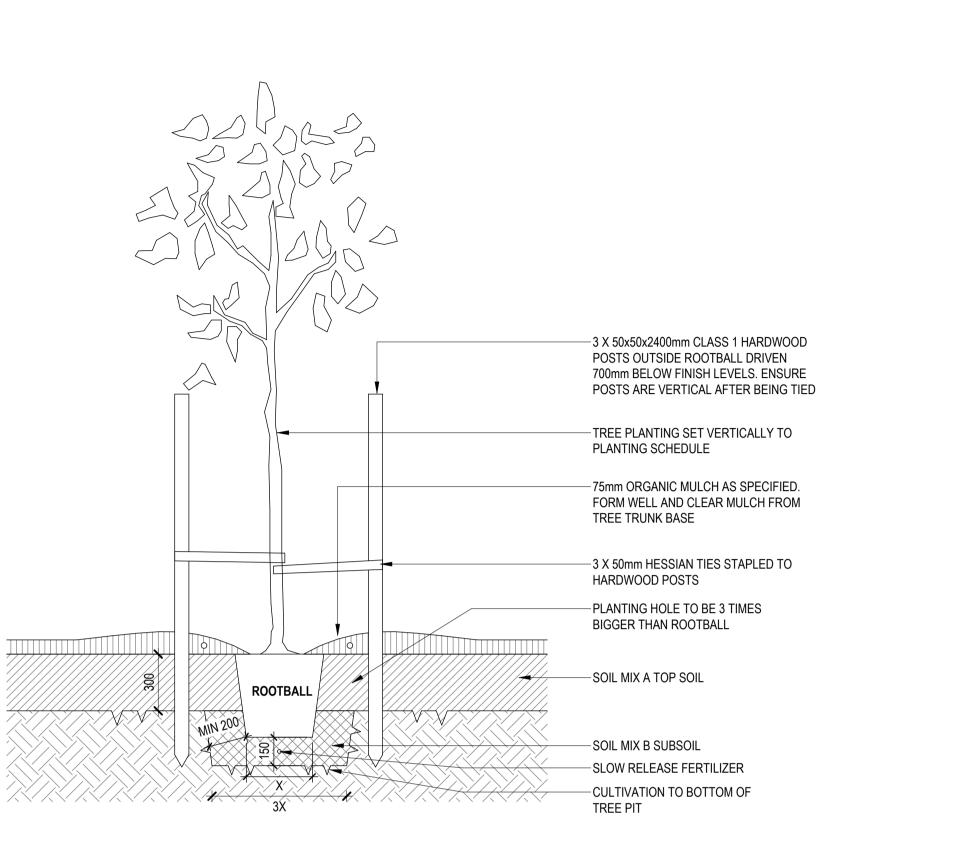
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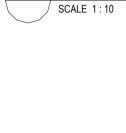
STATUS DETAILED DESIGN SCALES 1 : 50 @ A1

LANDSCAPE SECTIONS & **ELEVATIONS** DRAWING NO. BPR-DIS-LA-DRG-13100





**1** TYPICAL 100L TREE PLANTING DETAILS SCALE 1:20





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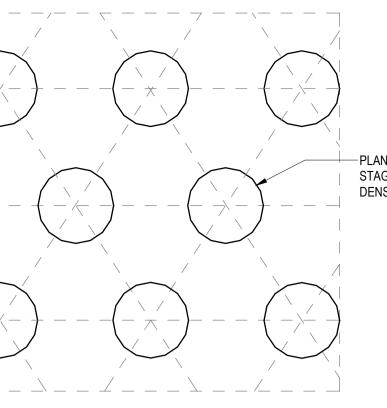
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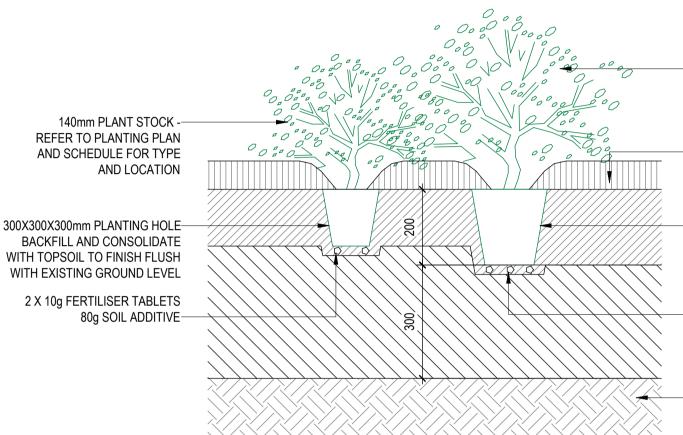
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-PLANTING STOCK PLANTED STAGGERED PATTERN TO DENSITIES ON PLANT SCHEDULE

**2** TYPICAL MASS PLANTING ARRANGEMENT



**3** TYPICAL 140mm & 200mm POT PLANTING DETAIL

-200mm PLANT STOCK -REFER TO PLANTING PLAN AND SCHEDULE FOR TYPE AND LOCATION

100mm DEPTH ORGANIC MULCHDISHED AROUND BASE OF PLANTING

400X400X400mm PLANTING HOLE BACKFILL AND CONSOLIDATE WITH TOPSOIL TO FINISH FLUSH WITH EXISTING GROUND LEVEL

-3 X 10g FERTILISER TABLETS 80g SOIL ADDITIVE



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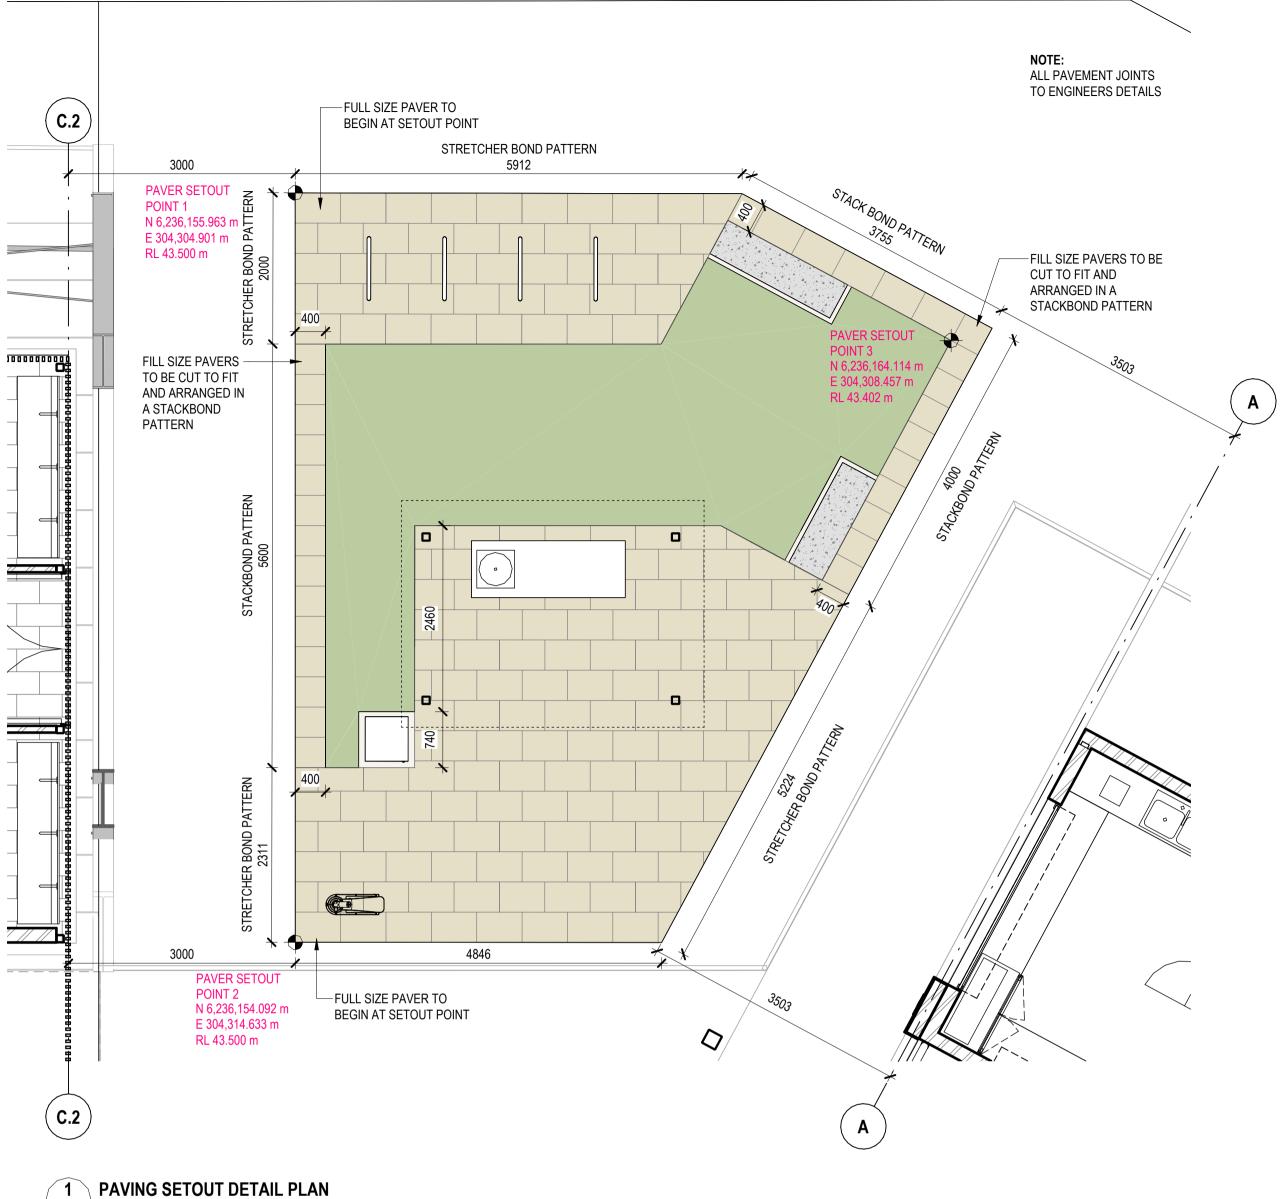
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TITLE LANDSCAPE DETAILS -SOFTWORKS DRAWING NO. BPR-DIS-LA-DRG-18100

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SCALE 1:50

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Nominated Architects

PLOTTED : 9/12/2024 3:32:05 PM



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**2** TYPICAL CONCRETE PAVER DETAIL SCALE 1:10

-40mm CONCRETE UNIT PAVERS AS SPECIFIED -3-5mm GROUTED MORTAR JOINT

|| || || || || ||

X

 $\land \lor \land \lor ,$ 

-20mm BEDDING MORTAR TO CIVIL ENGINEERS DOCUMENTATION

- CONCRETE SLAB TO CIVIL ENGINEER DOCUMENTATION -COMPACTED SUB-GRADE TO CIVIL ENGINEER DOCUMENTATION



#### PROJECT **BOB PRENTER RESERVE AMENITY BUILDING**

PROJECT ADDRESS Fields Rd, Macquarie Fields NSW 2564


#### WORK-IN-PROGRESS


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DRAWN BY KF CHECKED BY MD APPROVED BY MW STATUS DETAILED DESIGN SCALES

TITLE LANDSCAPE DETAILS -HARDWORKS DRAWING NO. BPR-DIS-LA-DRG-18200

REVISION Α



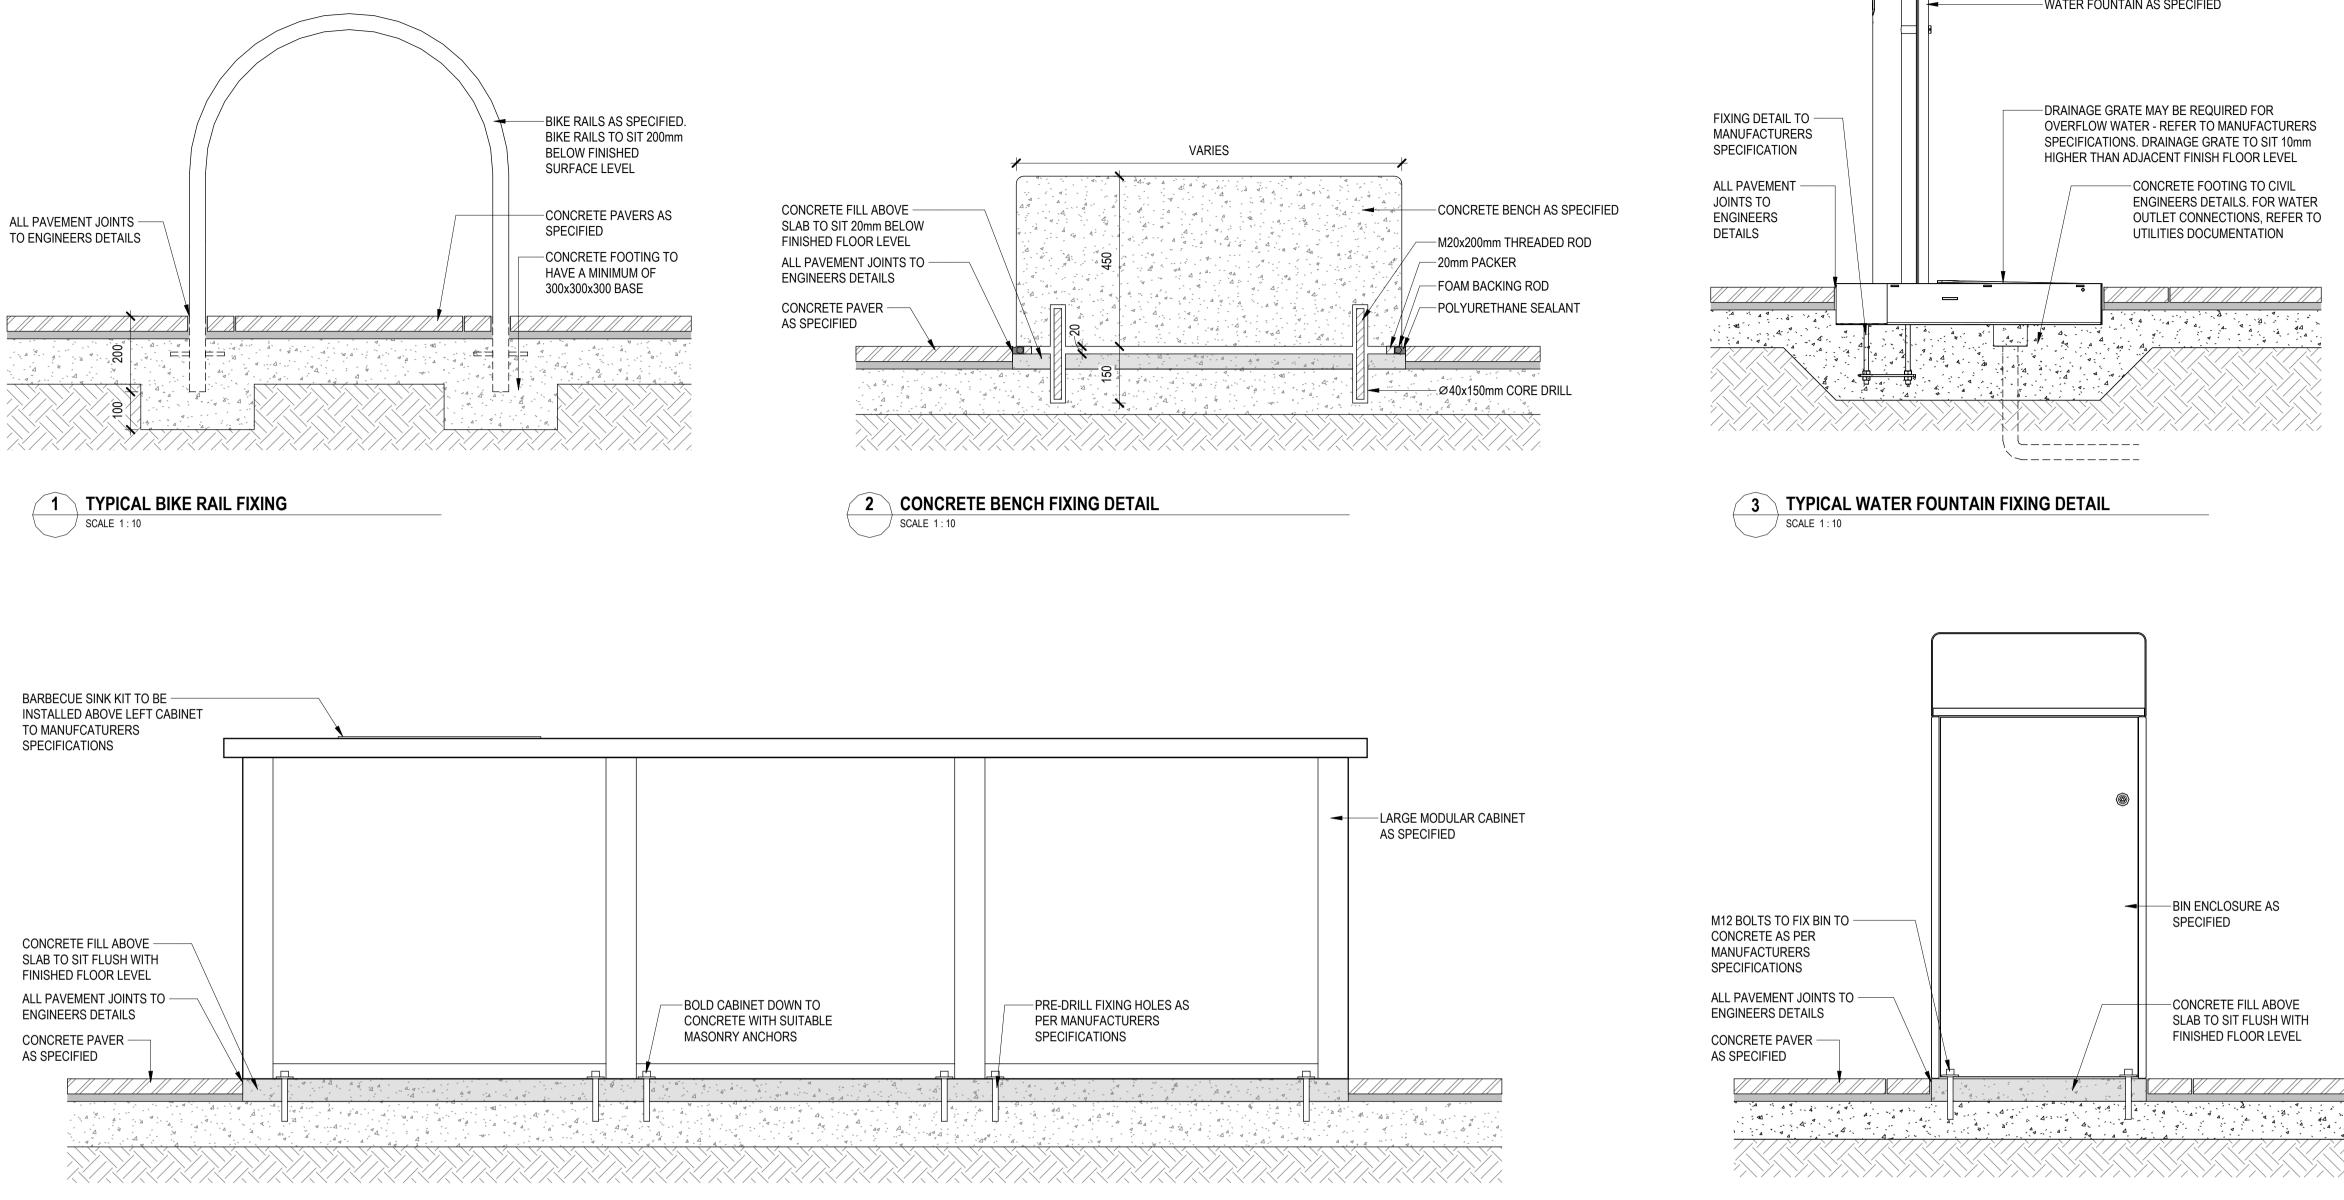

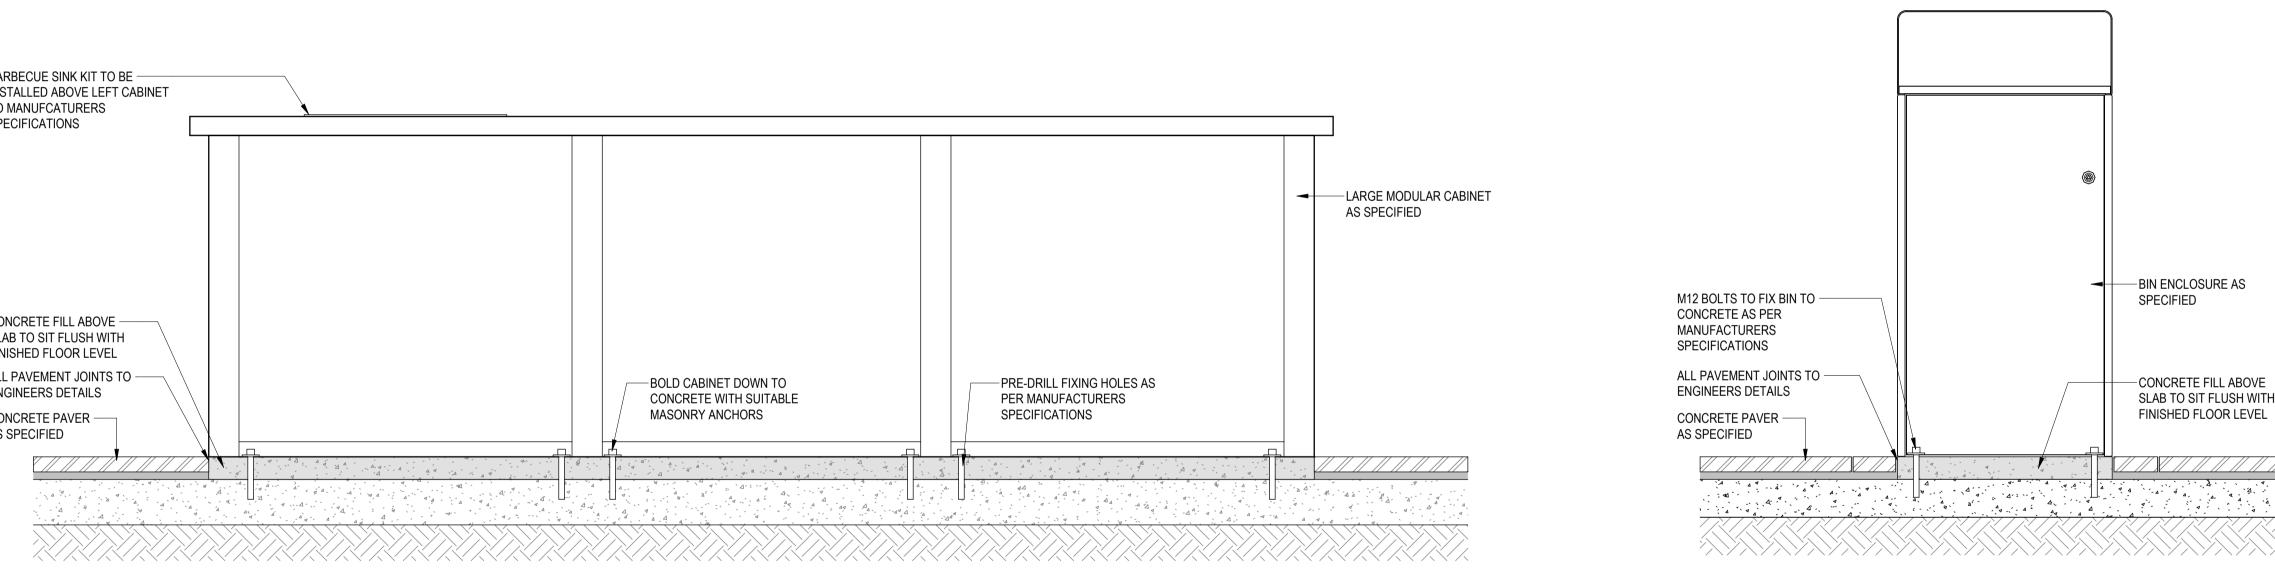**4** MODULAR BBQ BENCH FIXING DETAIL SCALE 1:10






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**5** TYPICAL BIN ENCLOSURE FIXING DETAIL



#### PROJECT **BOB PRENTER RESERVE AMENITY BUILDING**

PROJECT ADDRESS Fields Rd, Macquarie Fields NSW 2564

#### WORK-IN-PROGRESS

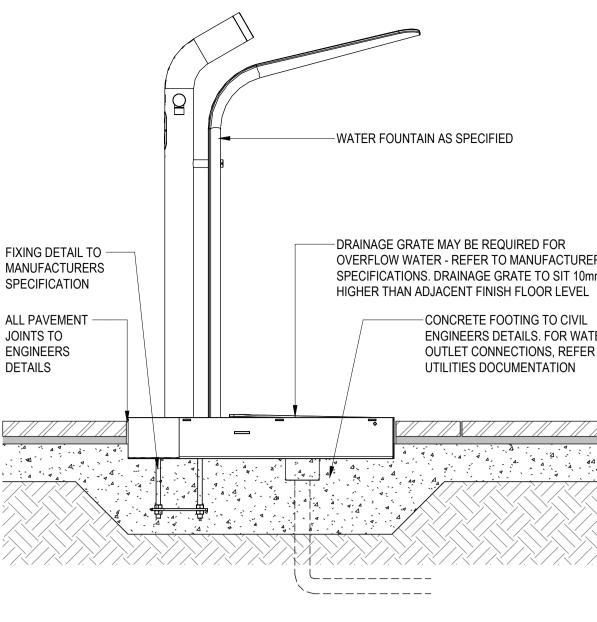A 9.12.24 ISSUED FOR COORDIINATION No DATE REVISIONS

DRAWN BY KF CHECKED BY MD APPROVED BY MW

STATUS DETAILED DESIGN SCALES

TITLE LANDSCAPE DETAILS -**FURNITURES AND FIXTURES** DRAWING NO. REVISION BPR-DIS-LA-DRG-18300

A



		BOB PRENTER RESER	VE PLANTING SCHE	DULE		
CODE	BOTANICAL NAME	COMMON NAME	SPACING (PER M <sup>2</sup> )	POT SIZE	SIZE AT MATURITY (HxW)	QUANTITY
TREES					-	
ER	Elaeocarpus reticulatus	Blueberry Ash	As shown	100L	4-7 x 3m	3
SHRUB	S					
Mt	Melaleuca thymifolia	Honey Myrtle	As shown	200mm	1.2 x 1m	50
Wf	Westringia fruticosa	Coastal Roasemary	As shown	200mm	1.5 x 1m	26
GRASS	ES AND GROUNDCOVERS					
Dc	Dianella caerulea 'Breeze'	Blue Flax Lily	5/m²	140mm	0.8 x 1m	84
Lt	Lomandra 'Tanika'	Spiny Mat Rush	6/m²	140mm	0.5-0.6 x 0.65m	104
My	Myoporum 'Yareena'	Creeping Boobialla	2/m²	140mm	0.1-0.15 x 1-2m	17

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CLIENT

# PROJECT BOB PRENTER RESERVE **AMENITY BUILDING**

PROJECT ADDRESS Fields Rd, Macquarie Fields NSW 2564

#### WORK-IN-PROGRESS

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DRAWING NO. BPR-DIS-LA-DRG-19100



TITLE LANDSCAPE PLANTING SCHEDULE

# **BOB PRENTER RESERVE PROJECT** FIELDS RD, MACQUARIE FIELDS NSW 2564 MECHANICAL SERVICES



REV	DESCRIPTION	ISSUED	VER'D	APP'D	DATE	CLIENT	ARCHITECT
1	DESIGN DEVELOPMENT	RP	SM	SM	16.10.24		
2	ISSUED FOR COORDINATION	RP	SM	SM	06.12.24	CAMPBELLTOWN	Decimples
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							CONSULTING ENGINEERS PTY LTD

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DWG	No.	DRAWING
M00.00		COVER SHEET
M00.01		LEGEND OF S
M20.00		PROPOSED GF
M20.01		PROPOSED LE
M20.02		PROPOSED RC



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**BOB PRENTER RESERVE PROJECT** FIELDS RD, MACQUARIE FIELDS NSW 2564

PROJECT

Canberra 2-6 Shea Street, Phillip A.C.T. 2606 Ph (02) 6285 1822 Email: canberra@northrop.com.au ABN 81 094 433 100




### MECHANICAL SERVICES DRAWING LIST

5 TITLE AND DRAWING SCHEDULE SYMBOLS AND NOTES GROUND FLOOR HVAC LAYOUT EVEL 1 HVAC LAYOUT ROOF HVAC LAYOUT

# PRINT IN COLOUR NOT FOR CONSTRUCTION

DRAWING TITLE

MECHANICAL SERVICES COVER SHEET AND DRAWING SCHEDULE

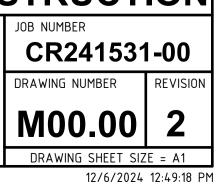

CARPARK EXHAUST (CI
EXHAUST AIR (EA)
HAZARDOUS EXHAUST
KITCHEN EXHAUST (KE)
MAKE UP AIR (MA)
OUTSIDE AIR (OA)
RETURN AIR (RA)
SUPPLY AIR (SA)
SMOKE EXHAUST (SE)
SPILL AIR (SL)
PRESSURISATION AIR (
RELIEF (SR)
TRANSFER DUCT (TD)
TOILET EXHAUST (TE)

### AIR SYSTEM COLOUR KEY

ARPARK EXHAUST (CE) XHAUST AIR (EA) AZARDOUS EXHAUST (HE) ITCHEN EXHAUST (KE) AKE UP AIR (MA) UTSIDE AIR (OA) ETURN AIR (RA) UPPLY AIR (SA) MOKE EXHAUST (SE) PILL AIR (SL) RESSURISATION AIR (PA) ELIEF (SR) RANSFER DUCT (TD)


## PIPING SYSTEM COLOUR KEY

	CONDENSATE DRAIN (COND)	
	REFRIGERANT PIPE (GAS & LIQUID COMBINED) (REF)	
	CONDENSER WATER FLOW (CWF)	
	CONDENSER WATER RETURN (CWR)	
	HEATING HOT WATER FLOW (HHWF)	AxB ( D
	HEATING HOT WATER RETURN (HHWR)	
	CHILLED WATER FLOW (CHWF)	
	CHILLED WATER RETURN (CHWR)	
	NATURAL GAS (NG)	
	STEAM (STM)	
		SD FD FSD SD FD FSD SD FD FSD SD FD FSD VCD MOBD
		$\land$
1	DESCRIPTION ISSUED VER'D APP'D	DATE CLIENT

### AIR GRILLES & GRILLES

 $\boxtimes$ SQUARE LOUVRE FACED DIFFUSER 3-WAY BLOW CEILING DIFFUSER \* SQUARE SWIRL GRILLE  $\square$ RETURN/EXHAUST GRILLE EGGCRATE GRILLE CIRCULAR SWIRL GRILLE  $\bigcirc$ CIRCULAR LOUVRE GRILLE **¦** JET DIFFUSER  $\bigcirc$ CIRCULAR CONE GRILLE SIDE BLOW REGISTER \_\_\_\_ LINEAR DIFFUSER

### **DUCTWORK & ACCESSORIES**

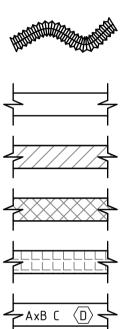

UNINSULATED RECTANGULAR SHEET METAL DUCTWORK DUCT SPIGOT DAMPER & FLEXIBLE DUCTWORK

UNINSULATED RECTANGULAR SHEET METAL DUCTWORK DUCT SPIGOT DAMPER & FLEXIBLE DUCTWORK

DUCTWORK WITH EXTERNAL INSULATION

DUCTWORK WITH INTERNAL LINING

FIRE RATED DUCTWORK



AXB DENOTES SIZE OF DUCT

DENOTES SYSTEM OF DUCT

- D DENOTES THICKNESS OR R-VALUE OF INSULATION/ CIRCULAR DUCTWORK
- $A\emptyset$  C (D)  $A\emptyset$  DENOTES SIZE OF DUCT
  - C DENOTES SYSTEM OF DUCT
  - D DENOTES THICKNESS OR R-VALUE OF INSULATION/

OVAL EXPOSED DUCTWORK A/B DENOTES SIZE OF DUCT

- C DENOTES SYSTEM OF DUCT
- D DENOTES THICKNESS OR R-VALUE OF INSULATION/

90° DUCT BEND WITH TURNING VANES

AIR DUCT RISER

AIR DUCT DROPPER

DUCT MOUNTED RECTANGULAR/ CIRCULAR ACOUSTIC ATTENUATOR

SMOKE DAMPER/FIRE DAMPER/FIRE SMOKE DAMPER

NON RETURN DAMPER/VOLUME CONTROL DAMPER/ OPPOSED BLADE DAMPER/MOTORISED OPPOSED BLADE DAMPER

25mm UNDERCUT TO DOOR (BY BUILDING TRADE) 600x300mm DOOR GRILLE (BY BUILDING TRADE)

TRANSFER GRILLE

FLEX CONNECTION

SPIGOT WITH DAMPER/WITHOUT DAMPER

REV	DESCRIPTION	ISSUED	VER'D	APP'D	DATE	CLIENT	ARCHITECT
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2	ISSUED FOR COORDINATION	RP	SM	SM	06.12.24	CAMPBELLTOWN	DesignIng
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EQUIPI	<u>MENT</u>	<u>ABE</u>	BREVIATIONS	<u>valves</u> a
		AF A/P	AIR FILTER ACCESS PANEL	S
	AXIAL MOUNTED FAN	ATT	ATTENUATOR	•P
г <del>ез</del> т		AHU BO	AIR HANDLING UNIT BLANK OFF	
	DUCTED FAN COIL UNIT WITH FLEXIBLE CONNECTIONS	CC	COOLING COIL	—— <b>⋈</b> —— IS
	_	CWF CWR	CONDENSER WATER FLOW CONDENSER WATER RETURN	<b>k</b> G.
	WALL MOUNTED FAN COIL UNIT	CD	CEILING DIFFUSER	<b>M</b>
ŧ		CE CH	CARPARK EXHAUST CHILLER	<b>b</b> A
		CHWF	CHILLER CHILLER	<b>b</b> ((
	CASSETTE FAN COIL UNIT	CHWP CHWR	CHILLED WATER PUMP CHILLED WATER RETURN	
		CT	COOLING TOWER	— <b>H</b> B
$\mathbf{A}$	HIGH VOLUME LOW SPEED FAN			\$
U		CWP EA	CONDENSER WATER PUMP EXHAUST AIR	A
175	JET FAN	EF	EXHAUST FAN	<b>2</b> .
``		EDH F/A	ELECTRIC DUCT HEATER FROM ABOVE	
	VARIABLE AIR VOLUME BOX	FCU	FAN COIL UNIT	_ [ ] 명 명 명
		FD FDCIE	FIRE DAMPER FIRE DETECTION CONTROL AND INDICATING EQUIPMENT	P
	AIR TO AIR HEAT EXCHANGER	FL	FILTER	—— <u>⊸</u> BI
		FSD FW	FIRE SMOKE DAMPER FLOOR WASTE	<b>i</b> lU
	MIXED FLOW FAN	HE	HEAT EXCHANGER	
		HHWF HHWR	HEATING HOT WATER FLOW HEATING HOT WATER RETURN	
Q	SILENT FLOW FAN	HHWP	HEATING HOT WATER REFORM	
		KE	KITCHEN EXHAUST MOTOR CONTROL CENTRE	PHASING
	AIR-COOLED CONDENSER UNIT HORIZONTAL	MCC M	MOTORISED EQUIPMENT	<u>FIIASINU</u>
	DISCHARGE	MA	MAKEUP AIR	E
		ME MOBD	MEDICAL AIR MOTORISED OPPOSED BLADE DAMPER	— — — — — [
$\mathbf{X}$	ROOF COWL	MSSB	MECHANICAL SERVICES SWITCHBOARD	F
		NC NO	NORMALLY CLOSED NORMALLY OPEN	
$\boxtimes$	SMOKE SPILL HIGH CAPACITY FAN	NRD	NON RETURN DAMPER	
		OA OBD	OUTSIDE AIR OPPOSED BLADE DAMPER	
	KITCHEN EXHAUST HERITAGE SERIES FAN	PAC	PACKAGED UNIT	EQUIPME
		RA RAF	RETURN AIR RETURN AIR FAN	
	ROOF MOUNTED FAN	SA	SUPPLY AIR	
		SAF SD	SUPPLY FAN SMOKE DAMPER	BBB -
	ROOF VENTILATOR	SL	SPILL AIR	
^€		SP T/B	SET POINT TO BELOW	
A strong	ACCESS PANEL	TDR	TIME DELAY RELAY	AA-BB-CC
	WEATHERPROOF LOUVRE	TE TS	TOILET EXHAUST TIME SWITCH	
	MECHANICAL SERVICES SWITCHBOARD	VAV	VARIABLE AIR VOLUME	
Μ	MOTORISED ACTUATOR	VCD WPL	VOLUME CONTROL DAMPER WEATHERPROOF LOUVRE	
T	THERMOSTAT			
Т	TEMPERATURE SENSOR			
	ON-OFF SWITCH			
CC	CONTROL CENTRE			
_	CARBON MONOXIDE SENSOR	MI	<u>SCELLANEOUS</u>	
0				
CO <sub>2</sub>	CARBON DIOXIDE SENSOR		FIRE WALL	
	PANEL FILTER		SMOKE WALL	

### AIR SCHEMATIC

لر ہ) CENTRIFUGAL FAN

AXIAL FAN

ROOF MOUNTED FAN

→ DIRECTION OF AIR FLOW

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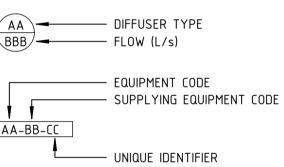
AND FITTINGS

<b>∀</b>	STRAINER
•	PUMP
	FLEXIBLE PIPE CONNECTIONS
⋈—	ISOLATING VALVE
-k	GAUGE COCK
8	SELF BALANCING CONTROL VALVE
2	ANGEL VALVE
₽	COMBINED DE-AERATOR AND DIRT SEPERATOR
*	PRESSURE RELIEF VALVE
¥.	BALANCING VALVE
\$	AUTOMATIC AIR VENT
	2-WAY SOLENOID/MOTORISED CONTROL VALVE
	3-WAY SOLENOID/MOTORISED CONTROL VALVE
<u> 9</u> 9 9 1 1 1 1 1 1 1 1 1 1 1 1 1 1 1 1	FLOW SENSOR/FLOW SWITCH PRESSURE SENSOR/PRESSURE SWITCH
В	BINDER TEST POINT
-#	UNION CONNECTION

## <u>1</u>G

 EXISTING
 DEMOLITION
 RELOCATION

### 1ENT IDENTIFICATION



TUNDISH (BY HYDRAULICS TRADE)

DETAIL/SECTION

Y 🗖

CLOUD & REVISION TRIANGLE

**BOB PRENTER RESERVE PROJECT** FIELDS RD, MACQUARIE FIELDS **NSW 2564** 

PROJECT

HIS DRAWING REMAINS WITH NORTHROP TING ENGINEERS PTY LTD

#### GENERAL NOTES

1. DIMENSIONS ARE IN mm UNLESS NOTED OTHERWISE STATED.

- 2. THESE DRAWINGS SHALL BE READ IN CONJUNCTION WITH THE SPECIFICATION, ARCHITECTURAL DRAWINGS AND OTHER SERVICES DRAWINGS. WORK CALLED FOR IN EITHER ON THE MECHANICAL DRAWINGS OR SPECIFICATION SHALL BE CARRIED OUT.
- 3. ALL WORKS SHALL BE CARRIED OUT IN ACCORDANCE WITH THE BUILDING CODE OF AUSTRALIA.
- 4. SITE MEASURES SHALL BE TAKEN PRIOR TO ANY EQUIPMENT AND MATERIAL BEING ORDERED OR CONSTRUCTED. ANY DIMENSION SHOWN ON THE MECHANICAL DRAWINGS SHALL BE VERIFIED ON SITE.
- 5. UNLESS NOTED OTHERWISE ALL LEVELS ARE IN METERS AND ALL DIMENSIONS ARE IN MILLIMETERS.
- 6. ALL DUCT SIZES ARE CLEAR AIRWAY SIZES.
- 7. THE DRAWINGS SHALL BE READ IN CONJUNCTION WITH THE SPECIFICATION. WORK CALLED FOR EITHER ON THE DRAWINGS OR IN THE SPECIFICATION SHALL BE CARRIED OUT.
- 8. THESE DRAWINGS SHOW THE DESIGN INTENT AND SHALL NOT BE USED AS SHOP DRAWINGS OR FOR CONSTRUCTION.
- 9. WORKING DRAWINGS SHALL BE PREPARED AND SUBMITTED FOR APPROVAL IN ACCORDANCE WITH ACTUAL SITE REQUIREMENTS.
- 10. COORDINATE CEILING ACCESS PANELS ON SITE WITH THE PROJECT MANAGER.
- 11. ACCESS PANELS SHALL BE POSITIONED TO ALLOW PROPER ACCESS TO ALL EQUIPMENT & IN COMPLIANCE WITH SECTIONS.
- 12. COORDINATE ON SITE WITH ALL OTHER TRADES FOR THE ASSOCIATED WORK REQUIRED TO FORM A COMPLETE SYSTEM.
- 13. THE EQUIPMENT SELECTED IS FOR TENDERING PURPOSES ONLY. IT SHALL BE THE CONTRACTORS RESPONSIBILITY TO CHECK EQUIPMENT SELECTIONS PRIOR TO ORDERING.
- 14. BUILDER TO MAKE GOOD ALL PENETRATIONS THROUGH THE BUILDING FABRIC.
- 15. FINAL LOCATION OF DIFFUSERS, GRILLES & ACCESS PANELS TO BE COORDINATED WITH THE LIGHTING AND CEILING LAYOUT.
- 16. ALL DUCT BRANCHES ARE TO BE FITTED WITH OPPOSED BLADE DAMPERS UNLESS OTHERWISE INDICATED.
- 17. ANY PRODUCTS SPECIFIED OR USED ARE TO BE VERIFIED BY THE CONTRACTOR AS BEING SAFE AND APPROPRIATE FOR USE. NORTHROP DOES NOT TAKE ANY RESPONSIBILITY FOR THE PROVISION OF BANNED BUILDING PRODUCTS AS DEFINED BY NSW BUILDING PRODUCTS (SAFETY) ACT 2017.
- 18. PROVIDE STAINLESS STEEL DRIP TRAYS UNDER ALL DUCTED FAN COIL UNITS AND VALVE SETS.
- 19. ALLOW TO PUMP CONDENSATE TO NEAREST DRAIN POINT.
- 20. COORDINATE FINAL LOCATION OF TUNDISHES WITH HYDRAULIC CONTRACTOR.

FLEXIBLE DU	CT SCHEDULE
DIAMETER (mm)	MAXIMUM (L/s)
Ø350	450
Ø300	250
Ø250	150
Ø200	100
Ø150	50

## PRINT IN COLOUR **NOT FOR CONSTRUCTION**

JOB NUMBER

DRAWING NUMBER


M00.01

DRAWING TITLE **MECHANICAL SERVICES** LEGEND OF SYMBOLS AND NOTES


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REVISION


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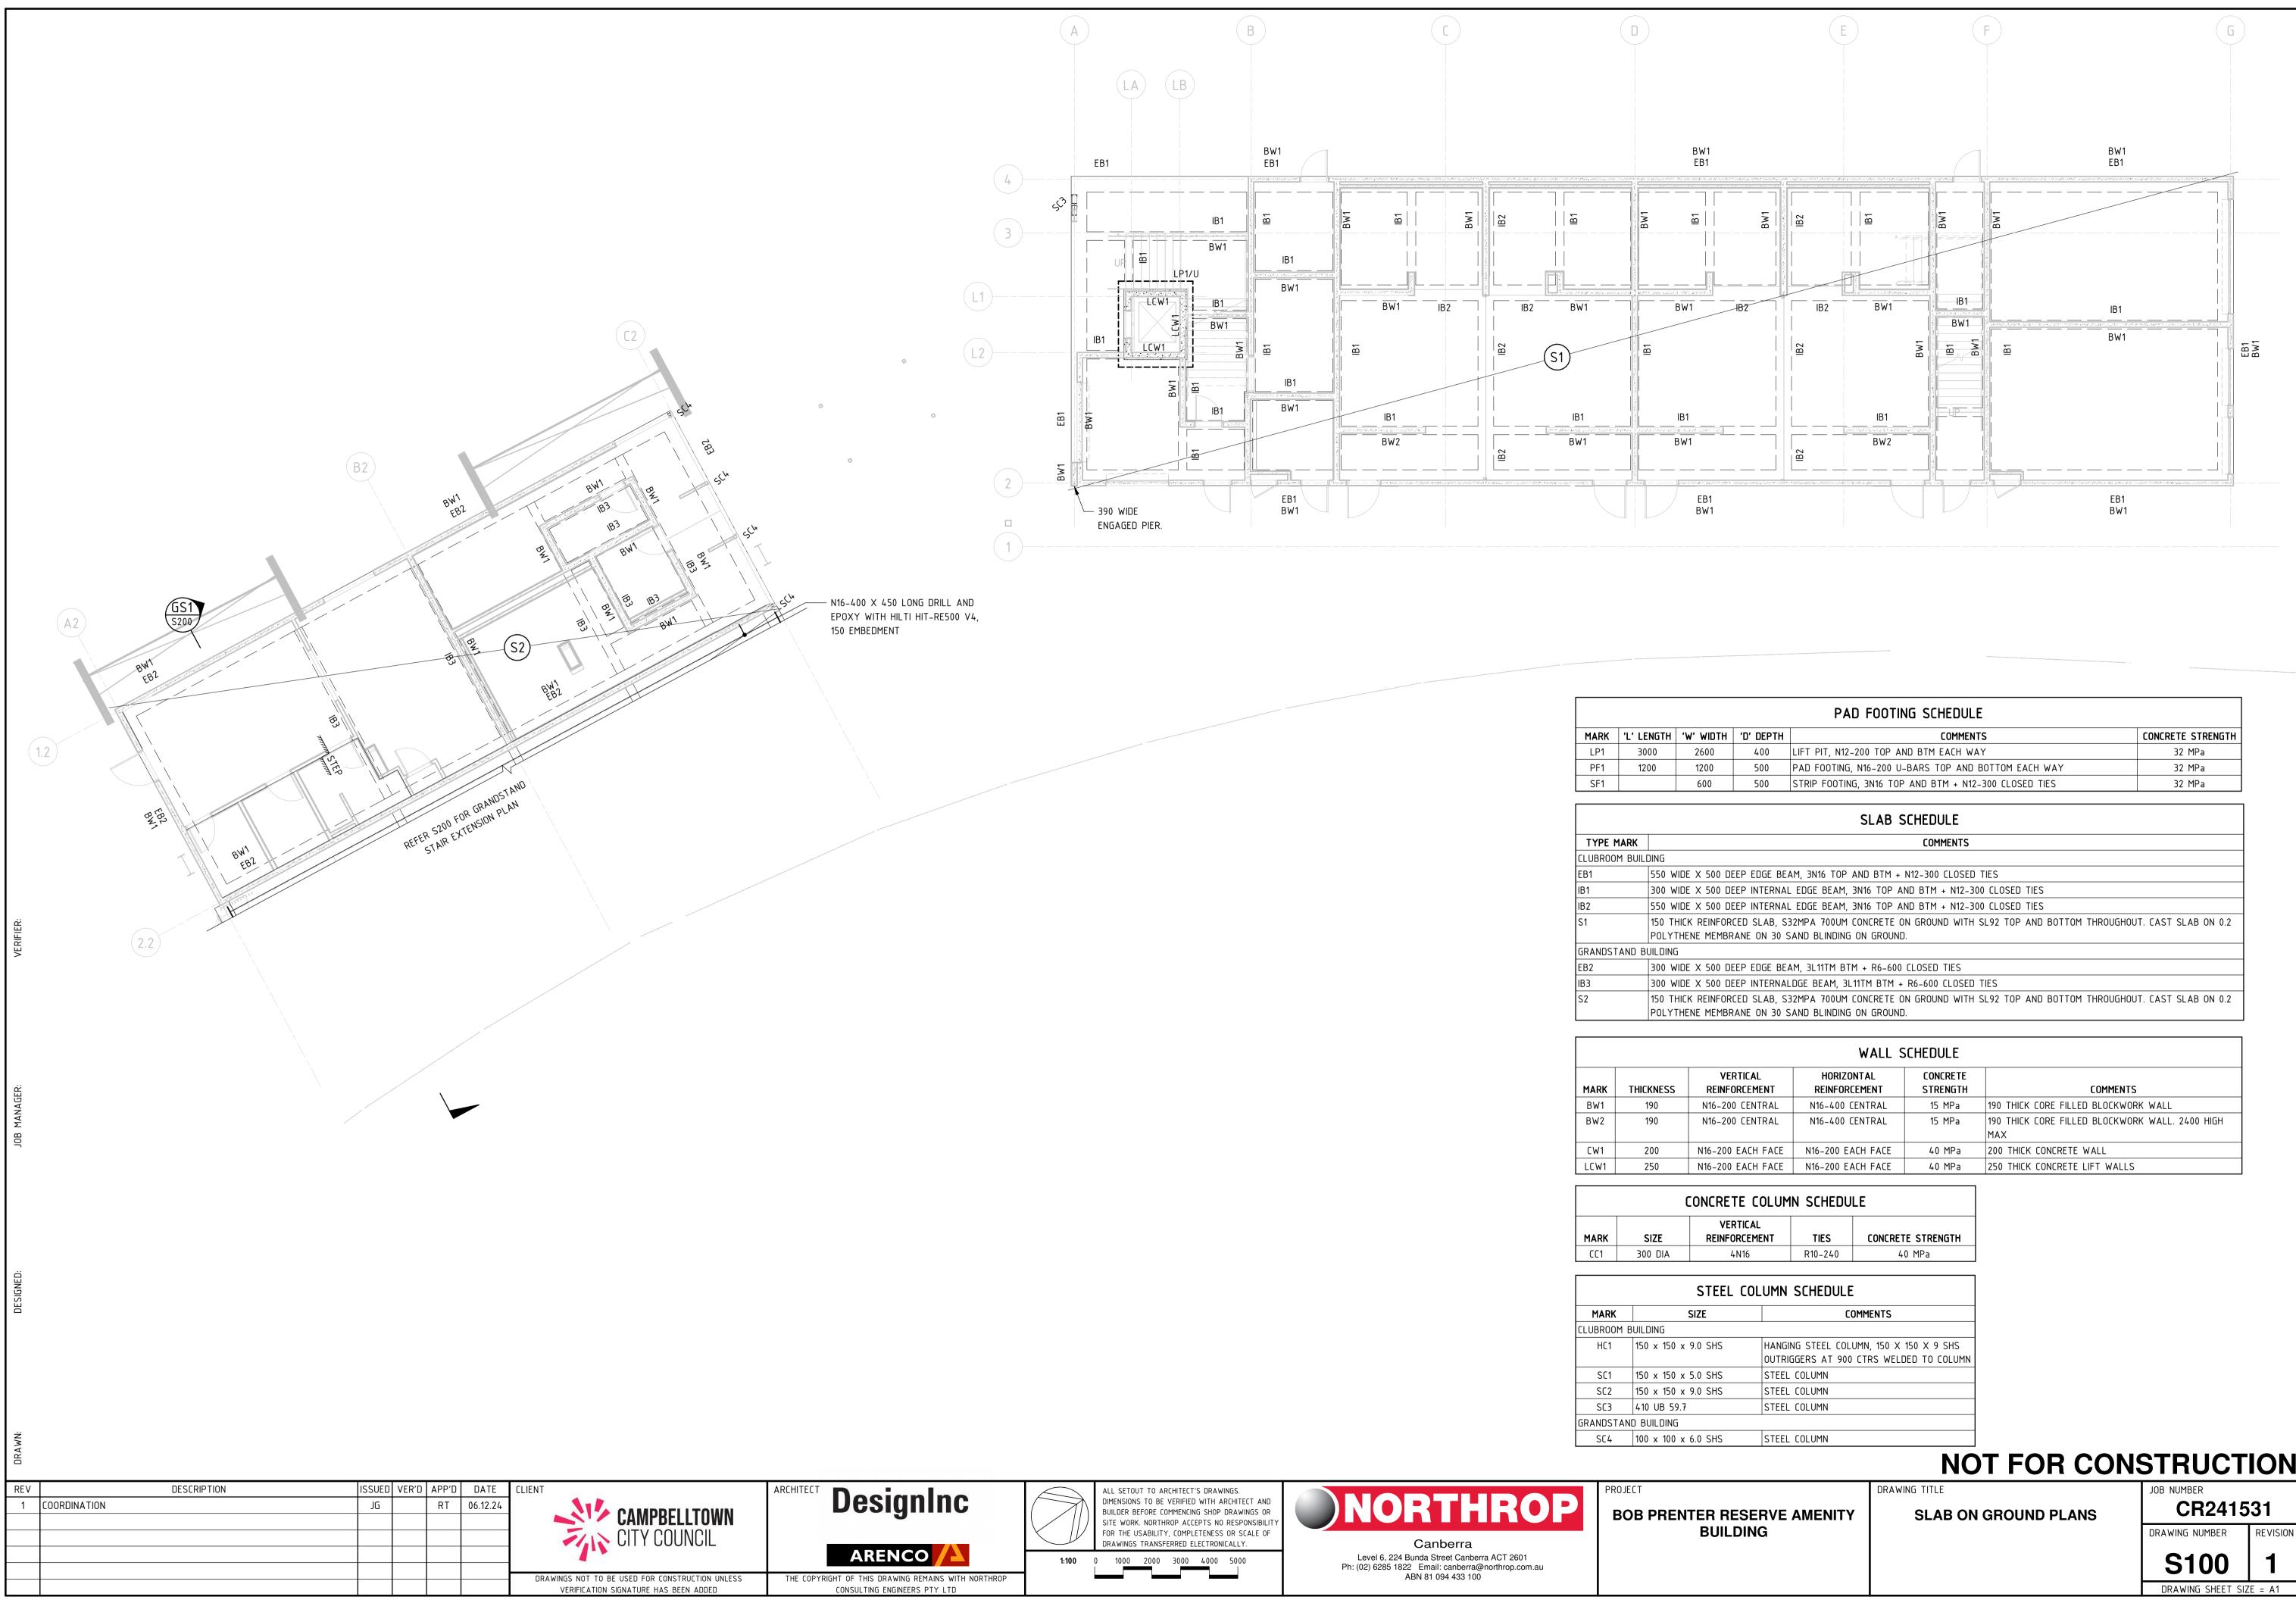
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	1:100		2-6 Shea Street, Phillip A.C.T. 2606
THT OF THIS DRAWING REMAINS WITH NORTHROP	1		Ph (02) 6285 1822 Email: canberra@northrop.co ABN 81 094 433 100

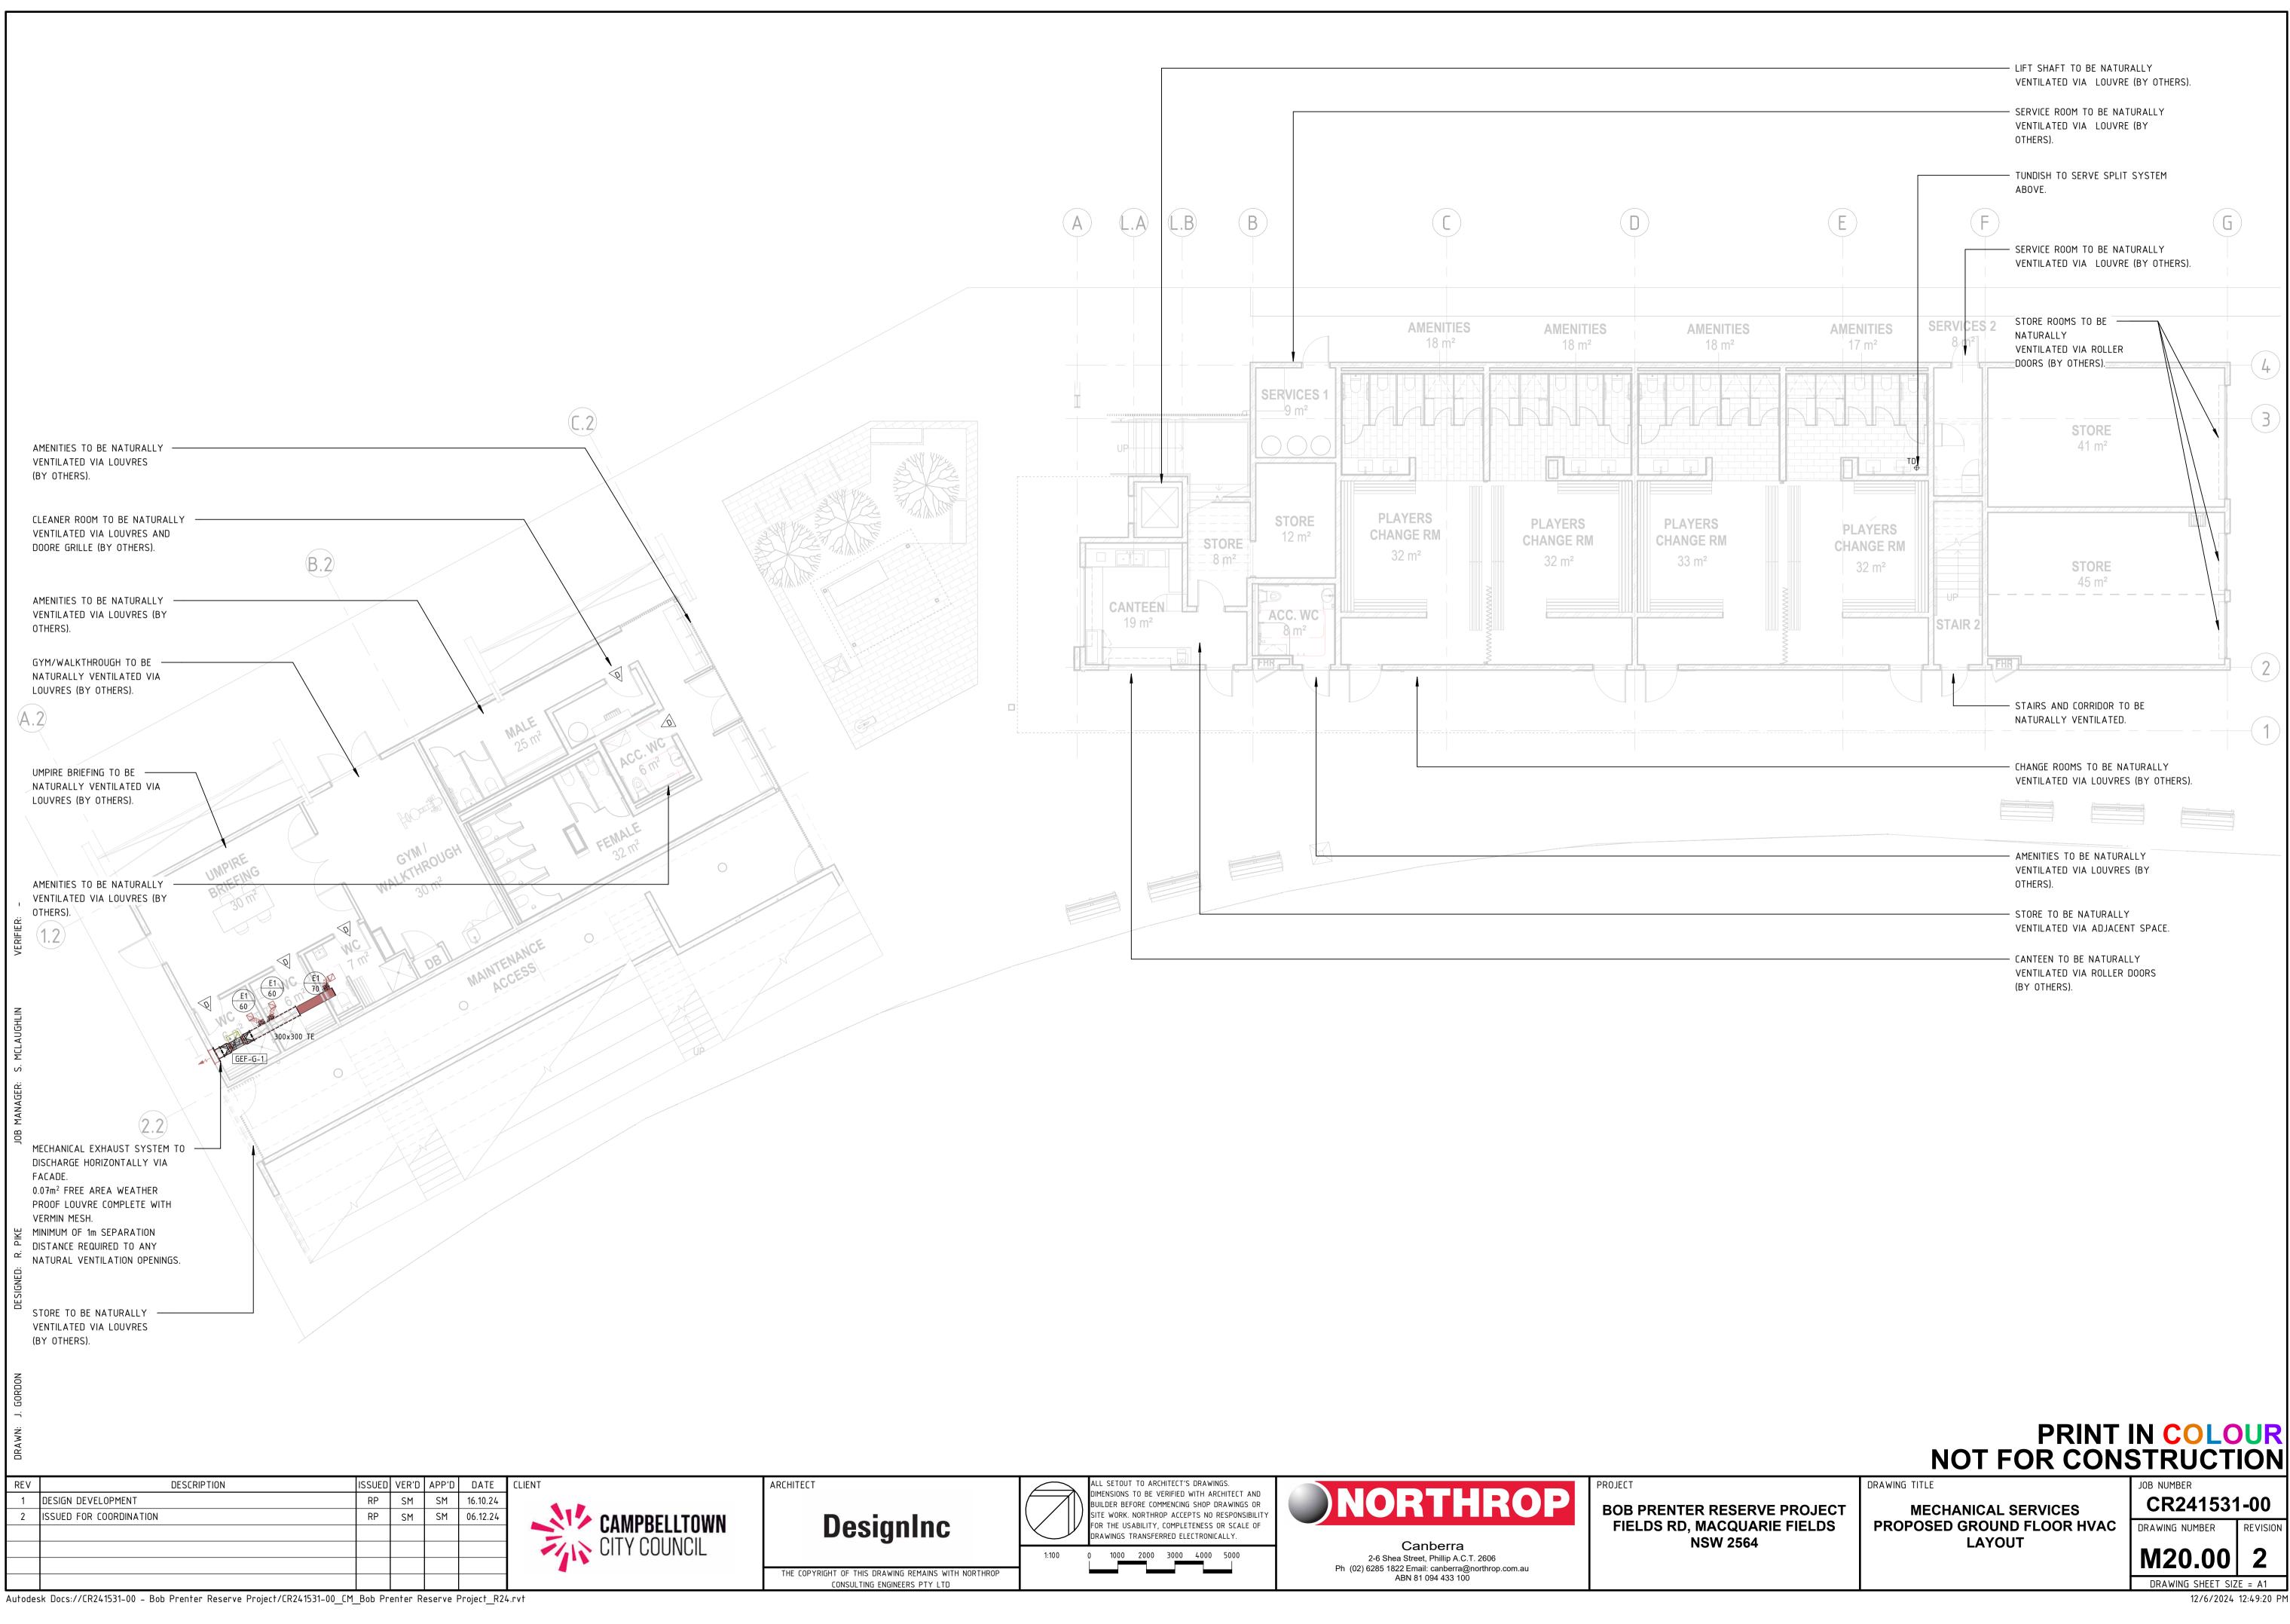

				PAD FOOTING SCHEDULE				
MARK 'L' LENGTH 'W' WIDTH 'D' [		'D' DEPTH	COMMENTS	CONCRETE STRENGTH				
LP1	3000	2600	400	LIFT PIT, N12-200 TOP AND BTM EACH WAY	32 MPa			
PF1	1200	1200	500	PAD FOOTING, N16-200 U-BARS TOP AND BOTTOM EACH WAY	32 MPa			
SF1		600	500	STRIP FOOTING, 3N16 TOP AND BTM + N12-300 CLOSED TIES	32 MPa			
				SLAB SCHEDULE				
TYPE								
	M BUILDING							
EB1	550 N	WIDE X 500 DI	EP EDGE BE	AM, 3N16 TOP AND BTM + N12-300 CLOSED TIES				
IB1	300 \	WIDE X 500 DI	EP INTERNA	L EDGE BEAM, 3N16 TOP AND BTM + N12-300 CLOSED TIES				
IB2	550 \	WIDE X 500 DI	EP INTERNA	L EDGE BEAM, 3N16 TOP AND BTM + N12-300 CLOSED TIES				
51 150 THICK REINFORCED SLAB, S32MPA 700UM CONCRETE ON GROUND WITH SL92 TOP AND BOTTOM THROUGHOUT. CAST SLAB ON 0.2 POLYTHENE MEMBRANE ON 30 SAND BLINDING ON GROUND.								
GRANDS	TAND BUILDIN	G						
EB2	300 \	WIDE X 500 DI	EP EDGE BE	AM, 3L11TM BTM + R6-600 CLOSED TIES				
IB3	300 \	WIDE X 500 DI	EP INTERNA	LDGE BEAM, 3L11TM BTM + R6–600 CLOSED TIES				

PAD FOOTING SCHEDULE						
MARK 'L' LENGTH 'W' WIDTH 'D		'D' DEPTH	COMMENTS	CONCRETE STRENGTH		
LP1	300	00	2600	400	LIFT PIT, N12-200 TOP AND BTM EACH WAY	32 MPa
PF1	120	00	1200	500	PAD FOOTING, N16-200 U-BARS TOP AND BOTTOM EACH WAY	32 MPa
SF1			600	500	STRIP FOOTING, 3N16 TOP AND BTM + N12-300 CLOSED TIES	32 MPa
SLAB SCHEDULE						
TYPE MARK COMMENTS						
CLUBROO	M BUILD	ING				
EB1		550 W	IDE X 500 DE	EEP EDGE BE	AM, 3N16 TOP AND BTM + N12-300 CLOSED TIES	
IB1		300 W	IDE X 500 DE	EEP INTERNAL	_ EDGE BEAM, 3N16 TOP AND BTM + N12-300 CLOSED TIES	
IB2		550 W	IDE X 500 DE	EEP INTERNAL	_ EDGE BEAM, 3N16 TOP AND BTM + N12-300 CLOSED TIES	
S1 150 THICK REINFORCED SLAB, S32MPA 700UM CONCRETE ON GROUND WITH SL92 TOP AND BOTTOM THROUGHOUT. CAST SLAB ON 0.2 POLYTHENE MEMBRANE ON 30 SAND BLINDING ON GROUND.						
GRANDST	TAND BU	JILDING	İ			
EB2		300 W	IDE X 500 DE	EP EDGE BE	AM, 3L11TM BTM + R6-600 CLOSED TIES	
IB3		300 W	IDE X 500 DE	EP INTERNAL	LDGE BEAM, 3L11TM BTM + R6-600 CLOSED TIES	
S2		150 THICK REINFORCED SLAB, S32MPA 700UM CONCRETE ON GROUND WITH SL92 TOP AND BOTTOM THROUGHOUT. CAST SLAB ON 0.2 POLYTHENE MEMBRANE ON 30 SAND BLINDING ON GROUND.				

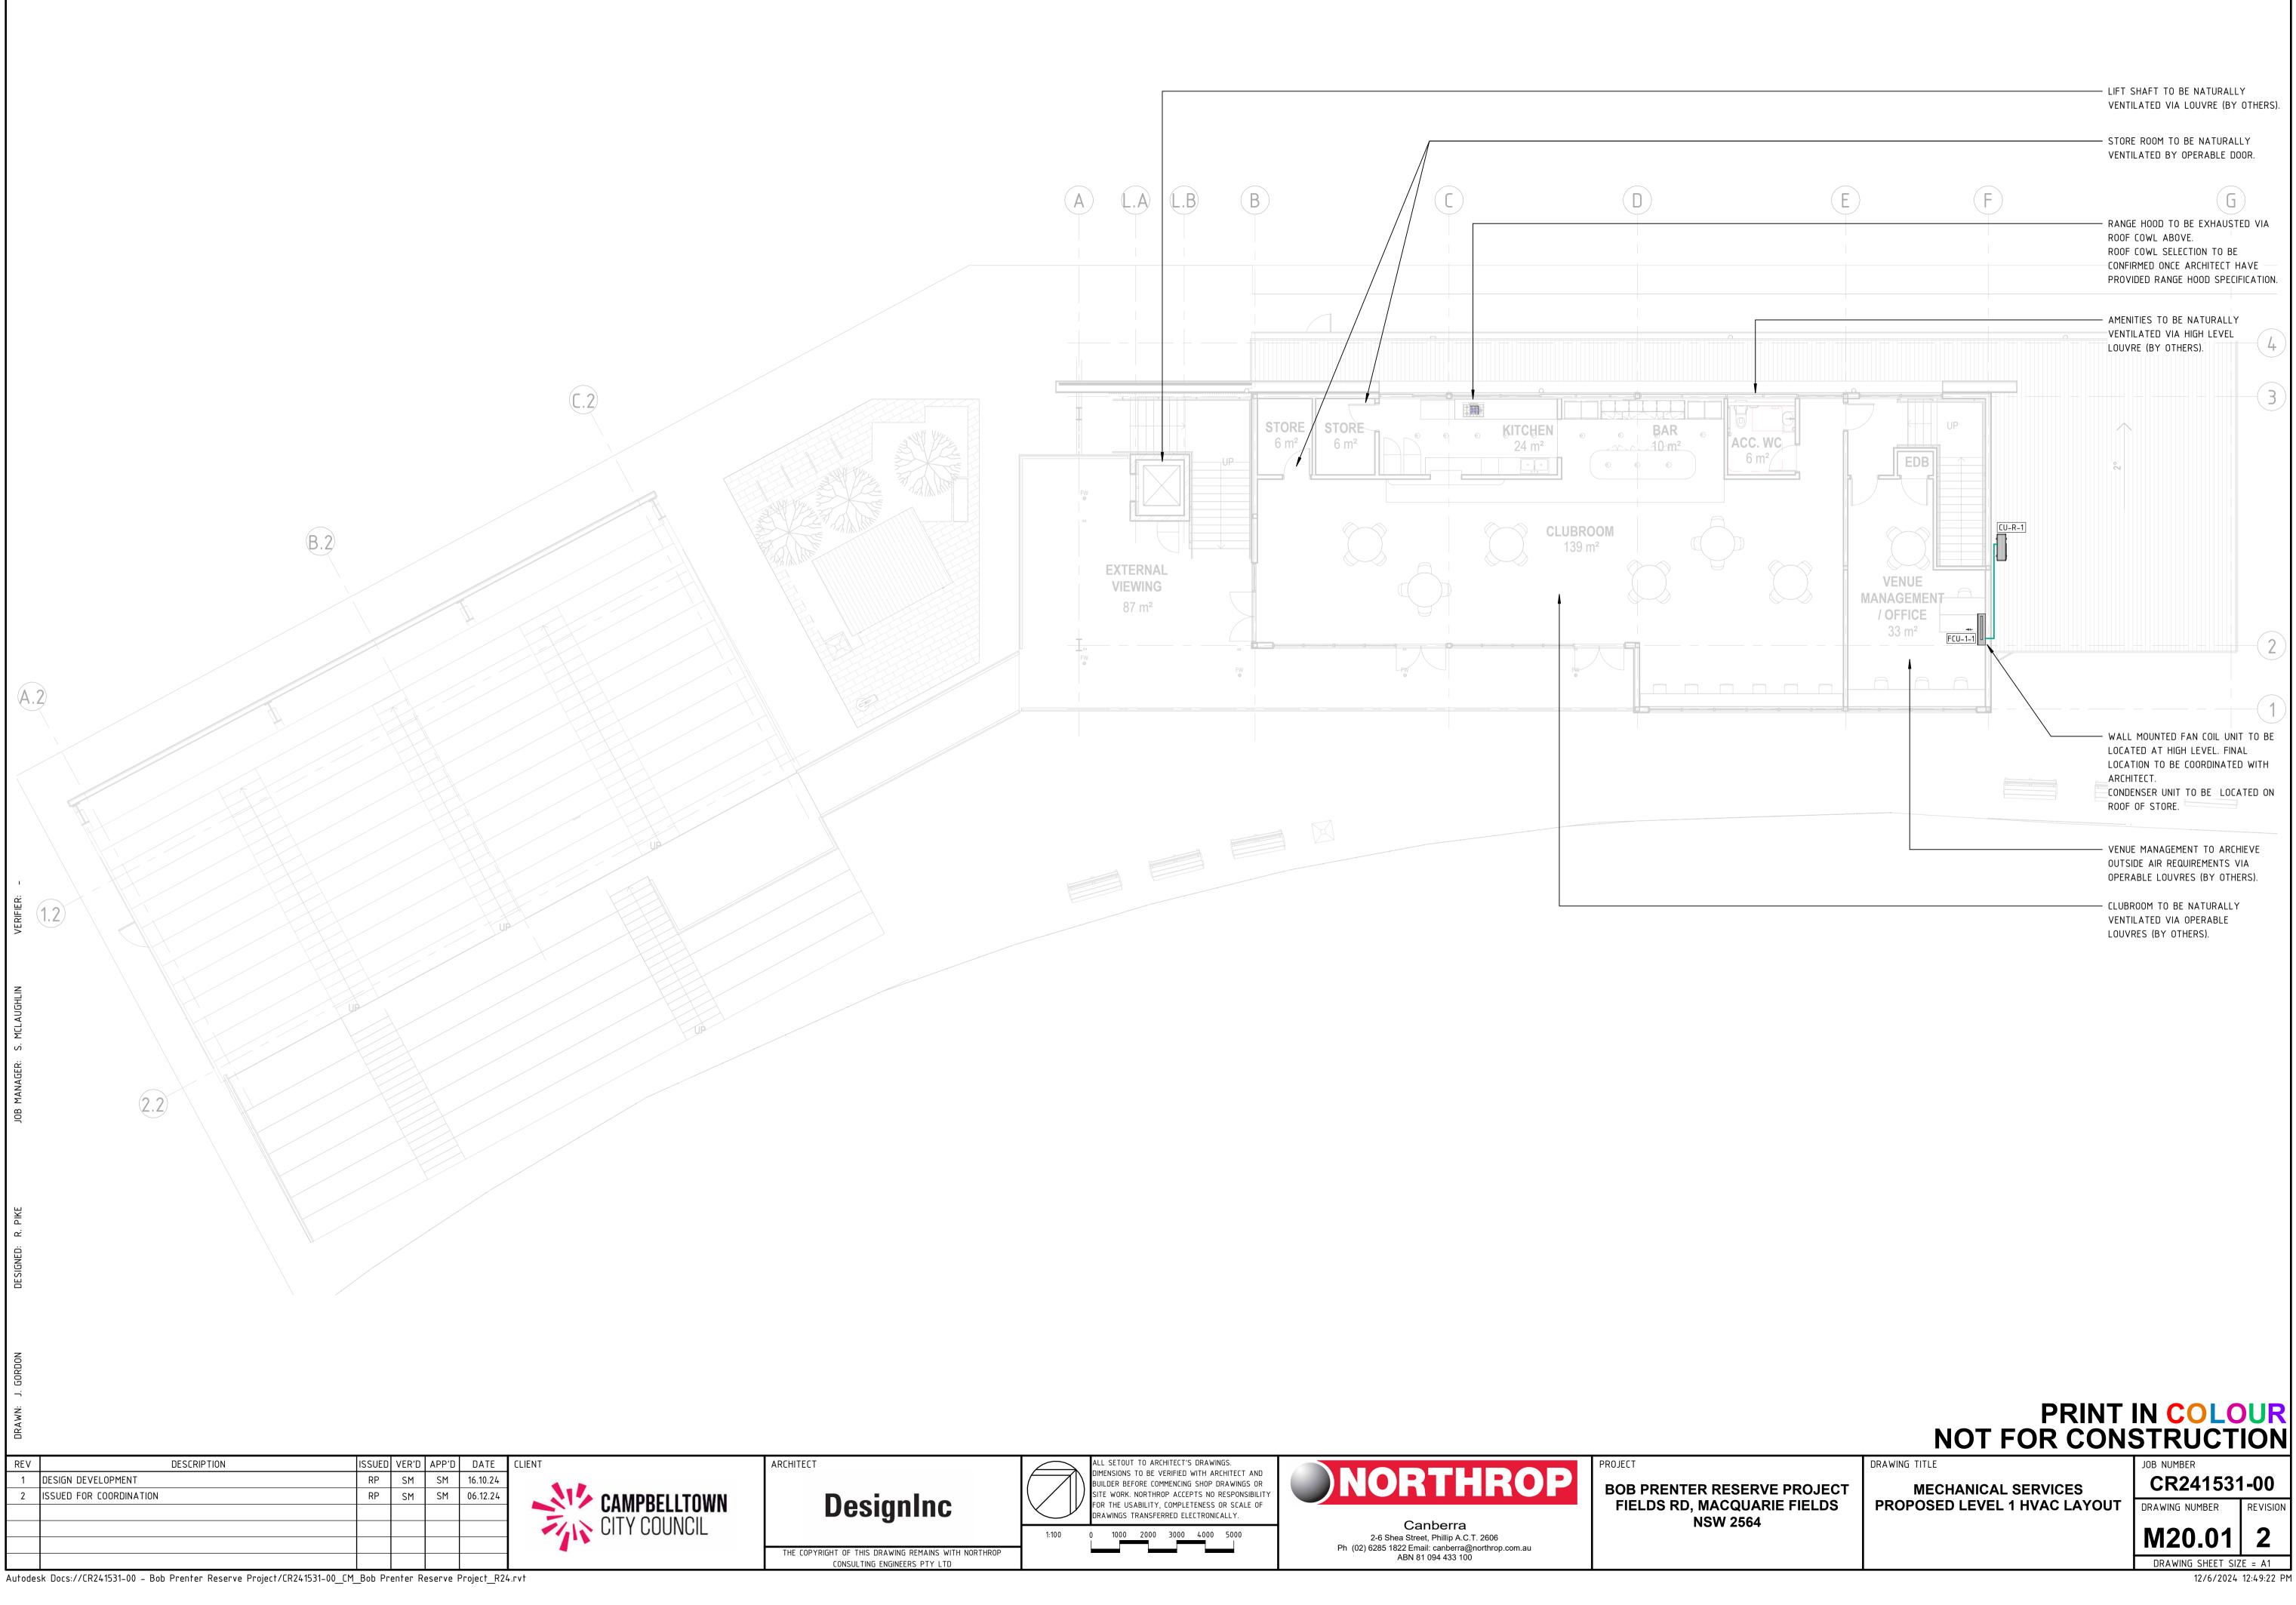
		1			CHEDULE	
		VERTICAL	HORIZO		CONCRETE	
MARK	THICKNESS	REINFORCEMENT	REINFOR	LEMENI	STRENGTH	COMMENTS
BW1	190	N16-200 CENTRAL	N16-400 C	ENTRAL	15 MPa	190 THICK CORE FILLED BLOCKWORK WALL
BW2	190	N16-200 CENTRAL	N16-400 C	ENTRAL	15 MPa	190 THICK CORE FILLED BLOCKWORK WALL. 2400 HIGH
						MAX
CW1	200	N16-200 EACH FACE	N16-200 EA	ACH FACE	40 MPa	200 THICK CONCRETE WALL
LCW1	250	N16-200 EACH FACE	N16-200 EA	ACH FACE	40 MPa	250 THICK CONCRETE LIFT WALLS
		CONCRETE COLUM		IF		
MARK	SIZE	VERTICAL REINFORCEMENT	TIES	CONCRET	E STRENGTH	
CC1	300 DIA	4N16	R10-240	4	0 MPa	

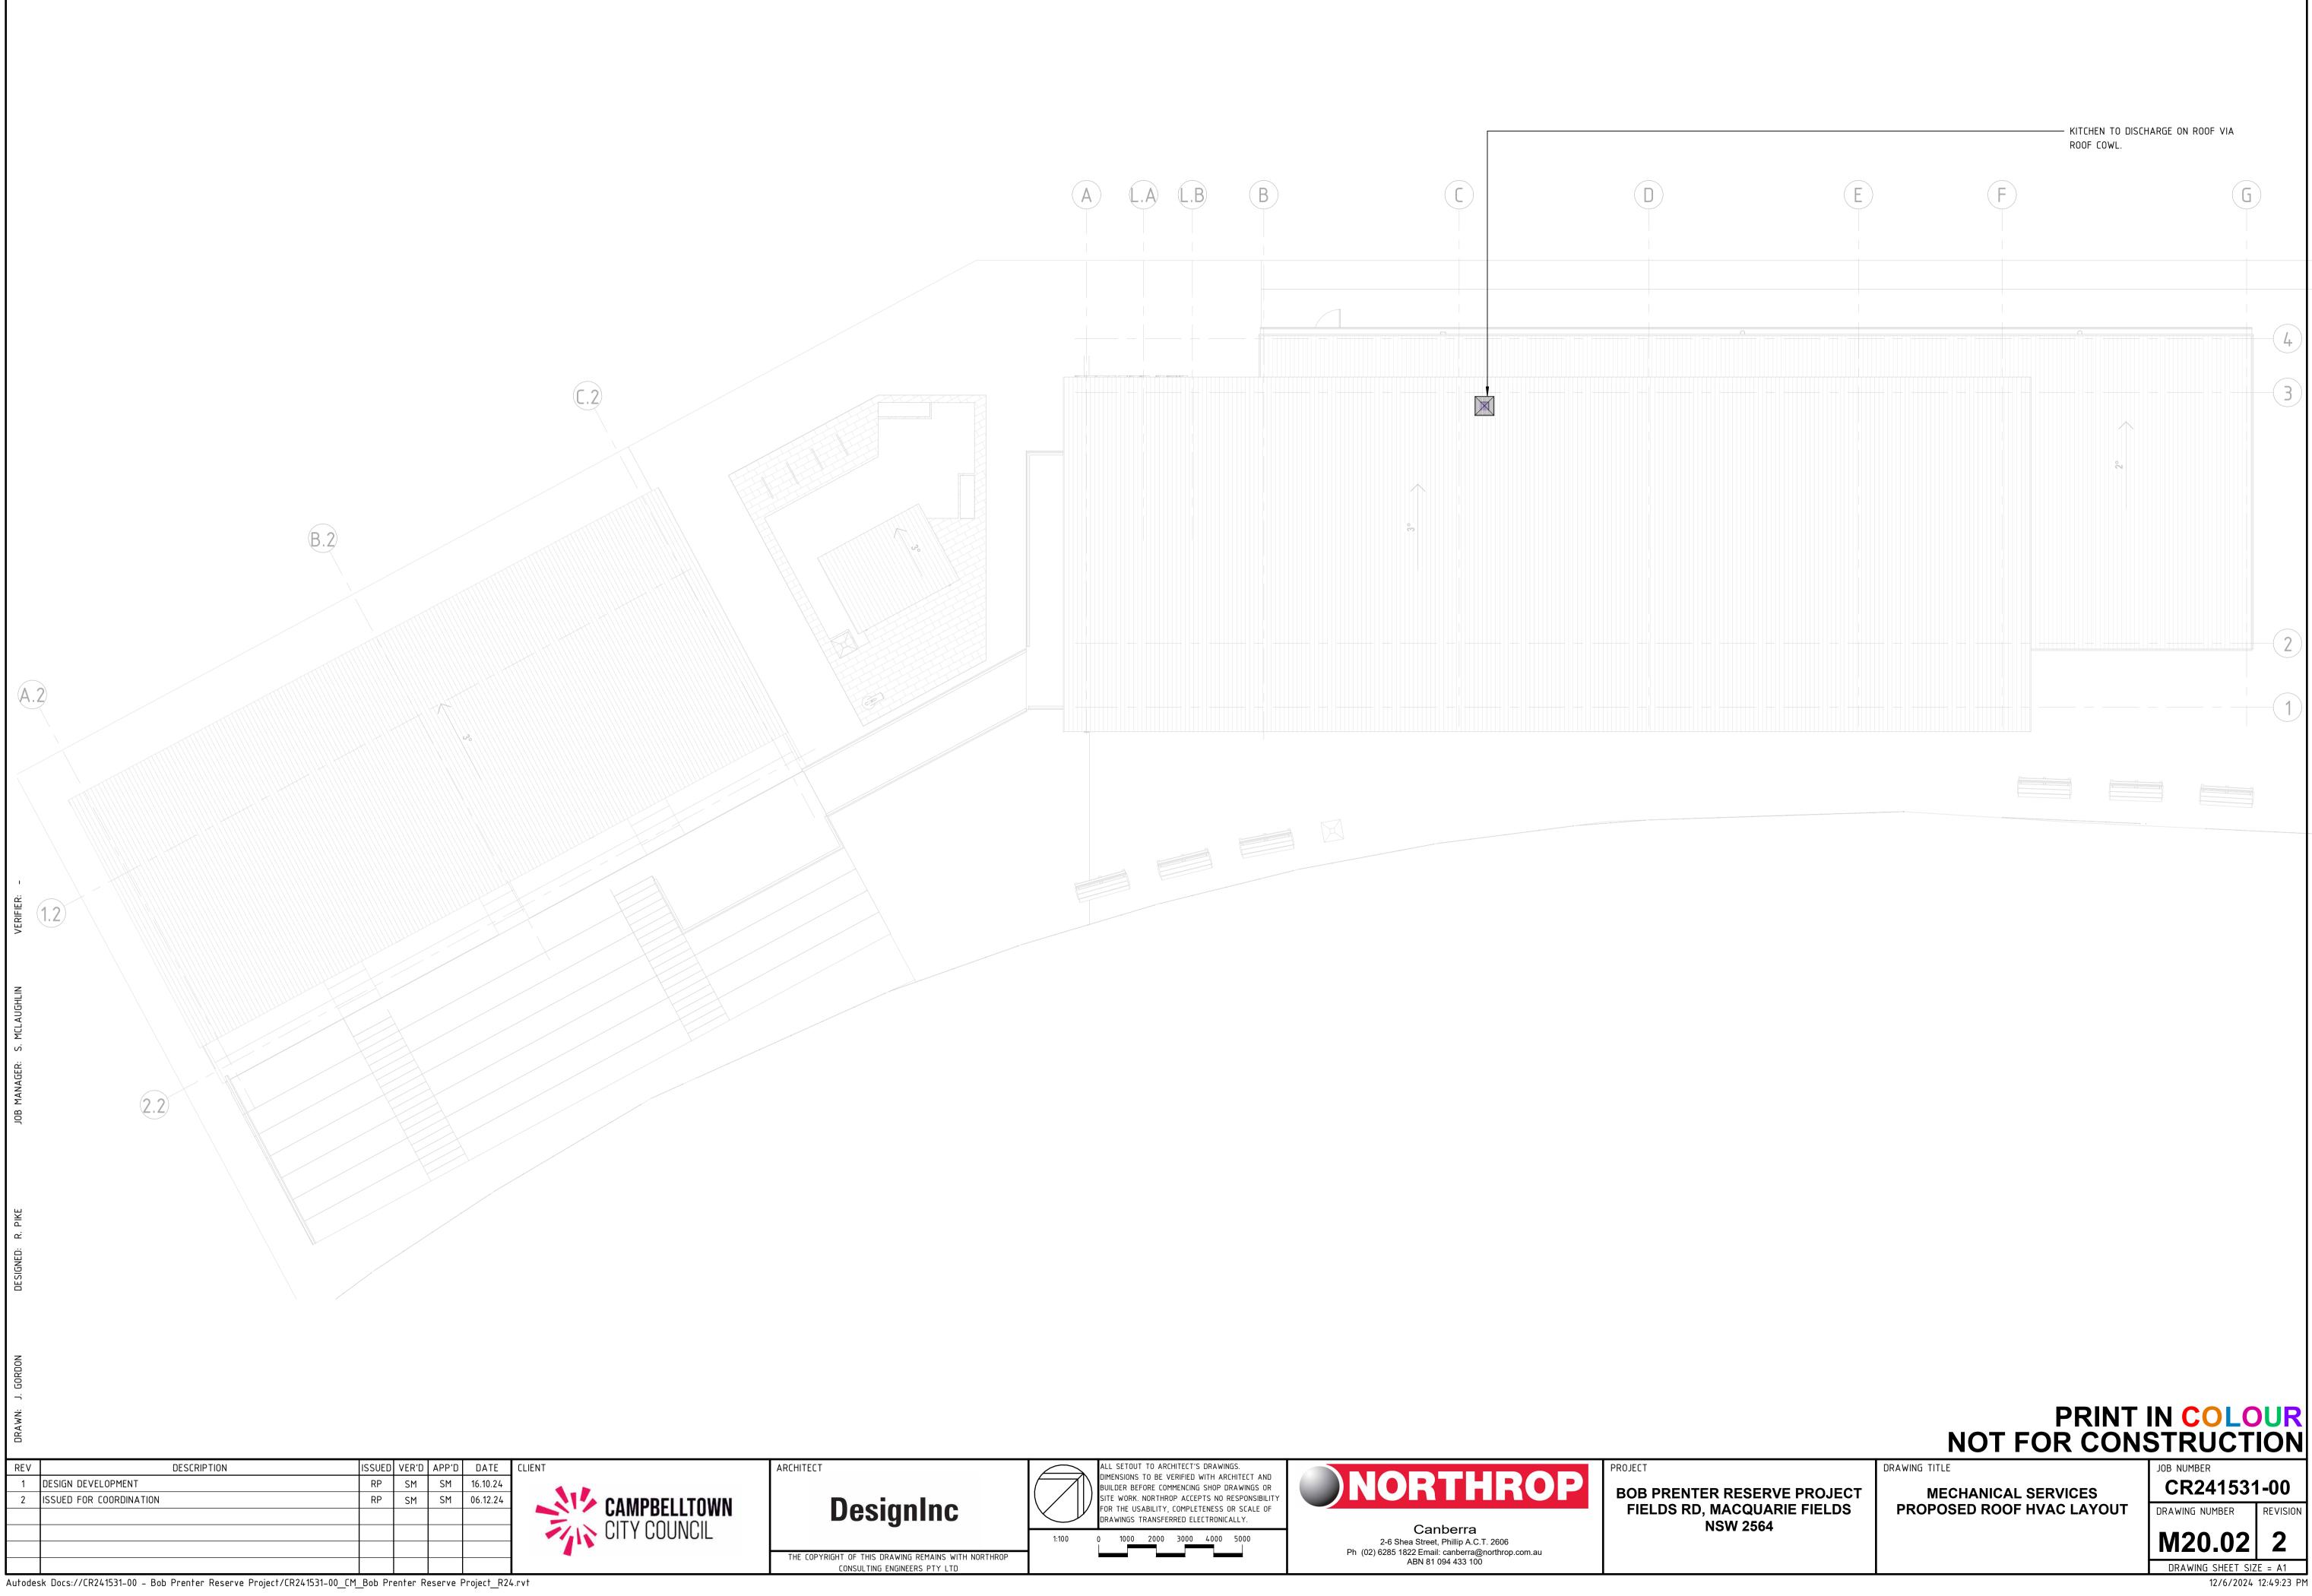
				WALL S	CHEDULE	
MARK	THICKNESS	VERTICAL REINFORCEMENT		HORIZONTAL REINFORCEMENT		COMMENTS
BW1	190	N16-200 CENTRAL	N16-400 CE	ENTRAL	15 MPa	190 THICK CORE FILLED BLOCKWORK WALL
BW2	190	N16-200 CENTRAL	N16-400 CENTRAL		15 MPa	190 THICK CORE FILLED BLOCKWORK WALL. 2400 HIGH MAX
CW1	200	N16-200 EACH FACE	N16-200 EA	N16-200 EACH FACE		200 THICK CONCRETE WALL
LCW1	250	N16-200 EACH FACE	N16-200 EA	N16-200 EACH FACE		250 THICK CONCRETE LIFT WALLS
		CONCRETE COLUM	n schedul	.E		
MARK	SIZE	VERTICAL REINFORCEMENT	TIES	CONCRET	e strength	

MARK	SIZE	COMMENTS					
CLUBROOM E	CLUBROOM BUILDING						
HC1	150 x 150 x 9.0 SHS	HANGING STEEL COLUMN, 150 X 150 X 9 SHS OUTRIGGERS AT 900 CTRS WELDED TO COLUMN					
SC1	150 x 150 x 5.0 SHS	STEEL COLUMN					
SC2	150 x 150 x 9.0 SHS	STEEL COLUMN					
SC3	410 UB 59.7	STEEL COLUMN					
GRANDSTAN	GRANDSTAND BUILDING						
SC4	100 x 100 x 6.0 SHS	STEEL COLUMN					

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	DRAWING TITLE	JOB NUMBER
AMENITY	SLAB ON GROUND PLANS	CR2415
		DRAWING NUMBER
		S100



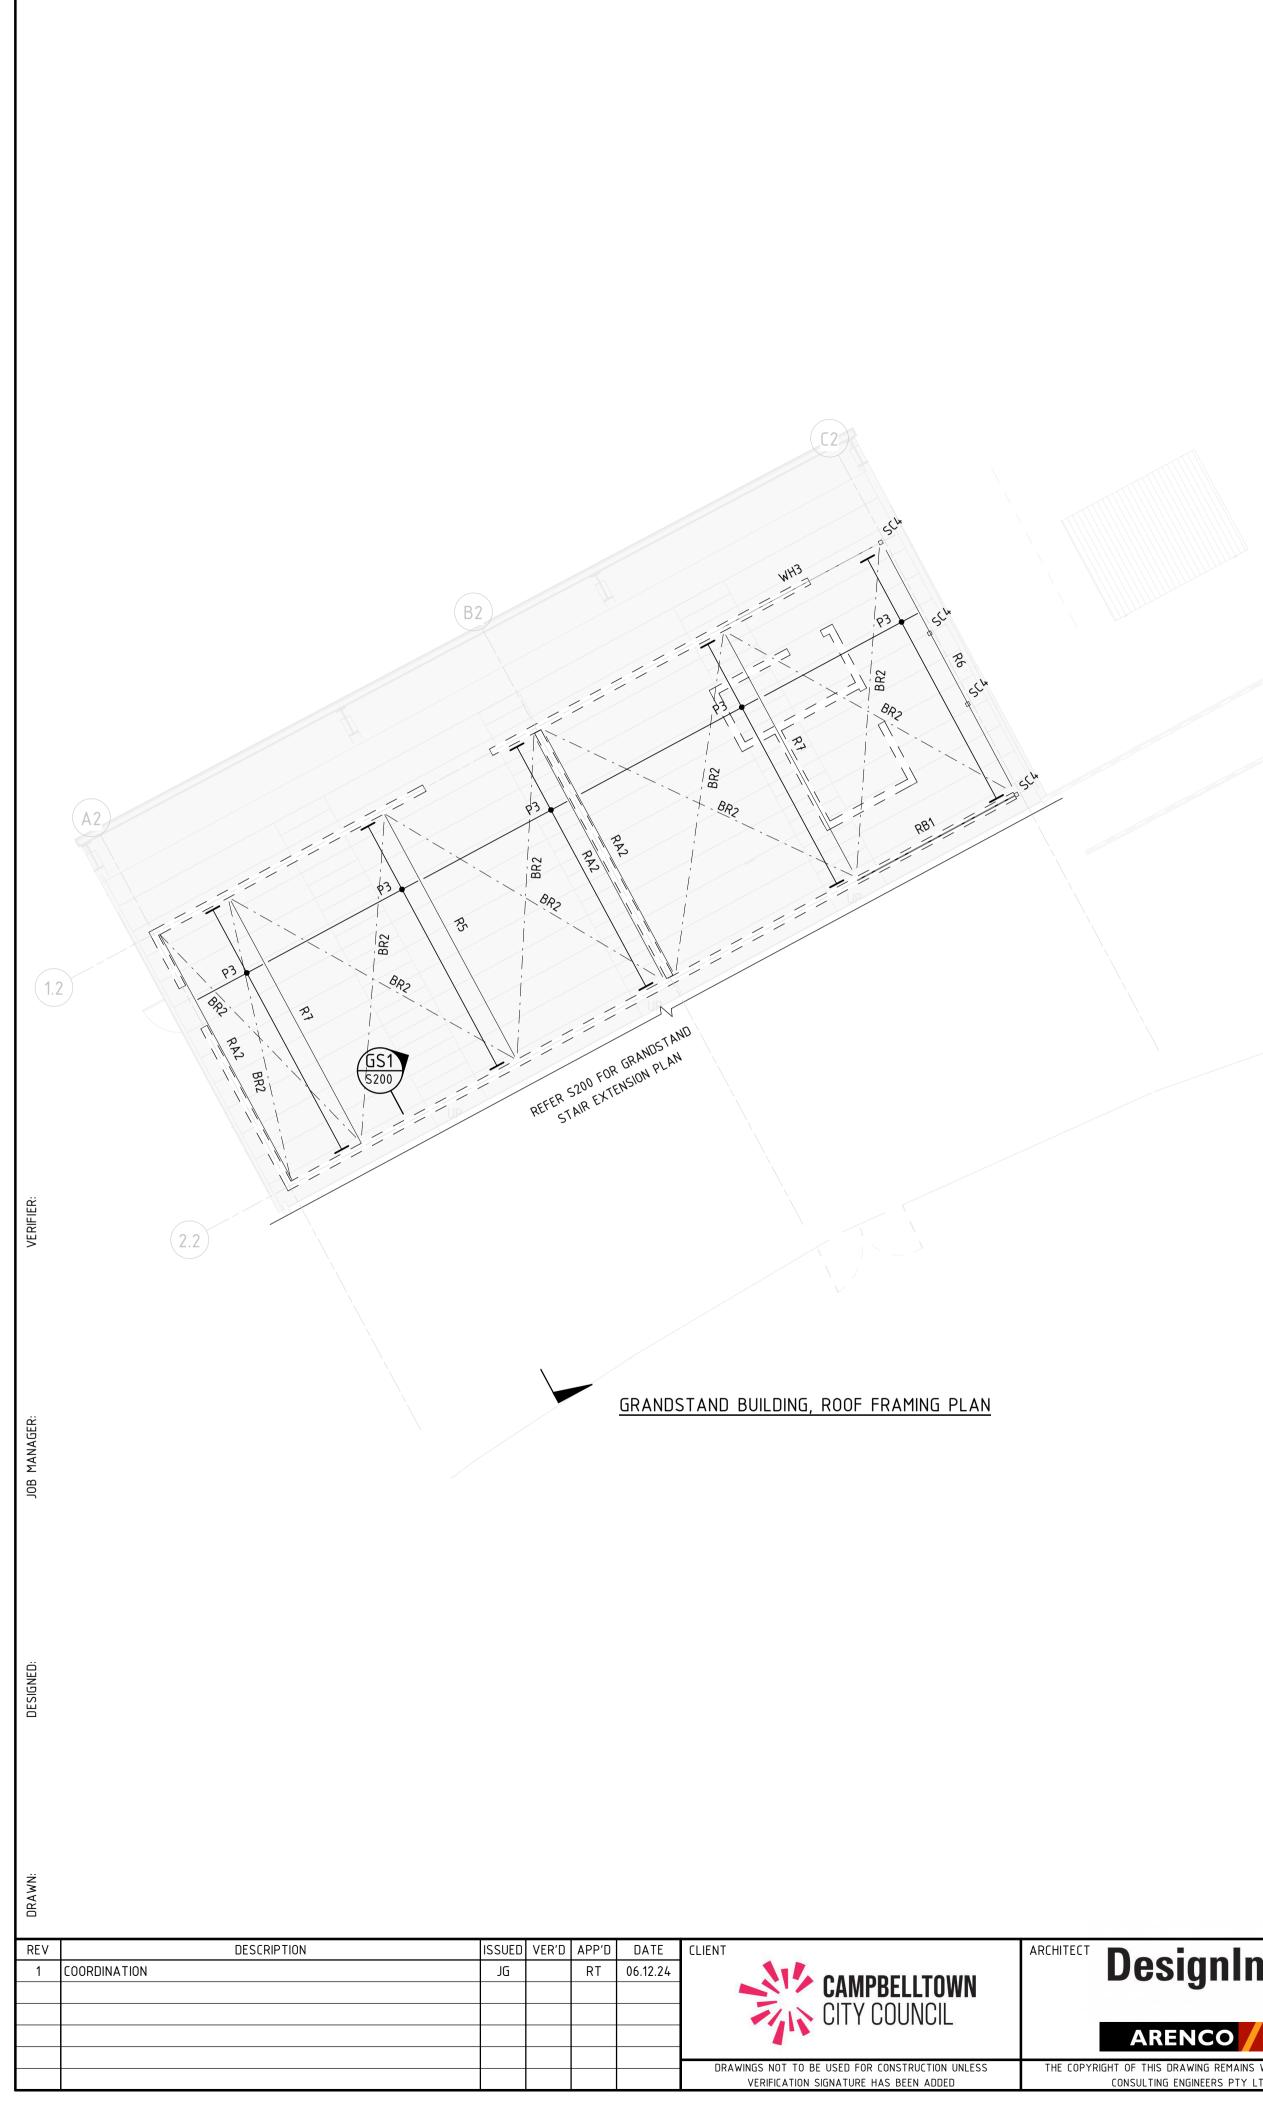
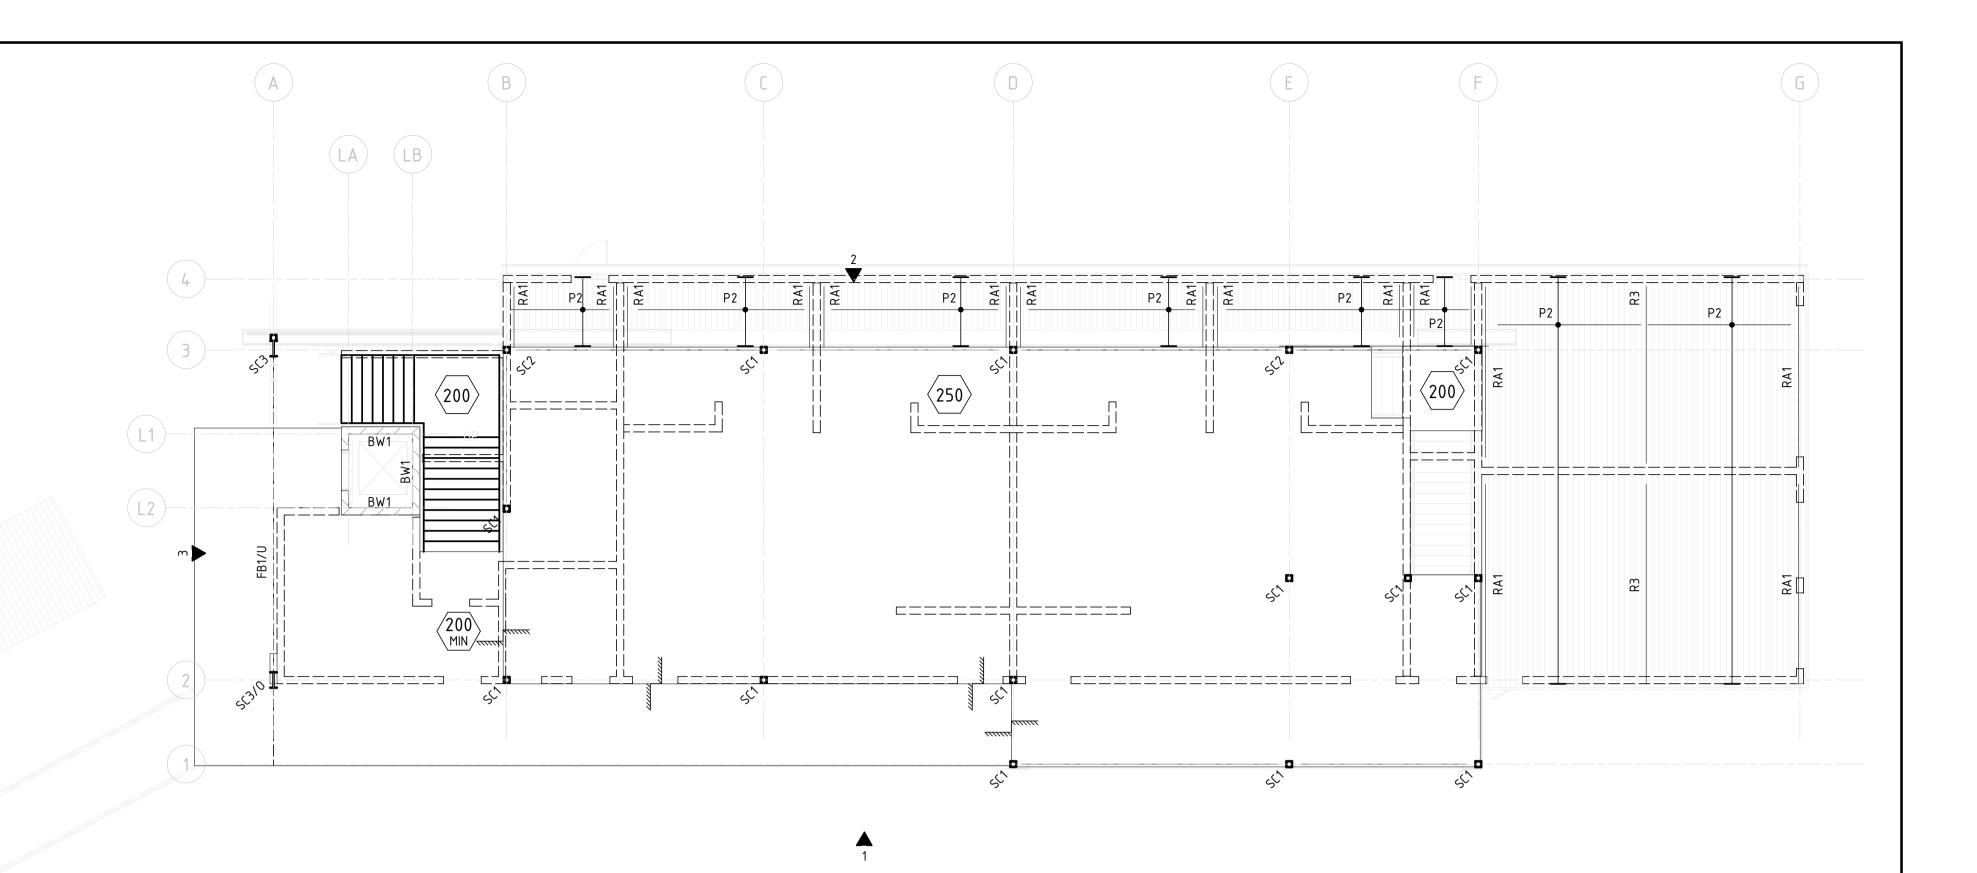
#### CLUBROOM BUILDING, LEVEL 1 SLAB AND LOWER ROOF FRAMING PLAN

			WALL S	SCHEDULE				STEEL C	OLUMN SCHEDULE
		VERTICAL	HORIZONTAL	CONCRETE		MARK	SIZ	Έ	COMMENTS
MARK	THICKNESS	REINFORCEMENT	REINFORCEMENT	STRENGTH	COMMENTS	CLUBROOM	BUILDING		
BW1	190	N16-200 CENTRAL	N16-400 CENTRAL	15 MPa	190 THICK CORE FILLED BLOCKWORK WALL	HC1	150 x 150 x 9.0	) SHS	HANGING STEEL COLUMN, 150 X 150 X 9 SHS
BW2	190	N16-200 CENTRAL	N16-400 CENTRAL	15 MPa	190 THICK CORE FILLED BLOCKWORK WALL. 2400 HIGH				OUTRIGGERS AT 900 CTRS WELDED TO COLUN
					MAX	SC1	150 x 150 x 5.0	) SHS	STEEL COLUMN
CW1	200	N16-200 EACH FACE	N16-200 EACH FACE	40 MPa	200 THICK CONCRETE WALL	SC2	150 x 150 x 9.0	) SHS	STEEL COLUMN
LCW1	250	N16-200 EACH FACE	N16-200 EACH FACE	40 MPa	250 THICK CONCRETE LIFT WALLS	SC3	410 UB 59.7		STEEL COLUMN
						GRANDSTA	ND BUILDING		
						SC4	100 x 100 x 6.0	SHS	STEEL COLUMN
		GR	ANDSTAND BUILDII	NG FRAMING	SCHEDULE				
MARK	SIZ	E		COM	MENTS		Pl	JRLIN AI	ND GIRT SCHEDULE
BR2	30 X 1.0	ROD GALVANISED	STRAP ROOF BRACING				0.75		CONMENTO
R5	200 UB	29.8 RAFTER				MARK	SIZE		COMMENTS
R6	200 F	PFC RAFTER, SITE	WELDED TO SC3, 10 CLEA	AT + 2M20 BOLTS	TO RB1	G1		Z200–19 GIRTS AT 900 CTRS	
R7	200 UB	25.4 RAFTER			P1	EC250–19	PURLINS AT 900 CTRS, 1 ROW OF BRIDGING		
RA2	RA2 100 x 100 x 10 EA RAKED ANGLE, FIXED TO BI		, FIXED TO BLOCKWORK V	DRK WITH M16 HILTI HAS ANCHOR + HILTI HIT RE500 V4 EPOXY AT 900 CTRS,		P2	EC200-15	PU	IRLINS AT 1200 CTRS, 1 ROW OF BRIDGING
		150 EMBEDME	•			P3	EC200–15	PU	IRLINS AT 1200 CTRS, 1 ROW OF BRIDGING
RB1	180 F	FC ROOF BEAM							
WH3	100×100×	6.0SHS WALL HEADE	R BEAM						

		WALL SCHEDU					S	TEEL COLUMN SCHEDULE
		VERTICAL	HORIZONTAL	CONCRETE		MARK	SIZE	COMMENTS
MARK	THICKNESS	REINFORCEMENT	REINFORCEMENT	STRENGTH	COMMENTS	CLUBROOM	BUILDING	
BW1	190	N16-200 CENTRAL	N16-400 CENTRAL	15 MPa	190 THICK CORE FILLED BLOCKWORK WALL	HC1	150 x 150 x 9.0	SHS HANGING STEEL COLUMN, 150 X 150 X 9 SHS
BW2	190	N16-200 CENTRAL	N16-400 CENTRAL	15 MPa	190 THICK CORE FILLED BLOCKWORK WALL. 2400 HIGH			OUTRIGGERS AT 900 CTRS WELDED TO COLUMN
					MAX	SC1	150 x 150 x 5.0	SHS STEEL COLUMN
CW1	200	N16-200 EACH FACE	N16-200 EACH FACE	40 MPa	200 THICK CONCRETE WALL	SC2	150 x 150 x 9.0	SHS STEEL COLUMN
LCW1	250	N16-200 EACH FACE	N16-200 EACH FACE	40 MPa	250 THICK CONCRETE LIFT WALLS	SC3	410 UB 59.7	STEEL COLUMN
						GRANDSTA	ND BUILDING	
						SC4	100 x 100 x 6.0	SHS STEEL COLUMN
		GR	ANDSTAND BUILDIN	NG FRAMING	SCHEDULE			
MARK	SIZ	E		COI	MMENTS		PUI	RLIN AND GIRT SCHEDULE
BR2	30 X 1.0	) ROD GALVANISED	STRAP ROOF BRACING					
R5	200 UB	29.8 RAFTER				MARK	SIZE	COMMENTS
R6	200 F	PFC RAFTER, SITE	WELDED TO SC3, 10 CLEA	T + 2M20 BOLTS	S TO RB1	G1	Z200–19	GIRTS AT 900 CTRS
R7	200 UB	25.4 RAFTER	· · · · · ·			P1	EC250-19	PURLINS AT 900 CTRS, 1 ROW OF BRIDGING
RA2		100 x 100 x 10 EA RAKED ANGLE, FIXED TO BLOCKWORK WITH M16 HILTI HAS ANCHOR + HILTI HIT RE500 V4 EPOXY AT 900 CTRS,		P2	EC200–15	PURLINS AT 1200 CTRS, 1 ROW OF BRIDGING		
		150 EMBEDMENT		P3	EC200–15	PURLINS AT 1200 CTRS, 1 ROW OF BRIDGING		
RB1	180 F	PFC ROOF BEAM						
WH3	100×100×	6.0SHS WALL HEADE	R BEAM			1		

	CLUBROOM BUILDING FRAMING SCHEDULE					
MARK	SIZE	COMMENTS				
BR1	20mm ROD	ROD ROOF CROSS BRACING				
FB1	FB1 410 UB 59.7 FLOOR BEAM, 19mm X 100 HIGH STUDS AT 300 CTRS					
FP1	FP1 EC250–19 FASCIA PURLIN					
OR1	OR1 100x100x6.0SHS OUTRIGGER WELDED TO RAFTER					
R1	250 UB 31.4	RAFTER				
R2	310 UB 40.4	RAFTER, FLY BRACE AT EVERY 2ND PURLIN				
R3	200 UB 18.2	RAFTER				
R4	410 UB 59.7	RAFTER				
RA1	150 x 150 x 10 EA	RAKED ANGLE, FIXED TO BLOCKWORK WITH M16 HILTI HAS ANCHOR + HILTI HIT RE500 V4 EPOXY AT 900 CTRS, 150 EMBEDMENT				
ST1	150x150x5.0SHS	STRUT				
WB1	150x150x5.0SHS	DIAGONAL WALL BRACE				
WH1	150x150x6.0SHS	WALL HEADER BEAM				
WH2	150x150x9.0SHS	WALL HEADER BEAM				

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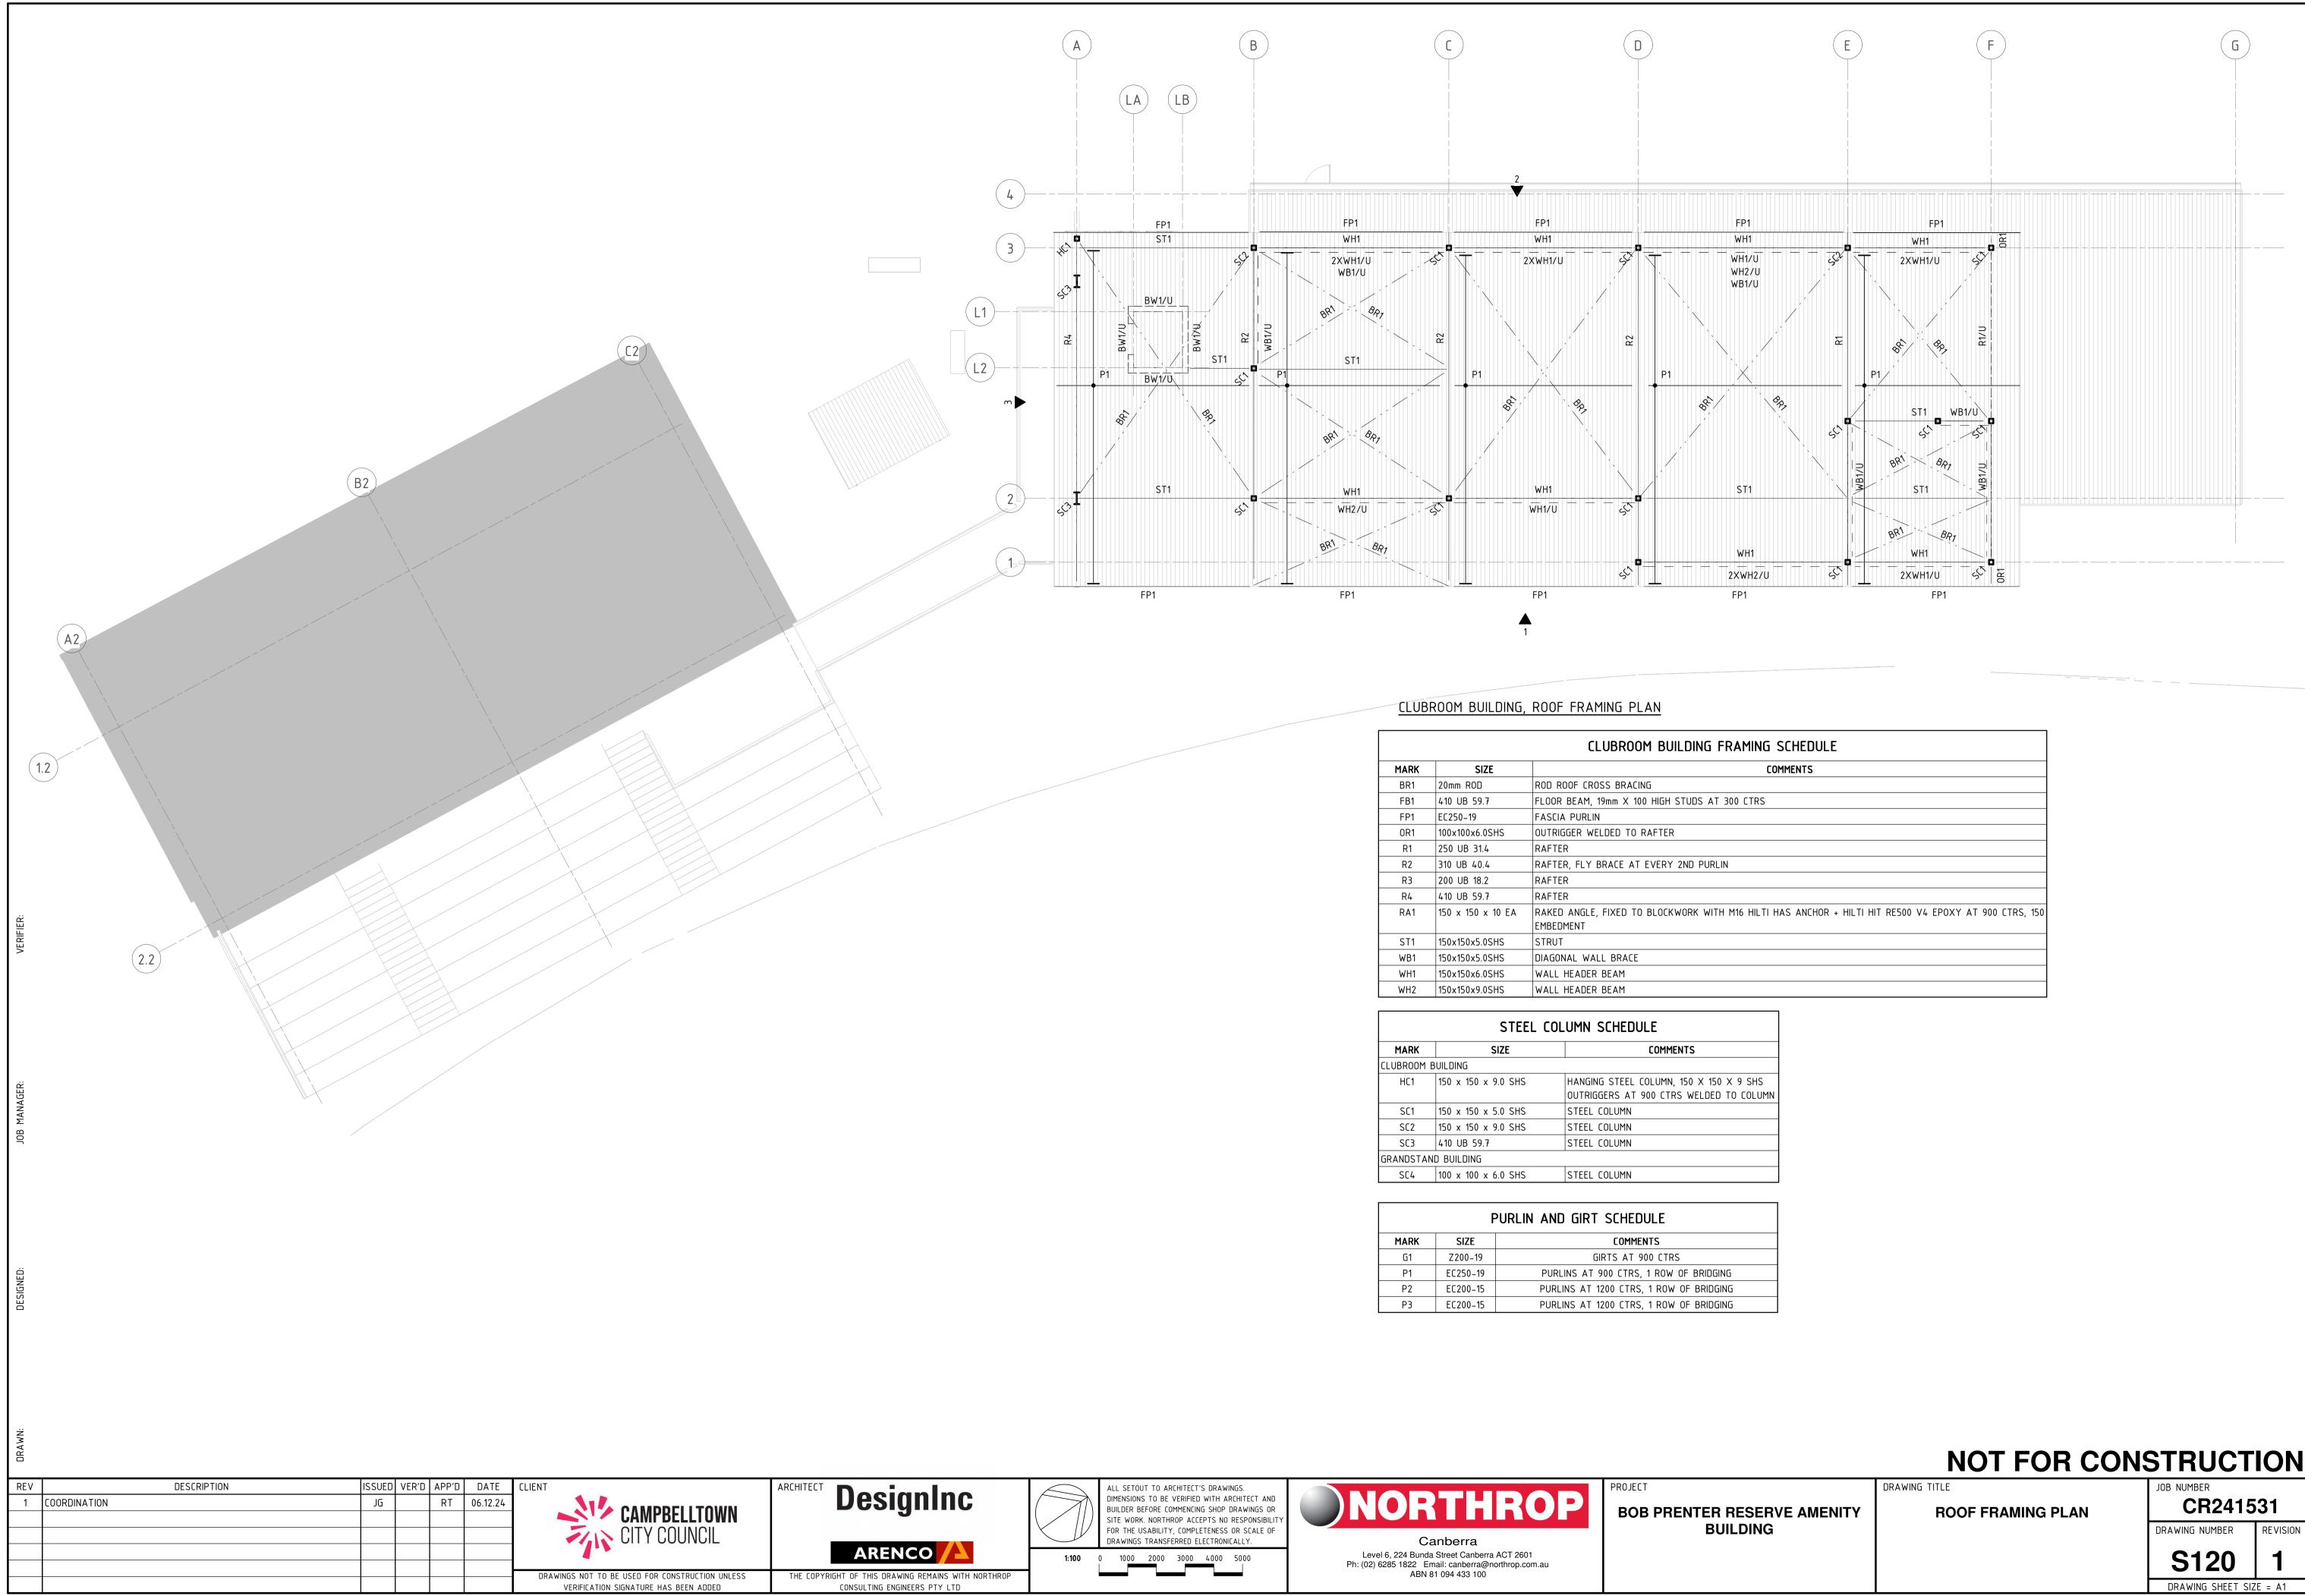
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PROJECT

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RVE AMENITY	DRAWING TITLE LEVEL 1 FRAMING PLAN	JOB NUMBER CR24153			
G		DRAWING NUMBER	REVISION		
		S110	1		
		DRAWING SHEET SIZ	ΖΕ = Α1		




		CLUBROOM BUILDING FRAMING
MARK	SIZE	CC
BR1	20mm ROD	ROD ROOF CROSS BRACING
FB1	410 UB 59.7	FLOOR BEAM, 19mm X 100 HIGH STUDS AT 300 CTRS
FP1	EC250-19	FASCIA PURLIN
OR1	100x100x6.0SHS	OUTRIGGER WELDED TO RAFTER
R1	250 UB 31.4	RAFTER
R2	310 UB 40.4	RAFTER, FLY BRACE AT EVERY 2ND PURLIN
R3	200 UB 18.2	RAFTER
R4	410 UB 59.7	RAFTER
RA1	150 x 150 x 10 EA	RAKED ANGLE, FIXED TO BLOCKWORK WITH M16 HILTI H
ST1	150x150x5.0SHS	STRUT
WB1	150x150x5.0SHS	DIAGONAL WALL BRACE
WH1	150x150x6.0SHS	WALL HEADER BEAM
WH2	150x150x9.0SHS	WALL HEADER BEAM


MARK	SIZE	COMMENTS					
CLUBROOM E	CLUBROOM BUILDING						
HC1	150 x 150 x 9.0 SHS	HANGING STEEL COLUMN, 150 X 150 X 9 SHS OUTRIGGERS AT 900 CTRS WELDED TO COLUMN					
SC1	150 x 150 x 5.0 SHS	STEEL COLUMN					
SC2	150 x 150 x 9.0 SHS	STEEL COLUMN					
SC3	410 UB 59.7	STEEL COLUMN					
GRANDSTAND BUILDING							
SC4	100 x 100 x 6.0 SHS	STEEL COLUMN					

PURLIN AND GIRT SCHEDULE								
MARK SIZE COMMENTS								
G1	Z200-19	GIRTS AT 900 CTRS						
P1	EC250-19	PURLINS AT 900 CTRS, 1 ROW OF BRIDGING						
P2	EC200-15	PURLINS AT 1200 CTRS, 1 ROW OF BRIDGING						
Р3	EC200-15	PURLINS AT 1200 CTRS, 1 ROW OF BRIDGING						

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RVE AMENITY	DRAWING TITLE ROOF FRAMING PLAN	JOB NUMBER CR241531		
G		DRAWING NUMBER	REVISION	
		S120	1	
		DRAWING SHEET SIZ	ZE = A1	



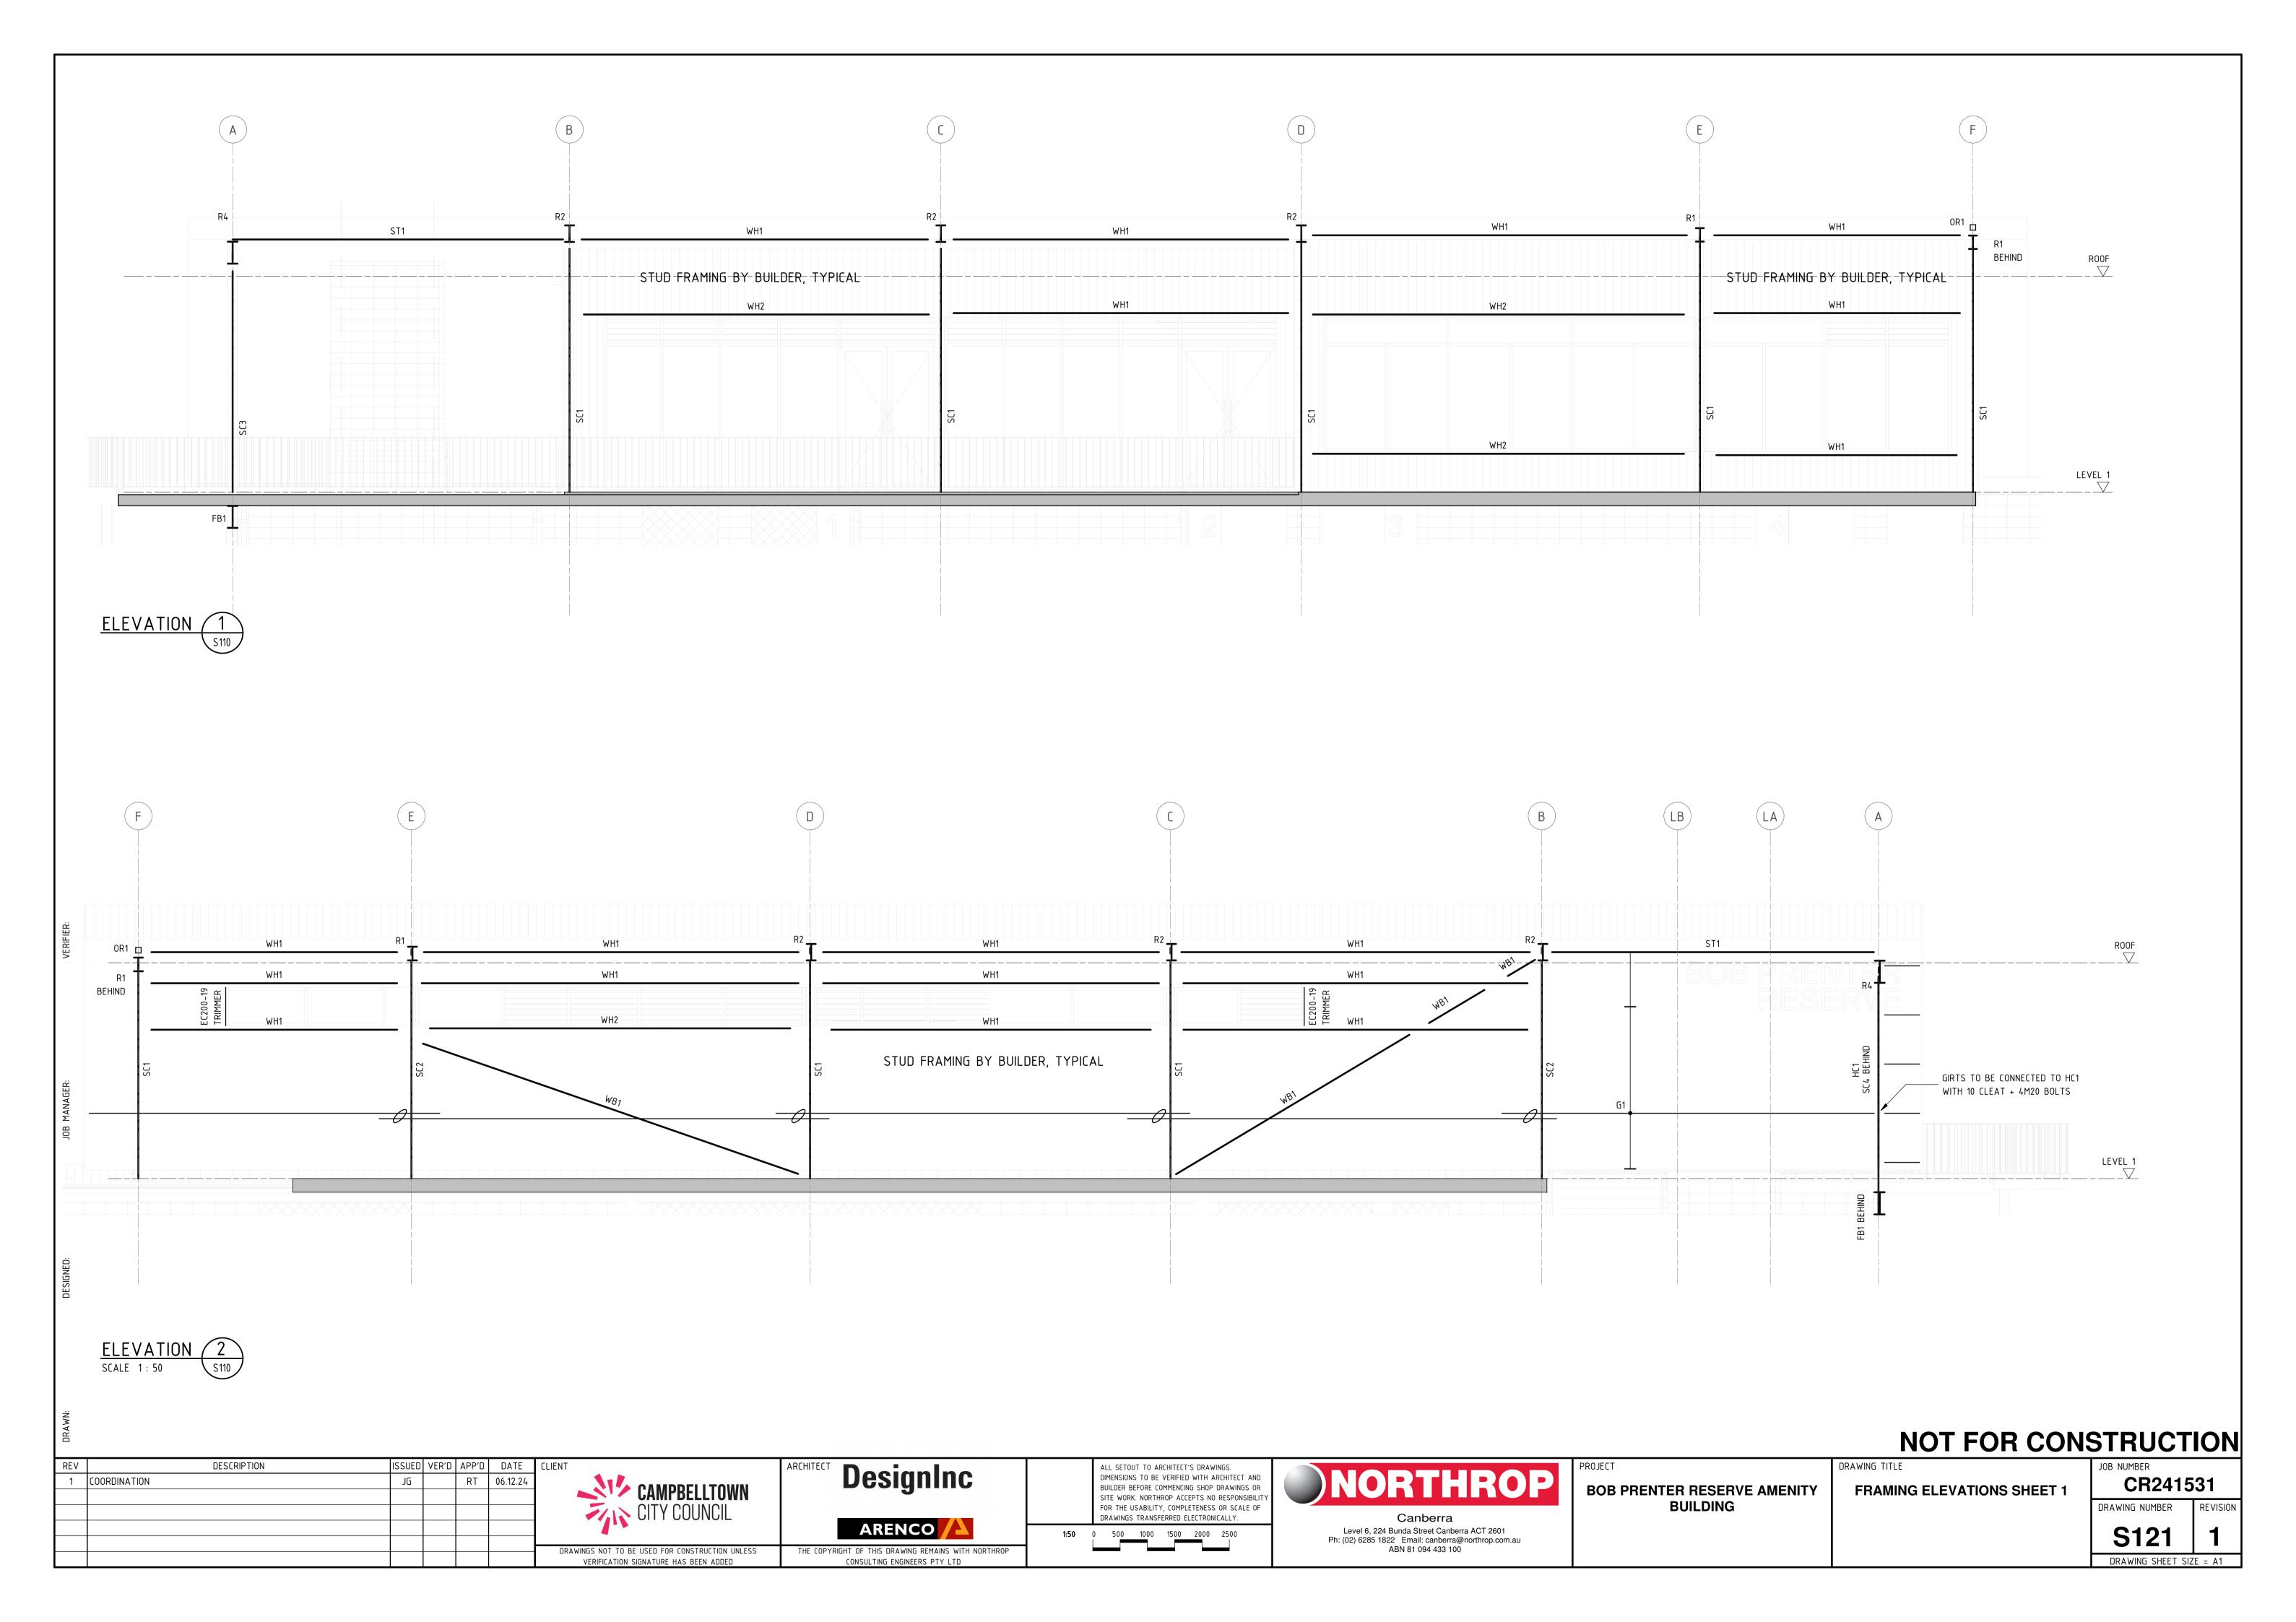
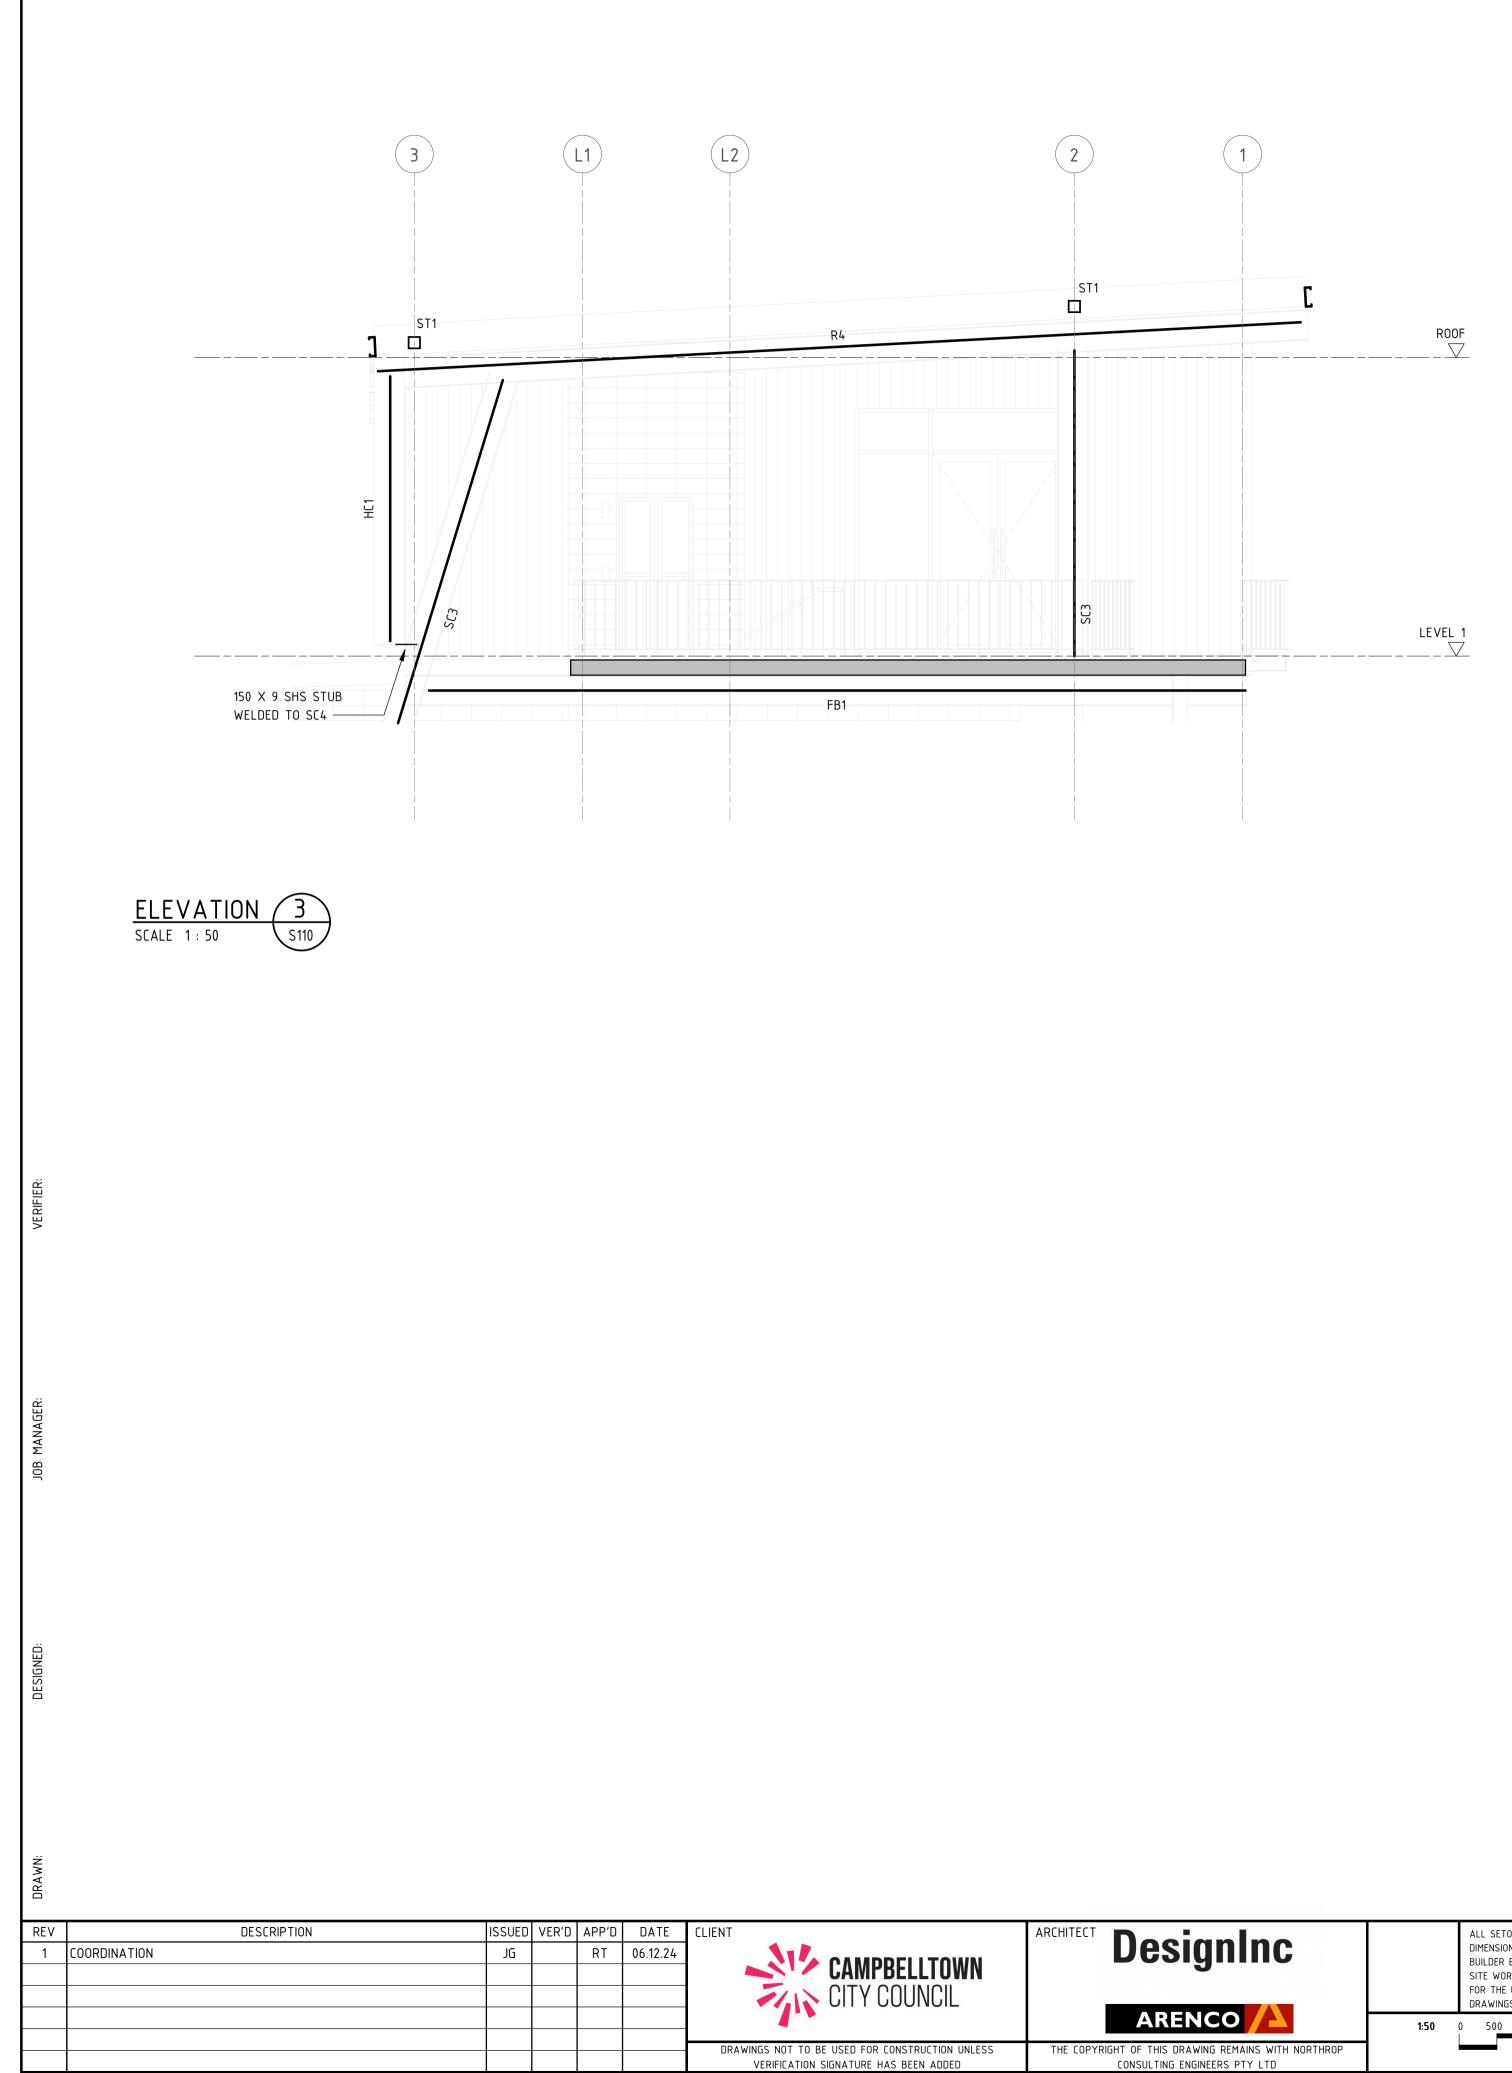
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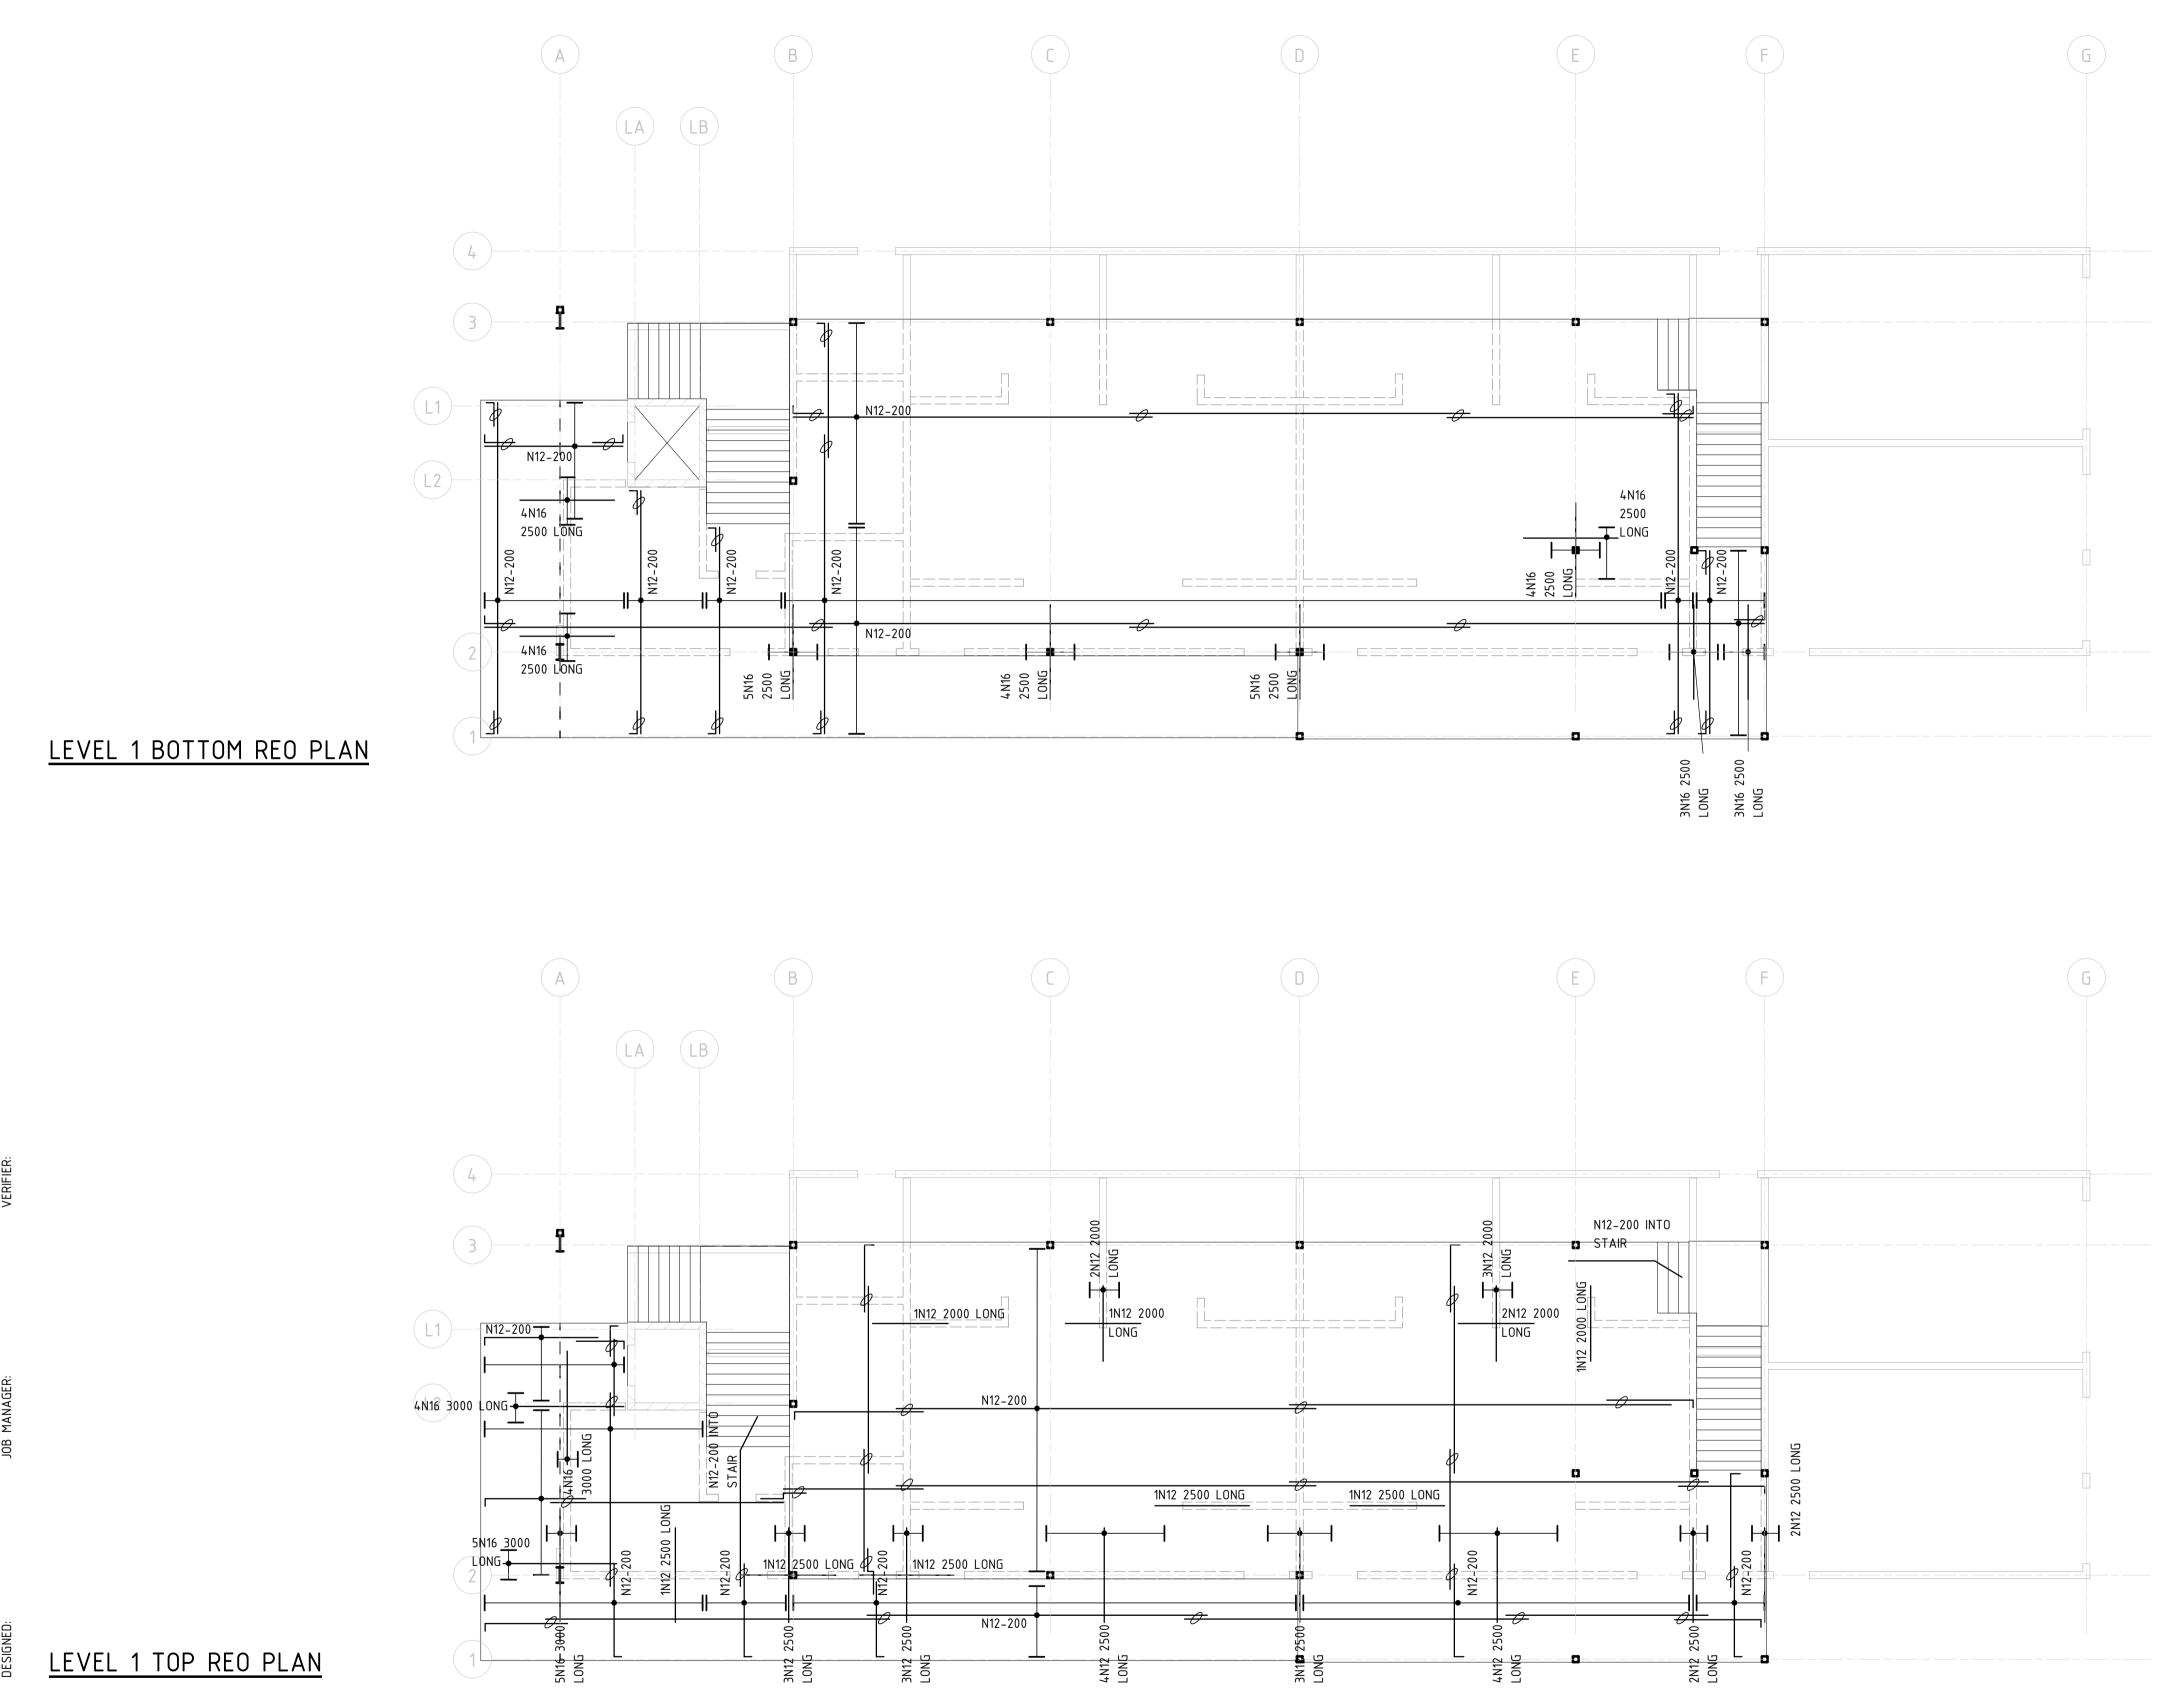


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BOB PRENTER RESERV BUILDING

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VE AMENITY	DRAWING TITLE FRAMING ELEVATIONS SHEET 2	JOB NUMBER CR241531		
		DRAWING NUMBER	REVISION	
		S122	1	
		DRAWING SHEET SIZ	ZE = A1	



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ESIG					
S	LEVEL	1			
ш			IUF	RLU	FLAN
		•			

DRAWN:							
REV	DESCRIPTION	ISSUED	VER'D	APP'D	DATE	CLIENT	
1	COORDINATION	JG		RT	06.12.24		<b>DesignInc</b>
						CAMPBELLTOWN	5
						CITY COUNCIL	
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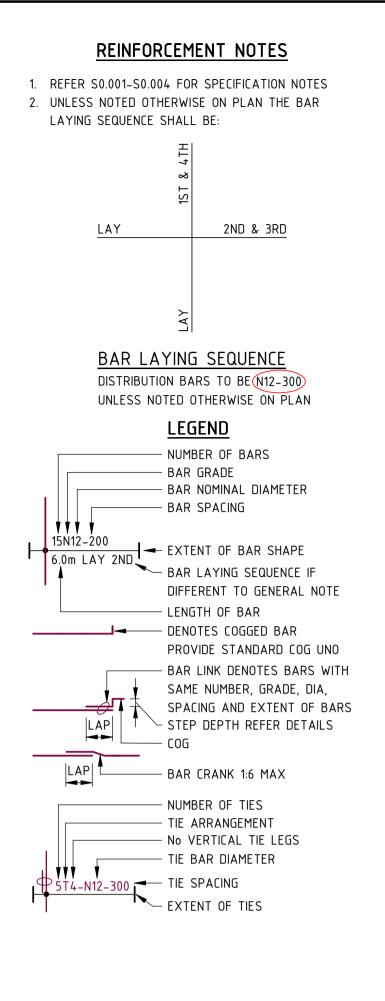


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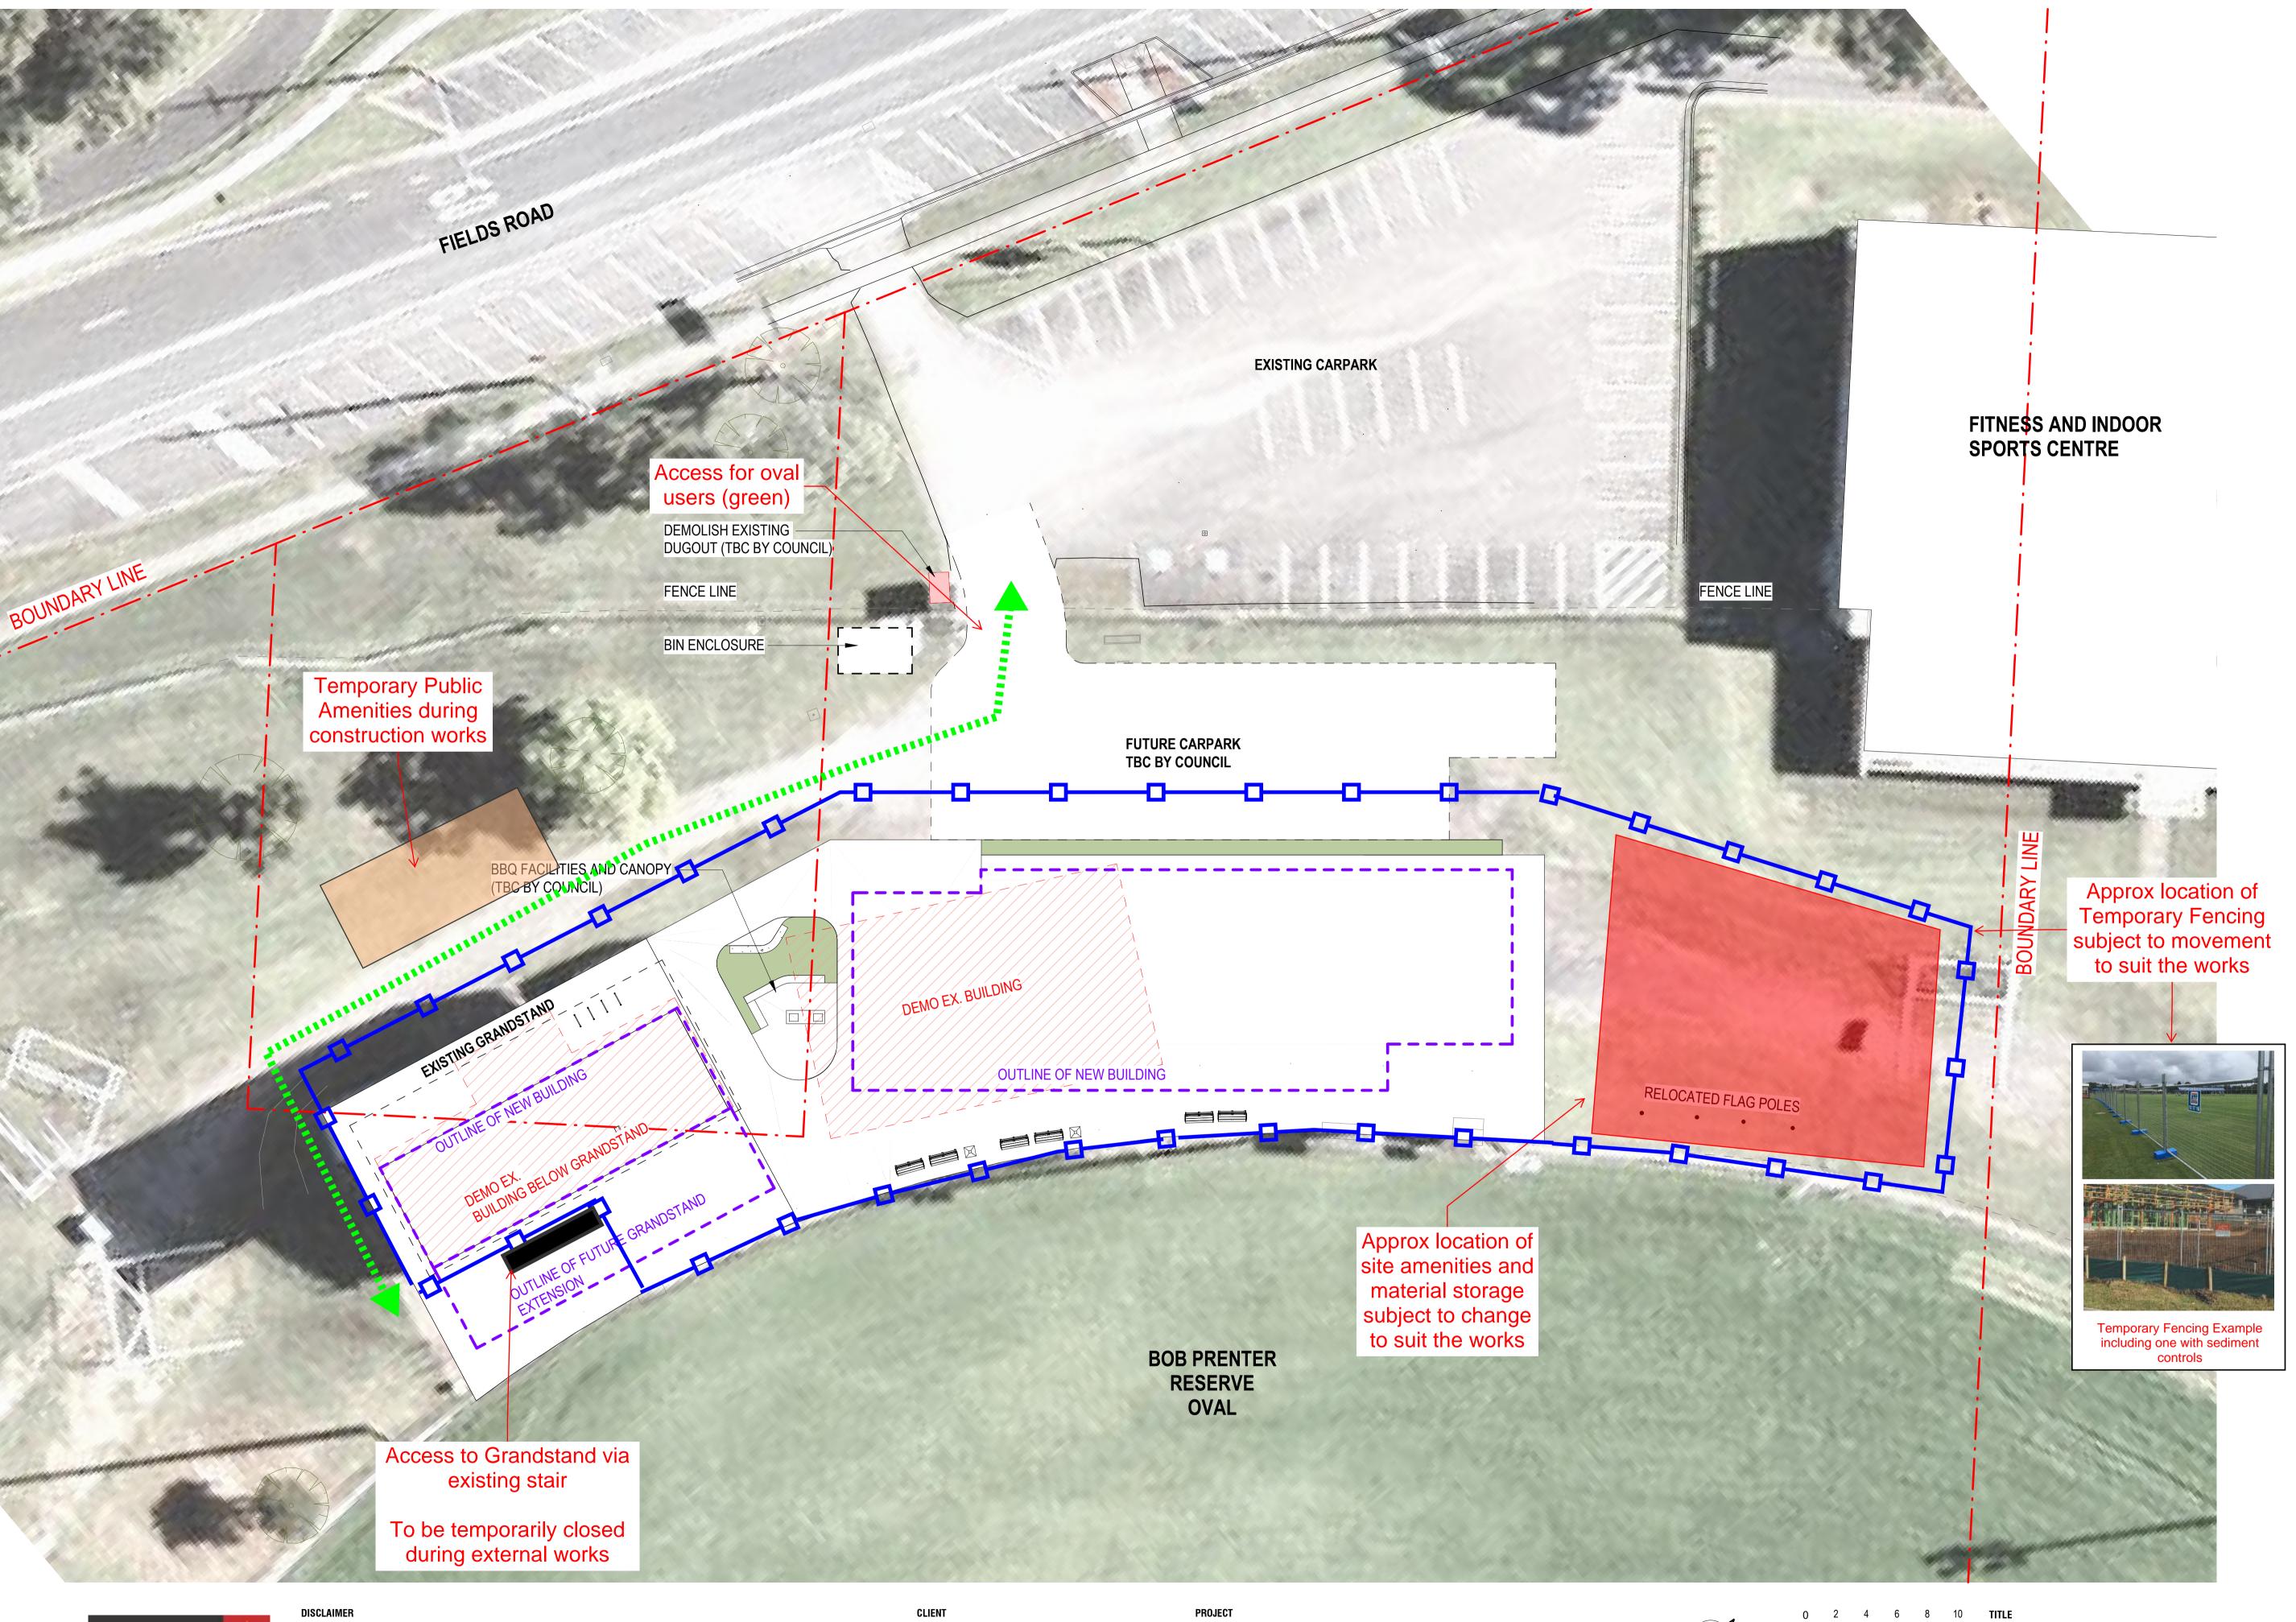


### **NOT FOR CONSTRUCTION** DRAWING TITLE

|--|

LEVEL 1 TOP AND BOTTOM **REINFORCEMENT PLAN** 

JOB NUMBER						
CR241531						
DRAWING NUMBER	REVISION					
S130 1						
DRAWING SHEET SIZE = A1						



# DesignInc

**Nominated Architects** 

lan Armstrong

Cameron Martin



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7260 Cathryn Drew-Bredin 7269 9194 Mary Anne McGirr 10946




## PROJECT BOB PRENTER RESERVE **AMENITY BUILDING**

PROJECT ADDRESS Fields Rd, Macquarie Fields NSW 2564

A 25.10.24 CONCEPT DESIGN DATE REVISIONS No



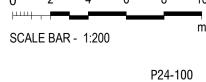

CHECKED BY MW ISSUE DATE 24/09/24

CONCEPT DESIGN

1 : 200 @ A1

**CONCEPT SITE PLAN** 

DRAWING NO. SK-001

